The Residences at South Boulevard

715-717 South Boulevard Oak Park, Illinois 60302

Issued for Plan Development September 14, 2016 September 30, 2016 rev. October 4, 2016 rev. November 29, 2016 rev.



PD Application Item 1

PETITION FOR PUBLIC HEARING LEGAL DESCRIPTION + PROOF OF OWNERSHIP

The Applicant has appeared before the Historic Preservation Commission on June 9,2016. Subsequently, the applicant has received a Certificate of Advisory Review dated June 20, 2016. Please see attached certificate.



Petition for Public Hearing

Planned Development Application MINOR [10-30K] MAJOR [>30K]	
YOU MUST PROVIDE THE FOLLOWING INFORMATION: IF ADDITIONAL SPACE IS NEEDED, ATTACH EXTRA PAGES TO THE PETITION.	
Address/Location of Property in Question: 715-717 S. BOULEVARIO	
Property Identification Number(s)(PIN): 16-07-400-025-0000 \$ 16-07-400-026-	0000
Name of Property Owner(s): 717 SOUTH BOYUEVARD, LLC.	
Address of Property Owner(s): 3528 WALMUT AVE WILMETTE IL. G	009
If Land Trust, name(s) of all beneficial owners: (A Certificate of Trust must be filed.)	
Name of Applicant(s): JOHN C. SCHUESS Applicant's Address: 400 ASHUAND AVE. RIVER FOREST, IL GO Applicant's Phone Number: Office 708-366-1500 E-Mail_JOHN @JCSARGHITECT.	0309 0309
Other:	
Project Contact: (if Different than Applicant) SAME AS APPLICANT Contact's Address:	-
Contact's Phone Number: Office E-Mail	
Other:	
Property Interest of Applicant:OwnerOtherOther (Describe):OwnerOther	
Existing Zoning: B-1/B-2 Describe Proposal: Construct Five Story Mixed use Building - O'NE commor can space + 20 INTERIOR PARKING + 14 PESIDENTITULU	25
	_

Zoning Category R	Requested: (Circle C	ne if Applicable) or NA (Not Applic	able)		
R-1	R-2	R-3	R-4	R-5	R-6	R-7
B-1	B-2	B-3	B-4	С	Н	PD
Planned Developm	nent Requested: (Ci	rcle One if Appl	icable) or NA (Not	Applicable)		
ResPD	Bus	PD	ComPD	(N	IIX)	
Size of Parcel (from	n Plat of Survey):	9,000		Square Feet or A	cre (circle one)	
ATTACH LEGAL D	ESCRIPTION OF A	LL APPLICABL	E PROPERTY AS	IT APPEARS ON	THE DEED.	
Adjacent Zoning D	istricts and Land U	ses:				
To the Nort	th: 13-3	_	CENTER	- Busin	555	
To the Sou	th: B-1/B-2	6	SENETRAL	BUSINE	53	
To the Eas	t B-1/8-2		SENIORAL	BUSING	55	
To the Wes	st: B-1/8-2	- 1	EENERAL	Busing	5-6	
How the property is	n question is curre	ntly improved?	(Circle One)			
COMMER	CIAL/BUSINESS	RESIDENT	TIAL MIXED	USE 0	THER:	
Describe In	mprovement:	VACA	M MM	use u	70	
Is the property in q		n violation of the	he Zoning Ordinan	ce?Yes	<u></u> No	
ii res, now						
Is the property in q	uestion presently	subject to a Sn	ecial Use or Plann	ed Developmen	to Yes X	No
	?					
	se provide Ordinano					
Is the subject prop	erty located within	any Historic D	istrict? X Yes	s No		
	ch district:				Gunderson	
Is the subject prop	erty located within	the Transit Ov	erlay District?	Yes X N	0	
	erty located within					

Explain why, in your opinion, the grant of this request will be in harmony with the neighborhood and not contrary to the intent and purpose of the Zoning Ordinance or Comprehensive Plan.
A MIXED USE DEVELOPMENT ON THIS PARCEL
15 M HARMONY WITH SUKKOUNDING USES +
IN REDUING WITH SCALE + DEMSITY POPONTIAL
I (we) certify that all the above statements and the statements contained in any papers or plans submitted herewith are true to the best of my (our) knowledge and belief.
I (we) consent to the entry in or upon the premises described in this application by any authorized official of the Village of Oak Park for the purpose of securing information, posting, maintaining and removing such notices as may be required by law. Owner's signature must be notarized.
(Signature) Applicant Date
(Signature) Owner Date
Owner's Signature must be notarized
SUBSCRIBED AND SWORN TO BEFORE ME THIS
13 DAY OF NOV. 15
Official Seal Manuel M Ganaden Notary Public State of Illinois My Commission Expires 10/01/2016
(Notary Public)

Petition for Public Hearing Page 3 of 3

From what Section(s) of the Zoning Ordinance are you requesting approval / relief?

SECTION 3.8.1-A.1.6

SECTION 3.8.1-A.2 (HEIGHT)

August 2014

at 154, 125759 15 &WC

SPECIAL WARRANTY DEED
ILLINOIS STATUTORY

Karen A.Yarbrough Cook County Recorder of Deeds Date: 07/29/2015 09:58 AM Pg: 1 of 3

THE GRANTOR(S), Forest Park National Bank & Trust Co., of the Village of Forest Park, County of Cook, State of Illinois for and in consideration of TEN & 00/100 DOLLARS, and other good and valuable consideration in hand paid, CONVEY(S) and Warrant(s) to 717 South Boulevard LLC (GRANTEE'S ADDRESS) 3528 Walnut, Wilmette, Illinois 60091 of the County of Cook, all interest in the following described Real Estate situated in the County of Cook in the State of Illinois, to wit:

SEE LEGAL DESCRIPTION ATTACHED HERETO AND INCORPORATED HEREIN

SUBJECT TO: covenants, conditions and restrictions of record, private, public and utility easements and roads and highways, any confirmed special tax or assessment, installments not due at the date hereof of any special tax or assessment for improvements heretofore below

Seller makes no representations or warranties, of any kind or nature whatsoever, other than those set out above, whether express, implied, implied by law, or otherwise, concerning the condition of the title of the property prior to the date the Seller acquired title.

hereby releasing and waiving all rights under and by virtue of the Homestead Exemption Laws of the State of Illinois.

Permanent Real Estate Index Number(s): 16-07-400-025-0000, 16-07-400-026-0000 Address(es) of Real Estate: 715-717 South Blvd., Oak Park, Illinois 60302

Forest Park National Bank & Trust Co.

Dated this 21 day of March

John A. Vainisi

Executive Vice President

Attest Imm Mence

BOX 333-CT

Oak Park

REAL SETUTE TRANSFER TAX 032 LD00

S N SC X

I, the undersigned, a Notary Pu personally known to me to be the me this day in person, and ackno act, for the uses and purposes the	blic in and for said C same person(s) who wledged that he signe	ounty, in the se name(s) ed, sealed a	is subscribed to ad delivered the	the foregoing instrument, said instrument as his fre	appeared before
Given under my hand and officia				2015	
NOTARY PUBLI	CIAL SEAL , ROZMUS C-STATE OF LLINO'S DN EXPIRES 11/29"5	Ju	16	_(Notary Public)	
Prepared By: Genevieve Hall 30 Gale Avenue River Forest, Illinois, 6					
Mail To: Rick J. Erickson 717 Sou 716 Lee Street 35 28 Des Plaines, Illinois 60016	H BIVD LLC Walnut Wilmette, I				

60091

Name & Address of Taxpayer: 717 South Boulevard LLC 3528 Walnut Wilmette, Illinois 60091

COUNTY: 202 50
COUNTY: 202 50
4LLINOIS: 405 00
TOTAL: 607 400-025-0000 | 20150301673831 | 1.363-516-288

LEGAL DESCRIPTION

Order No.: 15NW5759152WC

For APN/Parcel ID(s): 16-07-400-025 and 16-07-400-026

Parcel 1:

The North 31 feet of the West 35.55 feet of lot 4 and the North 31 feet of the East 24.45 feet of Lot 5 in Blackstone Addition to Oak Park in the West ½ of the Southeast ¼ of Section 7, township 39 North, range 13, East of the Third Principal Meridian, in Cook County, Illinois.

Parcel 2:

The West 35.55 feet of lot 4 (except the North 31 feet thereof) and the East 24.45 feet of lot 5 (except the North 31 feet thereof) in Block 3 in Blackstone Addition to Oak Park in the West ½ of the Southeast ¼ of Section 7, township 39 North, range 13, East of the Third Principal Meridian, in Cook County, Illinois.

AFFIDAVIT OF OWNERSHIP

COUNTY OF COOK) SS
STATE OF ILLINOIS)
I, ALT GUREYUL , under oath, state that I am (Print Name) The sole owner of the property
an owner of the property an authorized officer for the owner of the property
commonly described as 715-717 S. BWO. OAK PARK, 1L.
and that such property is owned by 117 South BWD, LLC, as of this date. (Print Name / Company) (Signature)
SUBSCRIBED AND SWORN TO BEFORE ME THIS
13 DAY OF NOV 2015
Official Seal Manuel M Ganaden Notary Public State of Illinois My Commission Expires 10/01/2018



123 Madison Street, Oak Park, Illinois 60302

June 20, 2016

717 South Boulevard LLC c/o John Schiess 400 Ashland Avenue River Forest, Illinois 60305

Re: Certificate of Advisory Review - 717 South Boulevard Planned Development

Mr. Schiess:

Thank you for attending the June 9, 2016 meeting of the Historic Preservation Commission. At that meeting you presented revised plans for the 5-story mixed-use building proposed for the vacant lot located within the Ridgeland/Oak Park Historic District. The Commission discussed the revisions to your proposal and had the following comments:

- The additional setback of the fifth floor from the front and rear facades makes sense from a contextual design standpoint, and helps to diminish the building's impact on the adjacent lower scale buildings. The Commission appreciates your responsiveness to this suggestion.
- The commercial space would be a benefit to the building and to the overall exterior design, as it is in a commercial district, and should be retained.
- The changes in the window fenestration on the side facades are an improvement.

Please contact me if you have any questions at (708) 358-5417 or at dkaarre@oak-park.us.

Sincerely,

Douglas Kaarre, AICP

Urban Planner/Historic Preservation

PD Application Item 2

AFFIDAVIT OF NOTICE

AFFIDAVIT OF NOTICE FOR ADJACENT PROPERTY OWNERS

The undersigned Applicant, on oath states that the undersigned provided the Village of Oak Park, in writing, the list of owners of all property within 500 feet, excluding rights-of-way, in each direction of the property to which the petition relates; that documentation from a reputable title company [or other approved agency] indicating the identity of all such owners required to receive notice has been submitted; that such list was prepared in sufficient time for the Applicant to provide notice no less than fifteen (15) days prior to such hearing; and that the owners so notified, are those shown on the last available tax records of the county. (Please attach a list of the notified property owners)

(Printed Name of Applicant)

(Signature of Applicant)

SUBSCRIBED AND SWORN TO BEFORE ME THIS

13 DAY OF 40V - 2015

(Notary Public)

PD Application Item 3

APPLICATION FEE

The application fee was included as part of a previous submittal for this address by this Applicant.

717 SOUTH BOULEVARD, LLC 3528 WALNUT AVE. WILMETTE, IL 60091	DATE	1013 250710 IL 98201
Two thousand dollars and	Park oo Inn	\$ 2000.00
Bank of America Application	-Albah	Tour-
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PD Application Item 4

PROJECT SUMMARY

The applicant identified the property at 717 South Boulevard as being underdeveloped, having recently been considered as a Bank branch with a drive thru facility. The challenges in developing this parcel were its limited size and dimensions as well as a history of neighborhood opposition to previously proposed developments.

From early neighborhood meetings that included design input sessions and early discussions with stakeholders, the developer now proposes a 14 unit, five story condominium with 20 off street covered parking spaces. The proposed building is designed with brick masonry, stone masonry and high-density concrete fiberboard siding. The building as designed will meet all aspects of Illinois' Accessibility Standards.

The proposed building, features and architecture have been reviewed by the Village's design consulting architect and received praise for modifications implemented. The Village's Historic Preservation Commission also reviewed the exterior features and design of the building and has recommended approval.

The responses to the Comprehensive Plan Standards, Municipal Standards, Neighborhood Standards and Economic Development Standards are contained within this Item Section.

PD Application Item 4, continued

Zoning Analysis

Pursuant to Section 6.2.3, items a, b and c, we hereby request a reduction in the number of required off-street parking spaces because of the following:

- a. there are 6 public parking spaces directly adjacent to the property
- b. the real estate professional associated with this application will testify that the future buyers of the condominium units in this proposed development will use mass transit
- c. currently there exists a "Divvy Bike" bike sharing station within 200 feet of the proposed development

Reasons demonstrate that the proposal meets standards in section 3.9.1

The Residences at South Boulevard (717 South Boulevard) development will contribute to achieving many of the goals and objectives for Housing, Transportation and Parking, and Economic Development established in the Village's 2014 Comprehensive Plan. The specific goals and objectives have been met and identified below.

Comprehensive Plan Standards

Strengthen the Urban Fabric

Objective: 4.1.2 Strengthen the community's urban fabric through context sensitive infill development that is complementary to the scale and character of surrounding residential neighborhoods.

The proposed project is consistent with the goals and objectives of Oak Park Comprehensive Plan with respect to development within the existing urban fabric. While the proposed development has a building height that is greater than its immediate neighbors, it complements the character of the urban fabric by aligning the building to the lot lines that is a consistent character on South Boulevard. The building's design has been respectful of sightlines as it sets back on the fifth floor to adjust for existing sight lines from the north, south and east. Further, the planning for the building's vehicular and pedestrian traffic respects traditional patterns that are apparent along South Boulevard.

Additionally, the building's design and planning have been reviewed by the Village's Historic Preservation Commission and the Village's Architectural Consultant, Floyd Anderson. HPC has concluded its review by recommending approval by the Village Board of the Plan Development application and was complimentary of the revisions made by the Architect during their review process.

Comprehensive Plan Standards, continued

Attracting a Diverse Population

Objective 7.1.5 Actively market Oak Park to a broad spectrum of potential residents throughout the Chicago region and ensure that all neighborhoods are appealing to all residents and potential residents.

Since the majority of Oak Park's housing stock was built from the 1920's through the 1950's that is primarily single family homes with detached garages; and multi-family buildings – both building types as designed do not meet any of the current accessibility standards. Therefore, by offering new housing units, with covered garage parking and that meet the current Illinois and ADA accessibility standards, the proposed development will serve different buyer markets than much of the existing housing stock does not. This proposed development will provide a diversification of housing stock and therefore further the objectives of the comprehensive plan.

Additionally, Like similarly situated suburbs, Oak Park's population has been gradually shrinking, since 1970, trends toward lower birth rates, longer life spans, and the formation of more single parent households have resulted in a need for a modified home ownership paradigm. In addition, residents grow older, their children leave home, resulting in a smaller household size. Younger couples have often delayed child-bearing until they are older. Consequently, a given housing unit will frequently be found to have fewer occupants today than it did in 1970. A consequence of this decline in population is the proportionate decline in the size of Oak Park's shopping market. To prevent further erosion of the Village population base, the Village will need to attract more residents by offering a diverse stable of housing options. This development will bring in new residents to Oak Park, thereby assisting in the objective of attractive a diverse population.

Encourage Accessible Housing & Programs

Objective 7.3.1 Continue the Village's role in encouraging the rehabilitation and development of accessible and integrated housing through the use of municipal resources, policies and support.

In the same manner where the development supports Objective 7.1.5, the development also supports this Objective in that, through the Village's approval of this development, and by the development offering new housing units that meet the current ADA and Illinois accessibility standards, the proposed development will serve different buyer markets than much of the existing housing stock does not.

Comprehensive Plan Standards, continued

Fostering Transit Oriented Development

Objective 7.3.6 Encourage transit-oriented development with appropriate housing types and densities as a means of broadening housing choice, responding to local and regional markets, providing more direct access to goods and services, and strengthening the Village's business districts.

This proposed development is located within steps of rapid transit stop (the Green Line) and the Pace Bus stop at Oak Park Avenue and South Boulevard. The marketing strategy for the units that are to be built, if approved, uses the Transit Oriented Development aspect of this site as its central feature. The new residents of this development will purchase here primarily because of its location and related "walk score". See walkscore.com for this address.

Educating Consumers about Energy Efficiency

Objective 13.1 Support public awareness campaigns and hands-on workshops to educate consumers about energy efficient systems and practices for private residences and businesses.

While this development is neither a workshop nor a campaign, the fact that the approval for this development is a very public process that encourages the public's participation, and, while a key component of this proposed development is its energy efficiency and LEED status, the public participation component of the approval process supports public awareness about energy efficiency.

Reducing Storm Water Runoff

Objective 13.4.1 Reduce the demand on local and regional storm water collection and treatment infrastructure through the use of various techniques and applicable streetscapes, infrastructure and development.

A key component of this proposed development is its vegetated roof. The vegetated roof will act as a buffer between rapid rain downfall and the introduction of stormwater into the Village's combined sewer system. As designed, this system will have a positive impact on the Village's stormwater management and thereby support this Objective.

Municipal Services Standards section 3.9 (H) 2

Planned Developments are required to satisfy the following Municipal Service Standards:

a. The establishment, maintenance, or operation of the use or combination of uses will not be materially detrimental to or endanger the public health, safety, morals or general welfare of the residents of the Village.

The proposed development will not be materially detrimental to or endanger the public health, safety, morals or general welfare of the residents of the Village.

The proposed project will not be materially detrimental in terms of public health in that the proposed project will meet the Village's requirements for proper installation of water and sewer systems. Further, we expect a positive recommendation from the Fire Chief, since the proposed development will be constructed with an automatic fire suppression system.

b. Adequate utilities, road access, drainage, police and fire services and other necessary facilities already exist or will be provided to serve the proposed use or combinations of uses, including access for fire, sanitation, and maintenance equipment.

Greengard, Inc. the civil engineer for this development has concurred that **there is adequate** capacity in the **existing water and sewer** facilities to handle the impact of the proposed development. We have attached to this application a preliminary schematic of the utility plan showing the proposed water and sewer connections to the mains on Washington Boulevard. Based on the above, we believe that adequate utilities currently exist to serve the proposed use.

We believe that adequate Police and Fire protection facilities exist to be able to maintain the proposed development.

Regarding transportation, this development is in close proximity to the CTA rapid transit line station at Oak Park and South Boulevard and the METRA transit station at Marion and South Boulevard. The location of this development is convenient for future home owners to use the CTA bus, CTA rapid transit and METRA. Therefore, this convenience will encourage future home owners to use of public transportation and thereby be less dependent on automobiles.

Municipal Services Standards section 3.9 (H) 2, continued

c. Adequate ingress and egress to the proposed use or combination of uses already exists or will be provided in a manner that adequately addresses additional traffic congestion in the public streets and promotes a safe and comfortable pedestrian environment.

Ingress and egress to the development's parking garage is provided from the public alley to the South. In that sense, the development's unit owners will access their respective "garages" in much the same way townhouse residents at Euclid and South Boulevard and the Commercial tenants currently access their cars at the two commercial buildings to the west.

Neighborhood Standards section 3.9 (H) 3

a. The proposed use or combination of uses will not substantially diminish the use or enjoyment of other property in the vicinity for those uses or combination of uses that are permitted by the Zoning Ordinance of the Village.

This development will not substantially diminish the use or enjoyment of other property in the vicinity since it will complement the existing uses (see vicinity plan with zoning designations for surrounding properties). In fact the building has been designed with quality materials which will be more appealing.

b. The proposed use or combination of uses will not have a substantial adverse effect upon property values in the vicinity.

The proposed project will benefit the neighbors properties, by converting a vacant lot into an attractive condominium development. Property values will be enhanced due to the construction of these residences, which are expected to sell in the price range of \$425,000-\$550,000.

c. The proposed design, use or combination of uses will complement the character of the surrounding neighborhood.

As stated in response to "a" and "b' of the Neighborhood Standards, The Residences at South Boulevard were envisioned to both complement and contribute to the surrounding neighborhood. Specifically, the design of the project, with emphasis on architectural details, provides an attractive and suitable presence at on South Boulevard. Further, a key element of the neighborhood is public transportation within walking distance. We believe the project successfully introduces the density needed for transit-oriented development without overwhelming its surrounding neighbors.

Economic Development Standards section 3.9 (H) 4

a. The applicant has the financial and technical capacity to complete the proposed use or combination of uses.

717 South Boulevard, LLC and its affiliate company, Jenny Builders, Inc., has experience in residential projects and has the financial and technical capacity to complete the proposed development. Jenny Builders has successfully built out the remainder of homes at SoHo and is currently actively developing over 30 units of multi-family homes in the Chicago area.

b. The proposed use or combination of uses is economically feasible and does not pose a current or potential burden upon the services, tax base, or other economic factors that affect the financial operations of the Village, except to the extent that such burden is balanced by the benefit derived by the Village from the proposed use.

As to the possible burden on the Village services, we restate the points raised earlier in this application:

The civil engineer, Greengard, believes that **there is adequate** capacity in the **existing water and sewer** facilities to handle the impact of the proposed development. We will attached to this application a schematic of the utility plan showing the proposed water and sewer connections to the mains on Maple Avenue. Based on the above, we believe that adequate utilities currently exist to serve the proposed use.

As to the possible burden on the tax base to the Village, we restate our point of the fact that the Real Estate tax base would increase as a result of this development:

In order to expand the Village tax base in order to maintain a high level of service, programs and facilities, the largest single source of revenues for taxing agencies like Village government is real estate taxes. The total real estate tax levy in Oak Park during the 2001 (for 2002 expenditures) was apportioned as follows:

66.33 percent for schools, (District 97, District 200, Triton)
21.14 percent for Village taxing agencies (Village Hall, Library, Park District)
6.53 percent for Cook County taxing agencies
6.00 percent for all others

Economic Development Standards section 3.9 (H) 4, continued

Oak Park residents pay about 2.03 percent of market value of their real property in annual real estate taxes. The proposed development will be fourteen condos with an average market value of \$ in 2007. Therefore:

- \$ 488,000. per residential condominium (average), Total market value of development \$6,832,000.
- \$ 6,832,000. x 2.03% = \$157,136 taxes for residential condominiums
- Total real estate taxes projected: \$175,812 per year.

Conclusion of Standard Applicability

In Conclusion, based on the facts mentioned above, we believe, the proposed project will:

- · Be an asset to the community, and immediate neighborhood
- Increase property values,
- Help attract a diverse population, and
- Help with residual economic development.
- Provide needed and diversified housing stock

PROJECT ZONING DATA

Project Name THE RESIDENCES @ SOUTH BOULEYARD

Date: SEPTEMBER 29, 2016

1 Commercial Space + 20 Private Parking Spaces + 14 Dwelling Units

Project Address

715-717 South Boulevard Oak Park, Illinois

Prepared By: John Conrad Schiess, Architect

Lot Dimensions 60.0' x 150.0'

Total Lot Area 9,000 square feet

Applicant:

ZONING ANALYSIS

ITEM	SECTION	REGULATIONS	REQUIRED	PROPOSED	ALLOWANCE
Zone District	3.8.1	B-1/B-2 Business District	Mixed Use	Mixed Use (Commercial + Multifamily)	none
Min. Lot Area and Intensity Of Use	3.8.1-A.1.b	Lot area: not less than 3,000 sq ft of land for the first two multi- family dwelling units and additional 700 sq ft of land for each dwelling unit excess of 2.	10 ALLOWED	14	4
Allowable Height Max.	3.8.1-A.2	45'-0"	45'-0"	60'-0"	15'-0"
Setbacks Min.	3.8.1-B.2				
Front		0'-0"	0'-0"	0'-0"	none
Rear		0'-0"	0'-0"	0'-0"	none
Side		0'-0"	0'-0"	0'-0"	none
Min. Open Space	3.8.1-C.1	25% of lot area or any Vegetative/Green roof may reduce the applicable open space requirement on a 2:1 basis.	2,250 sq ft	4,587 sq ft (Vegetative/Green Roof)	none
Parking					
Multifamily	6.2.2(D)	Three bedrooms and larger (2 spaces per unit) + 2 commercial	30	20	3*
Parking Credits*	(C)	Zoning Officer may authorize 25% reduction in the number of required off-parking spaces under on street-parking, transit availability, and bicycle parking circumstances.	7 (25%)	7 (there are 5 current on-street parking directly adjacent to the property and homeowners will utilize public transporation)	* request 7 parking credit
Loading Berth	6.2.8	For buildings or uses commercial district and consisting between 7,500 to 25,000 square feet of floor area, at least one off-street loading berth shall be provided.	1	1 (10' x 25')	none

PD Application Item 5 PROFESSIONAL QUALIFICATIONS

Developer: 717 South Boulevard, LLC + Jenny Builders, Inc.

717 South Boulevard, LLC is a single purpose Illinois limited liability corporation with the sole purpose to purchase and develop the property at 717 South Boulevard in Oak Park, IL.

717 South Boulevard, LLC is a corporate entity whose partners include Mark Bolun, manager of 717 South Boulevard, LLC and Arthur Gurevich, authorized officer for the LLC.

Both Arthur Gurevich and Mark Bolun are partners in the construction company, Jenny Builders. Jenny Builders has successfully completed over 30 multi-family and mixed use buildings throughout the Chicago area. In Oak Park, Jenny Builders purchased the failed SoHo development and successfully completed it.

Attached to this Item Section is a more detailed Qualifications Statement for Jenny Builders, Mark Boldun + Arthur Gurevich.

Architect: JCSA + John Conrad Schiess Architect, Ltd.

JCSA is a full service architectural design firm. The firm offers a unique blend of architectural design plus the proven ability to insure development clients realize their project visions. In addition to years of design excellence, including award-winning designs, JCSA has over 20 years of success in helping their clients gain necessary governmental approvals such as discretionary permits, historic preservation certificates and land use entitlements. JCSA specializes in a collaborative approach that includes working with neighborhood groups, municipal staff, and policy makers to build consensus and turn project visions into reality.

John Conrad Schiess, president of JCSA, is licensed to practice architecture in both California and Illinois, and is also a LEED Accredited Professional. He is fluent in both English and Spanish, his native language. Over the years he has served on community advisory commissions in Oak Park, including the Historic Preservation Commission. John also taught architecture for 10 years at Triton Community College.

THE COMPANY:

Over the last 16 years, Mr. Mark Boldun and Mr. Art Gurevich built several dozen projects varying in size from custom single family homes to many mid-size (6-13) unit elevator buildings, to several townhome development (15-18 units). Mr. Mark Boldun and Mr. Art Gurevich buildings received 2 awards: The New Construction Award from the Chicago Commission on Landmarks (4510 S. Greenwood and 4512 S. Greenwood) and The Good Neighbor Award from the Chicago Association of Realtors (4115 S. Drexel Blvd.). Current projects consist of an 8 residential condo units at 2442 N. Clybourn, 15 townhome development at 2823 N. Oakley (just completed), 7 residential condo units at 2140 W. Armitage, 4 residential condo units at 2301 W. Wolfram, all in Chicago and 8 Condominiums and 17 Townhomes development in Oak Park. There are also several smaller projects in progress in Chicago and saburns. Mr. Mark Boldun and Mr. Art Gurevich are involved in every phase of the project development, from acquisition of land, to working with an architect on concept development and layouts optimization, to planning and zoning issues, to building permits, construction, inspections, certificates of occupancy, and legal issues related to units closings. Mr. Mark Boldun and Mr. Art Gurevich have excellent working relationship with the City of Chicago Aldermen in the wards where they have their projects –Toni Preckwinkle, former Alderman of 4th Ward (now Chairman of the Cook County Board); and Alderman Michelle Smith, 43rd Ward (Lincoln Park). We also enjoy excellent working relationship with the City of Chicago Department of Planning and the City of Chicago Building Department. Mr. Mark Boldun and Mr. Art Gurevich have an unblemished reputation with all of these agencies and have never been involved in a law suit in relation to their product.

During the last recession, Mr. Boldun and Mr. Gurevich acquired many foreclosed distressed projects from area banks and successfully brought them to completion and sale.

PRINCIPALS:

Mr. Mark Boldun, BSCE. Mr. Boldun is career construction industry professional, with more than 40 years of experience encompassing all phases of construction. After graduating from the Ukrainian Institute of Construction Engineering with a degree in Civil Engineering, he rose through the ranks in one of the largest state owned construction companies in Ukraine, from the Project Superintendent to Chief Engineer to 10 years as the Assistant General Director. The 1,500 employee company was one of the largest residential builders in Ukraine, with annual production of 1,100,000 square feet of living space.

Mr. Art Gurevich, BSCE, MBA. Mr. Gurevich is a career construction industry professional, with more than 30 years of experience encompassing all phases of construction. After Graduating from the Illinois Institute of Technology with a degree in Civil Engineering, Mr. Gurevich worked as a Structural Designer for one of the leading nuclear power station design firms and attended a Graduate Management School at the University of Illinois. After receiving his MBA, Mr. Gurevich worked as a Supervisor of Inspectional Services for the Village of Hanover Park, Illinois, and later, for almost 9 years, as a Building Commissioner for the Village of Vernon Hills, Illinois. In this position, Mr. Gurevich, with a staff of 10, oversaw all phases of the planning, zoning and building function of the Village of Vernon Hills, with over 200 million dollars annual construction volume. Since 1999, Mr. Gurevich has been developing residential projects with Mr. Boldun in the City of Chicago and neighboring suburbs.

Mrs. Art Gurevich and Mark Boldun Development Projects

4413 S. Lake Park Ave., Chicago	new 3 dwelling unit condominium in Landmark District
4710 S. Ellis Ave., Chicago	new 7 dwelling unit condominium
4714 S. Evans Ave., Chicago	new 7 dwelling unit condominium
4510 S. Greenwood Ave, Chicago	new 4 dwelling unit condominium Landmark Award
4512 S. Greenwood Ave, Chicago	new 4 dwelling unit condominium Landmark Award
4458 S. Greenwood Ave., Chicago	new 6 dwelling unit condominium in Landmark District
4427 S. Oakenwald Ave., Chicago	new 4 dwelling unit condominium in Landmark District
4431 S. Oakenwald Ave., Chicago	new 4 dwelling unit condominium in Landmark District
4435 S. Oakenwald Ave., Chicago	new 4 dwelling unit condominium in Landmark District
1036 E. 45 th Street	new 4 dwelling unit condominium Landmark District
3968 S. Ellis Ave., Chicago	new 8 dwelling unit condominium
3976 S. Ellis Ave., Chicago	new 8 dwelling unit condominium
3982 S. Ellis Ave., Chicago	new 8 dwelling unit condominium
3971 S. Ellis Ave., Chicago	new 8 dwelling unit condominium
4105 S. Drexel Blvd., Chicago	new 13 dwelling unit elevator condominium
4115 S. Drexel Blvd., Chicago	new 7 dwelling unit condominium Good Neighbor Award
4956 S. Champlain Ave., Chicago	new 6 dwelling unit condominium
4800 S. St. Lawrence Ave., Chicago	new 6 dwelling unit condominium
4806 S. St. Lawrence Ave., Chicago	new 6 dwelling unit condominium
4921 S. Martin Luther King Dr., Chicago	new 8 dwelling unit condominium

1955 W. Melrose Ave. Chicago	new 3 dwelling unit condominium
1058 N. Paulina Ave., Chicago	new 3 dwelling unit condominium
2117 W. Armitage Ave., Chicago	new 2 dwelling unit condominium
2448 N. Southport Ave., Chicago	new 3 + 1 unit mixed use condominium; , completion of an unfinished construction project (Completed in 2003)
1626 W. LeMoyne Ave., Chicago	new 2 dwelling unit condominium
1631 W. LeMoyne Ave., Chicago	new 2 dwelling unit condominium
1637 W. LeMoyne Ave., Chicago	new 3 dwelling unit condominium
1327 N. Greenview Ave., Chicago	new 3 dwelling unit condominium
1722 W. Beach Ave., Chicago	new 2 dwelling unit condominium
1728 W. Beach Ave., Chicago	new 2 dwelling unit condominium
1630 W. Julian Ave., Chicago	new 3 dwelling unit condominium
3404 N. Seminary., Chicago	new 3 dwelling unit condominium
1306 Brook Ln., Glenview	new custom single family house
1030 Manor Dr., Wilmette	new custom single family house
3534 Elmwood, Wilmette	new custom single family house
3528 Walnut, Wilmette	new custom single family house
945 Hunter, Glenview	new custom single family house
3522 Walnut, Wilmette	new custom single family house
3815 N. Kedzie	New 6 residential + 2 commercial condo building. The building has since been rezoned form B3-2 to B2-3 to allow conversion of the 2 commercial spaces into residential condominiums; completion of an unfinished construction project acquired from a bank (Completed in 2009)
3627-35 Forest Ave., Brookfield	New 18 townhomes development; completion of an unfinished construction project (Completed in 2010)

844 S. Humphrey, Oak Park	Gut rehab 11 unit condo conversion (now rental); completion of an unfinished construction project acquired from a bank (Completed in 2010, sold building in 2012)
1021 N. Wood St., Chicago	New 3 dwelling unit condominium; completion of an unfinished construction project acquired from a bank (Completed in 2010)
815 W. Newport, Chicago	Gut rehab 9 unit condo conversion; completion of an unfinished construction project acquired from a bank (Completed in 2011)
1443 W. Thomas, Chicago	new 6 dwelling unit condominium; completion of an unfinished construction project acquired from a bank (Completed in 2011)
3528 Elmwood, Wilmette	new custom single family house
2849-51 N. Ashland, Chicago	3 condominium units in a 5 unit building; completion of an unfinished construction project acquired from a bank (Completed in 2012)
1823 N. Halsted, Chicago	2 condominium units in a 3 unit building; completion of an unfinished construction project acquired from a bank. Completed in 2012
2628-30 N. Halsted, Chicago	new 6 residential + 2 commercial unit building
2646 N. Halsted, Chicago	(Completed 2013) new 9 residential + 2 commercial unit building (Under construction). Land acquired from a bank
1005 South Blvd., Oak Park	8 residential and 1 commercial condominiums and 17 townhomes. Completion of an unfinished construction project acquired from a bank. Acquired on 2/15/2013. Under construction.
2823 N. Oakley, Chicago	New riverfront development of 15 townhomes. Land acquired from a bank.
2140 W. Armitage	New 7 unit condominium building. (Under construction)
2301 W. Wolfram, Chicago	4 unit residential condominium building (under construction). Land acquired from a bank.
2442 N. Clybourn	8 unit condo building (under construction. Land acquired from a bank)
2501 N. Halsted	3 unit condo building

2640 N. Halsted 3 unit condo building

3342 N. Sheffield 4 unit condo building

2654 N. Paulina Single family home

625 W. Cornelia 5 unit condo

2450 N. Clybourn 12 unit condo (waiting for a permit)

1000-1006 W. Montana 5 unit townhome

840 N. Franklin, Palatine 15 townhomes (waiting for a permit)

PD Application Item 6 PROPOSED FINANCING

The Developer has secured 75% of the required construction financing from the Construction Lender, Forest Park National Bank, as shown in the attached Letter. The Developer will use their own private equity for the balance (25%) for the Construction Costs.



Forest Park National Bank & Trust Co.

Customer Centered & Community Minded Since 1943

November 13, 2015

Mr. Art Gurevich 717 South Boulevard LLC 3528 Walnut Avenue Wilmette, IL 60091

RE: 715-717 South Boulevard, Oak Park, IL 60302

Mr. Gurevich,

Forest Park National Bank & Trust Co. would like to thank you for the opportunity to offer financing for the development of the parcel at 715-717 South Boulevard, Oak Park.

After review of salient financial information the bank determines the project to be qualified for financing of 75% of the projected total budget. Final approval as well as the loan terms and conditions will be subject to all required due diligence, as determined by the bank. Again thank you for the opportunity to address your credit needs and we look forward to establishing this business relationship.

Best regards,

FOREST PARK NATIONAL BANK & TRUST CO.

Chris R. Griffith

AVP - Commercial Lending

PD Application Item 7 PLAT OF SURVEY

The Plat of Survey shows the gas meter for the property to the east to be an unpermitted encroachment. The property owner will be notified of the unpermitted encroachment and will be required to relocate the meter.

Furthermore, there is a virtual encroachment onto this property by the fact that the building directly to the east of the subject property has several non-code compliant windows. To the Architect's knowledge, the property owner to the east has been notified by the Building Department's past Director, Mr. Steve Witt, that, in fact, the windows are non-code compliant and that once development is proposed by the owner of the subject property (717 South Boulevard), that Property Owner (711 South Boulevard) must remove the non-code compliant windows at their expense.

CHICAGOLAND SURVEY COMPANY INC.


6501 W. 65TH STREET CHICAGO, ILLINOIS 60638 (773) 271-9447 CHICAGOLANDSURVEY@SBCGLOBAL.NET

ALTA/ACSM LAND TITLE SURVEY

THE NORTH 31 FEET OF THE WEST 35.55 FEET OF LOT 4 AND THE NORTH 31 FEET OF THE EAST 24.45 FEET OF LOT 5 IN BLOCK 3 IN BLACKSTONE'S ADDITION TO OAK PARK, THE SUBDIVISION OF THE NORTHWEST 1/4 OF THE SOUTHEAST 1/4 OF SECTION 7, TOWNSHIP 39 NORTH, RANGE 13, EAST OF THE THIRD PRINCIPAL MERIDIAN, IN COOK COUNTY, ILLINOIS.

PARCEL 2:

THE WEST 35.55 FEET OF LOT 4 (EXCEPT THE NORTH 31 FEET THEREOF) AND THE EAST 24.45 FEET OF LOT 5 (EXCEPT THE NORTH 31 FEET THEREOF) IN BLOCK 3 IN BLACKSTONE'S ADDITION TO OAK PARK, THE SUBDIVISION OF THE NORTHWEST 1/4 OF THE SOUTHEAST 1/4 OF SECTION 7, TOWNSHIP 39 NORTH, RANGE 13, EAST OF THE THIRD PRINCIPAL MERIDIAN, IN COOK COUNTY, ILLINOIS.

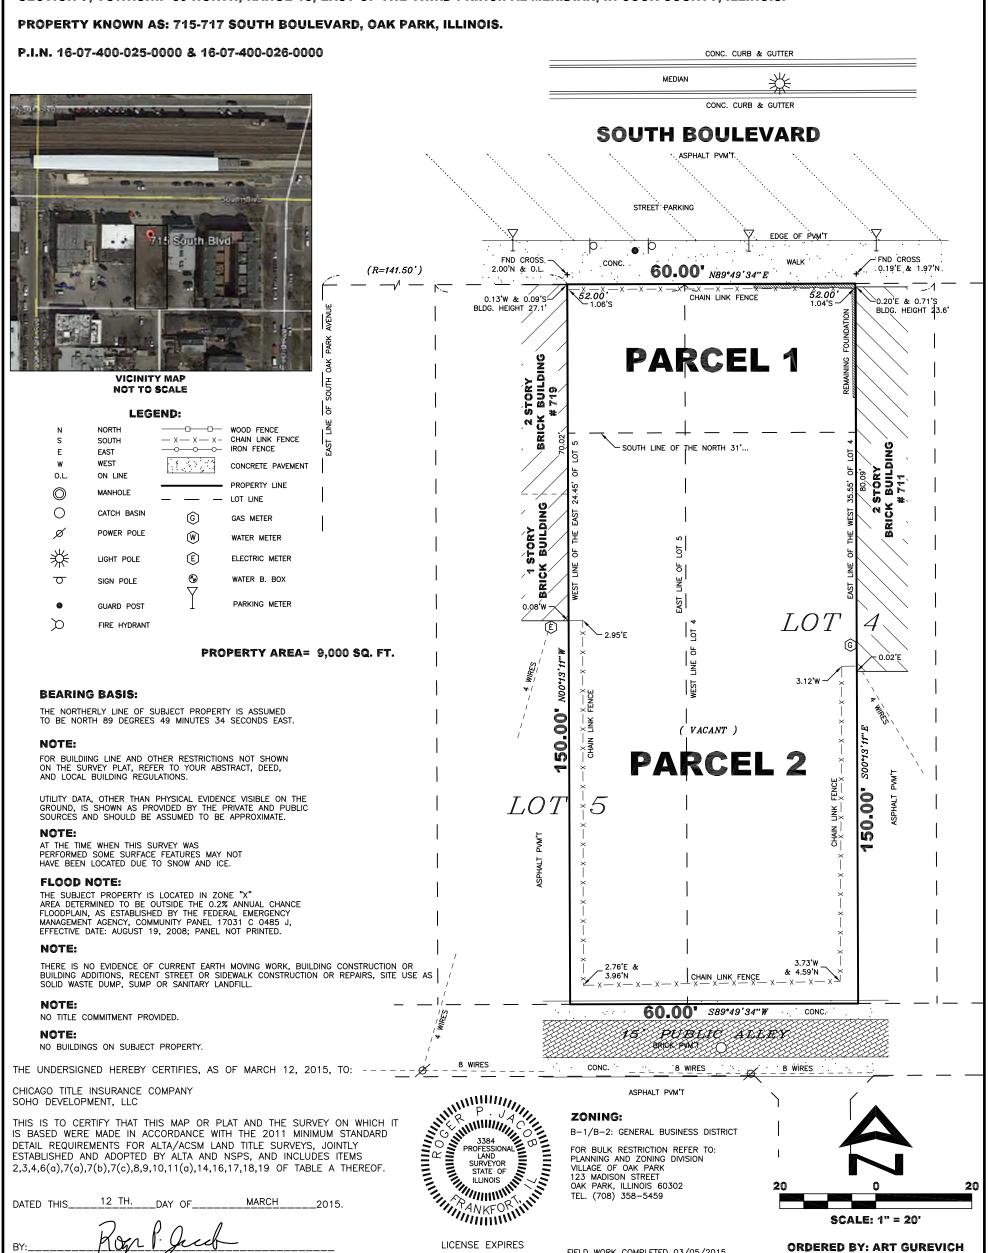

11/30/2016

LAND SURVEYOR NO. 3384

FIELD WORK COMPLETED 03/05/2015

FILE NO.: 114-13

PD Application
Item 8
LIST AND MAP OF SURROUNDING PROPERTY OWNERS



16-07-123-001-0000	16-07-129-014-0000	16-07-129-016-0000
EXEMPT	US BANK FACILITY MGMT	SCOVILLE SQUARE ASSCO
	2800 EAST LAKE ST	137 N OAK PARK
	MINNEAPOLIS, MN 55406	OAK PARK, IL 60301
	WIINNEAI OLIS, WIN 33400	OAKTAKK, IL 00301
16-07-129-018-0000	16-07-129-019-0000	16-07-129-020-0000
NORTH GROUP LLC	DANIEL F BRENNAN	US BANK CORP RE
830 N BLVD	826 NORTH BLVD	2800 E LAKE ST
OAK PARK, IL 60301	OAK PARK, IL 60301	MINNWPOLIA, MN 55406
16-07-129-021-0000	16-07-129-023-0000	16-07-129-024-0000
820 N BLVD LLC	GARY COLLINS 115	W GILMARTIN
136 S CUYLER	P O BOX 887	833 N ORLEANS 400
OAK PARK, IL 60302	OAK PARK, IL 60303	CHICAGO, IL 60610
16-07-129-025-0000	16-07-129-027-0000	16-07-129-028-0000
VALERIE R CARLIN	JOHN D TOOMEY	PAM STRINGER
19W034 AVE NORMANDY E	818 NORTH BLVD	1010 S MAPLE ST
OAK BROOK, IL 60523	OAK PARK, IL 60301	OAK PARK, IL 60304
OAR BROOK, IL 00323	OAK FARK, IL 00301	OAR FARK, IL 00304
16-07-129-034-0000	16-07-129-034-1001	16-07-129-034-1002
NOT VALID	BROOKFIELD RELOCATION	KATHRYN E FARNI
TOT VILLE	16260 N 71ST ST	813 W LAKE ST 1N
	SCOTTSDALE, AZ 85254	OAK PARK, IL 60301
	SCOTTSDALE, AZ 63234	OAKTAKK, IL 00301
16-07-129-034-1003	16-07-129-034-1004	16-07-129-034-1005
RICHARD L ASKAM	MARY K STONER	JEFFREY FELDMAN
813 W LAKE ST 1S	813 LAKE ST 2N	813 W LAKE ST 2S
OAK PARK, IL 60301	OAK PK, IL 60301	OAK PARK, IL 60301
OAKTAKK, IL 00301	OAKTK, IL 00301	OAKTAKK, IL 00301
16-07-129-034-1006	16-07-129-034-1007	16-07-129-034-1008
SCOTT DOLEZAL	NEDRA BOYER	M KRAUSE
810 S EUCLID AVE	813 W LAKE ST 3S	815 LAKE ST 1N
OAK PARK, IL 60304	OAK PARK, IL 60301	OAK PARK, IL 60301
OAKTAKK, IL 00304	OAKTAKK, IL 00501	OAKTAKK, IL 00301
16-07-129-034-1009	16-07-129-034-1010	16-07-129-034-1011
JULIANNE M KING	MATTHEW J MCKAY	MICHAEL KOSIBA
815 W LAKE ST #1S	815 W LAKE ST 2N	815 W LAKE ST 2S
OAK PARK, IL 60301	OAK PARK, IL 60301	OAK PARK, IL 60301
OTRITION, IL 00301	OMC17MX, IL 00301	OAKTAKK, IL 00301
16-07-129-034-1012	16-07-129-034-1013	16-07-129-034-1014
KIMBERLY L REESE	ROBERT A MOSER	NICOLE KELLY
815 W LAKE ST #3N	815 W LAKE ST 3S	825 LAKE ST #15
OAK PARK, IL 60301	OAK PARK, IL 60301	OAK PARK, IL 60301
OTHERTHAL, IL 00001	7.11.17.11di, 11. 00501	71111111111111111111111111111111111111
16-07-129-034-1015	16-07-129-034-1016	16-07-129-034-1017
NANISA S PERELES	JOHN G THORPE	ANDRE O STRUGER
817 W LAKE ST UNIT 1S	817 LAKE ST #2N	817 W LAKE ST 2S
OAK PARK, IL 60301	OAK PARK, IL 60301	OAK PARK, IL 60301
, 12 00001	, 	

16-07-129-034-1018	16-07-129-034-1019	16-07-129-034-1020
DAVID SCHAEFER	BRENDAN SARAH SCHOLZ	SALLY SIMMEL
817 W LAKE ST 3N	4703 SARATOGA AVE	819 W LAKE ST 1E
	DOWNERS GRV, IL 60515	
OAK PARK, IL 60301	DOWNERS GRV, IL 60313	OAK PARK, IL 60301
16-07-129-034-1021	16-07-129-034-1022	16-07-129-034-1023
CAGRI ARSIN	KELLY CARROLL	ALLISON PORTERFIELD
819 LAKE ST 1W	819 LAKE 2E	819 W LAKE ST #2W
OAK PARK, IL 60301	OAK PARK, IL 60301	OAK PARK, IL 60301
OAK FARK, IL 00301	OAK FARK, IL 00301	OAR PARK, IL 00301
16-07-129-034-1024	16-07-129-034-1025	16-07-129-034-1026
CHRISTINA SOCO	THOMAS P ROMENS	GEORGE W ZEHENDER
819 W LAKE ST 3E	819 W LAKE ST 3W	6231 EMBARCADERO DR
OAK PARK, IL 60301	OAK PARK, IL 60301	STOCKTON, CA 95219
OTHETTHER, IL 00301	Om That, in 60501	510CK1011, C/1 73217
16-07-129-034-1027	16-07-129-034-1028	16-07-129-034-1033
EILEEN M BRANN	BENTE CLAUSEN	P HAJEK 311174543
821 LAKE ST 1N	821 W LAKE ST 1S	823 LAKE ST 1N
OAK PARK, IL 60301	OAK PARK, IL 60301	OAK PARK, IL 60301
011111111111111111111111111111111111111	011111111111111111111111111111111111111	011111111111111111111111111111111111111
16-07-129-034-1034	16-07-129-034-1035	16-07-129-034-1036
SANDRA M GEORGE	NORMAN AXELROOD	LISBETH C CESARINI
823 W LAKE ST 1S	422 S SCOVILLE AVE	823 W LAKE ST 2S
OAK PARK, IL 60301	OAK PARK, IL 60302	OAK PARK, IL 60301
OTHETTHER, IL 00301	O/IK 171KK, 12 00302	0711C1711C1C, 1L 00301
16-07-129-034-1037	16-07-129-034-1038	16-07-129-034-1039
CARALYN F SHEEHAN	LORI SUTER	DONNA M GIAMMARESE
823 W LAKE ST 3N	823 LAKE ST #3S	825 W LAKE ST GN
OAK PARK, IL 60301	OAK PARK, IL 60301	OAK PARK, IL 60301
OMCTARIC, IL 00301	OMC17MM, IL 00301	071K171KK, 1L 00301
16-07-129-034-1040	16-07-129-034-1041	16-07-129-034-1042
SELMA M REHM	KELLY	JANET M SEBASTIAN
825 W LAKE ST 1N	825 LAKE ST IS	825 W LAKE ST 2N
OAK PARK, IL 60301	OAK PARK, IL 60301	OAK PARK, IL 60301
,	,	,
16-07-129-034-1043	16-07-129-034-1044	16-07-129-034-1045
SANDRA L CZAJKA	GARY HANLEY	BRUCE DEVILLER
825 W LAKE ST 2 S	825 LAKE ST #3N	825 W LAKE ST #3S
OAK PARK, IL 60301	OAK PARK, IL 60301	OAK PARK, IL 60301
16-07-129-034-1046	16-07-129-034-1047	16-07-129-034-1048
ADAM T COLLERAN	SANDRA K SEIM	PETERS WOODS
821 LAKE ST #2N	821 LAKE ST #2S	821 LAKE STREET 3N
OAK PARK, IL 60301	OAK PARK, IL 60301	OAK PARK, IL 60301
16 07 120 024 1040	16.07.100.026.0000	16.07.100.026.1001
16-07-129-034-1049	16-07-129-036-0000	16-07-129-036-1001
MARY J RASMUSSON	NOT VALID	101 N OAK PARK LLC
821 LAKE ST 3S		101 N OAK PARK AV
OAK PARK, IL 60301		OAK PARK, IL 60301

16-07-129-036-1002	16-07-129-036-1003	16-07-129-036-1004
NORAS SHOE SHOP	AJAY BHATIA	101 N OAK PARK LLC
103 N OAK PARK AVE	23W341 HAMPTON CR	101 N OAK PARK
	NAPERVILLE, IL 60540	
OAK PARK, IL 60301	NAPERVILLE, IL 00340	OAK PARK, IL 60301
16-07-129-036-1005	16-07-129-036-1006	16-07-129-036-1007
WEICHERT REALTORS	FAMILY CREDIT COUNSELI	PROFESSIONAL SERV PROP
101 N OAK PARK AV	4306 CHARLES ST	4843 LEES CT
OAK PARK, IL 60301	ROCKFORD, IL 61108	OSWEGO, IL 60543
16-07-129-036-1008	16-07-129-036-1009	16-07-129-036-1010
LOU FABBRI GROUP	MICHAEL WARD	EVAN AMY MCKERNS
3 S 002 IL ROUTE 53	10218 DONLEIGH DR	305 N ELMWOOD AVE
GLEN ELLYN, IL 60137	COLUMBIA, MD 0	OAK PARK, IL 60302
16-07-129-036-1011	16-07-129-036-1012	16-07-129-036-1013
C SANDERS NIELSEN	CHRISTIAN LAUREN DAWES	WILLIAM PULKRABEK
19W124 AVE NORMANDY N	806 NORTH BLVD #202	806 NORTH BLVD #301
OAK BROOK, IL 60523	OAK PARK, IL 60301	OAK PARK, IL 60301
16-07-129-036-1014	16-07-129-036-1015	16-07-129-036-1016
JAN OBRYK	JACLYN PULKRABEK	CATHERINE AMATO
812 NORTH BLVD #302	806 NORTH BLVD #301	806 NORTH BLVD #302
OAK PARK, IL 60301	OAK PARK, IL 60301	OAK PARK, IL 60301
16-07-218-006-0000	16-07-218-007-0000	16-07-218-013-0000
RP FOX AND ASSOCIATES	SIMONE ENTERPRISE LP	SBC AMERITECH
1110 PLEASANT ST	PO BOX 5262	ONE SBC CENTER 36M01
OAK PARK, IL 60302	RIVER FOREST, IL 60305	ST LOUIS, MO 63101
16-07-218-016-0000	16-07-218-024-0000	16-07-218-025-0000
R P FOX	R P FOX ASSOC INC	SIMONE ENTERPRISE LP
1110 PLEASANT	1110 PLEASANT ST	PO BOX 5262
OAK PARK, IL 60302	OAK PARK, IL 60302	RIVER FOREST, IL 60305
16-07-218-029-0000	16-07-218-029-8001	16-07-218-029-8002
EXEMPT	EXEMPT	INC TASTY DOG
DZXDIVII I		708 LAKE STREET
		OAK PARK, IL 60301
16-07-219-029-0000	16-07-219-029-1001	16-07-219-029-1002
NOT VALID	CHARLES PLANEK	JAMES GULLY
TOT TILLE	140 N EUCLID AVE #201	140 N EUCLID AV #202
	OAK PARK, IL 60302	OAK PARK, IL 60302
16-07-219-029-1003	16-07-219-029-1004	16-07-219-029-1005
CAROL WYANT	PHYLLIS VOLK	CHARLES S MANN JR
140 N EUCLID #203	250 E PEARSON ST 906	140 N EUCLID AVE 205
OAK PARK, IL 60302	CHICAGO, IL 60611	OAK PARK, IL 60302
OTIXTAIX, IL 00302	CITICAGO, IL 00011	OMETAIN, IL 00302

46.05.040.000	460-04000-	460-04000
16-07-219-029-1006	16-07-219-029-1007	16-07-219-029-1008
DANIEL WAADT	RUBEN MESTRIL	OTTISTEAN ARRINGTON
140 N EUCLID AVE #206	140 N EUCLID AV #207	140 N EUCLID AVE #208
OAK PARK, IL 60302	OAK PARK, IL 60302	OAK PARK, IL 60302
OAKTAKK, IL 00302	OAKTAKK, IL 00302	OAKTAKK, IL 00302
46070400004000	46.07.040.000.4040	4607040004044
16-07-219-029-1009	16-07-219-029-1010	16-07-219-029-1011
TIMOTHY SUE BROWN	MARIANNE REINHOFER	MICHAEL J BALOUSEK
140 N EUCLID AVE 301	140 N EUCLID #302	140 N EUCLID AVE 303
OAK PARK, IL 60302	OAK PARK, IL 60302	OAK PARK, IL 60302
OAKTAKK, IL 00302	OAKTAKK, IL 00302	OAKTAKK, IL 00302
16-07-219-029-1012	16-07-219-029-1013	16-07-219-029-1014
KENNETH HEIDEL	MARGARET MORGAN	ASARIA
140 N EUCLID AV #304	140 N EUCLID #305	140 N EUCLID AVE #306
OAK PARK, IL 60302	OAK PARK, IL 60302	OAK PARK, IL 60302
0711711111, 12 0030 2	07H17Hd1, 12 00302	0711711111, 1E 0030 2
16-07-219-029-1015	16-07-219-029-1016	16-07-219-029-1017
ROSEMARY C GODFREY	BRIAN D EINHORN	DAUGHTERS HEART MARY
140 N EUCLID AVE #307	140 N EUCLID AVE #308	140 N EUCLID AV 401
OAK PARK, IL 60302	OAK PARK, IL 60302	OAK PARK, IL 60302
16-07-219-029-1018	16-07-219-029-1019	16-07-219-029-1020
ELIZABETH MCGINNITY	JANE L MCDOWELL	JEANNE RAPPEL
140 N EUCLID #402	140 N EUCLID AVE #403	140 N EUCLID AVE #404
OAK PARK, IL 60302	OAK PARK, IL 60302	OAK PARK, IL 60302
16 07 210 020 1021	16.07.210.020.1022	16 07 210 020 1022
16-07-219-029-1021	16-07-219-029-1022	16-07-219-029-1023
BRIGITTE OLTMANNS	LESLIE ANN DENSTAEDT	ROBERT L MESSER
140 N EUCLID AVE 405	140 N EUCLID AV #406	140 N EUCLID #407
OAK PARK, IL 60302	OAK PARK, IL 60302	OAK PARK, IL 60302
07111 111111, 112 0030 2	07H17Hd1, 12 00302	07H17H41, 12 00302
16-07-219-029-1024	16-07-219-029-1025	16-07-219-029-1026
ELIZABETH S WATSON	DONALD C GANCER	J VOJACEK
140 N EUCLID AVE #408	140 N EUCLID UNIT 501	140 N EUCLID 502
OAK PARK, IL 60302	OAK PARK, IL 60302	OAK PARK, IL 60302
16-07-219-029-1027	16-07-219-029-1028	16-07-219-029-1029
MORROW VOJACEK MARTHA	BRUCE E BRIGELL	R REINSTEIN
140 N EUCLID AVE 503	140 EUCLID 504	140 N EUCLID 505
OAK PARK, IL 60302	OAK PARK, IL 60302	OAK PARK, IL 60302
16.07.210.020.1020	16.07.210.020.1021	16.07.224.001.0000
16-07-219-029-1030	16-07-219-029-1031	16-07-224-001-0000
BRAD ANGLE	JEANNE D PETRUZZELLI	JAMES BUSHOUSE
140 N EUCLIC AVE 506	140 N EUCLID #507/508	120 N OAK PARK AV 100
OAK PARK, IL 60302	OAK PARK, IL 60302	OAK PARK, IL 60301
5.11.111111, 11. 00502	5.11.1711di, 11. 00502	5711111111, 1L 00301
16-07-224-002-0000	16-07-224-003-0000	16-07-224-004-0000
J T BUILDING MGT	J T BUILDING MGT	J T BUILDING MGT
715 LAKE ST	715 LAKE ST	715 LAKE ST
OAK PARK, IL 60301	OAK PARK, IL 60301	OAK PARK, IL 60301

16-07-224-021-0000	16-07-224-022-0000	16-07-224-023-0000
JACK TIBBETTS	US BANK FACILITY	VILLAGE OF OAK PARK
123 MADISON ST	2800 EAST LAKE ST	123 MADISON ST
OAK PARK, IL 60302	MINNEAPOLIS, MN 55406	OAK PARK, IL 60302
07HC17HCC, 1L 00302	WII (I CEIS, WII V 33 100	07HC17HHC, 1E 00302
16-07-224-024-0000	16-07-224-025-0000	16-07-224-026-0000
US BANK FACILITY MGMT	VILLAGE OF OAK PARK	NOT VALID
2800 EAST LAKE ST	123 MADISON ST	TOT VILID
MINNEAPOLIS, MN 55406	OAK PARK, IL 60302	
WIINTELLI OLIO, WIN 33400	071K171KK, 1E 00302	
16-07-224-026-1001	16-07-224-026-1002	16-07-224-026-1003
C J GERINGER	HELEN BLINDER	MARK MARGARET MILLER
101 N EUCLID AVE 1	3500 N LAKE SHORE DR4A	101 N EUCLID AVE #5
OAK PK, IL 60301	CHICAGO, IL 60657	OAK PARK, IL 60301
OAK FK, IL 00301	CITICAGO, IL 00037	OAK FARK, IL 00301
16-07-224-026-1004	16-07-224-026-1005	16-07-224-026-1006
THOMAS NEMCHOCK	ISAURE WILLIAM YATES	SEAN HERRING
101 N EUCLID AVE #7	101 N EUCLID AV 9	101 N EUCLID AVE 11
OAK PARK, IL 60301	OAK PARK, IL 60301	OAK PARK, IL 60301
OAK FARK, IL 00301	OARTARK, IL 00301	OAK FARK, IL 00301
16-07-224-026-1007	16-07-224-026-1008	16-07-224-026-1009
BYRON W JOHNSON	RICK SMITH	J LEE H J YOON
101 N EUCLID AV #12	101 N EUCLID AV 13	101 N EUCLID AVE 14
OAK PARK, IL 60301	OAK PARK, IL 60301	OAK PK, IL 60301
OAKTAKK, IL 00301	OAKTAKK, IL 00501	OAKTK, IL 00301
16-07-224-026-1010	16-07-224-026-1011	16-07-224-026-1012
A NOORANI H MUSABJI	DONNA BAPTISTE	JOSE R DE JESUS
101 N EUCLID AV #15	101 N EUCLID AV 16	101 N EUCLID AV #17
OAK PARK, IL 60301	OAK PARK, IL 60301	OAK PARK, IL 60301
OAKTAKK, IL 00301	OAKTAKK, IL 00301	OAKTAKK, IL 00301
16-07-224-026-1013	16-07-224-026-1014	16-07-224-026-1015
RENE MEDINA	JOHN LAURA BILSON	JULIE M SPANBAUER
101 N EUCLID AVE #18	101 N EUCLID AVE #19	101 N EUCLID AVE 20
OAK PARK, IL 60301	OAK PARK, IL 60301	OAK PARK, IL 60301
Original, in objet	OTHETTHER, IL 00301	Olik Illikk, IL 00301
16-07-224-026-1016	16-07-224-026-1017	16-07-224-026-1018
JIE YAO HUAYI HE	C SANDQUIST	JW BOERSMA D HOLDSTEIN
101 N EUCLID 21	101 N EUCLID 22	101 N EUCLID AVE#23
OAK PARK, IL 60301	OAK PARK, IL 60301	OAK PARK, IL 60301
ornerman, in obser	ormania, in occur	Omrandi, il oosoa
16-07-224-026-1019	16-07-224-026-1020	16-07-224-026-1021
THOMAS DENISE WHENNE	MICHAEL BALOUSEK	MICHAEL E MCCLAIN
101 N EUCLID #2	140 N EUCLID AVE #303	101 N EUCLID AVE 6
OAK PARK, IL 60301	OAK PARK, IL 60302	OAK PARK, IL 60301
5.111.11dx, 11. 00501	0.11.111111, 1L 00002	57111 1711dx, 1D 00501
16-07-224-026-1022	16-07-224-026-1023	16-07-224-026-1024
MICHELLE PIEL	JOHN MONAGHAN	VISHAL NEHA BHANDARI
101 N EUCLID #8	101 N EUCLID #10	101 N EUCLID #25
OAK PARK, IL 60301	OAK PARK, IL 60301	OAK PARK, IL 60301
, ID 00001	, 12 00001	

16-07-224-026-1025	16-07-224-026-1026	16-07-224-026-1027
LU WANG	SHALINI MENON	MICHELLE B DIAMANTE
101 N EUCLID 27	101 N EUCLID AV #29	101 N EUCLID AVE 31
OAK PARK, IL 60301	OAK PARK, IL 60301	OAK PARK, IL 60301
OAKTAKK, IL 00301	OAKTAKK, IL 00301	OAKTAKK, IL 00301
16-07-224-026-1028	16-07-224-026-1029	16-07-224-026-1030
ANNE BRADLEY	THOMAS E LUTHER	EMAD ABBASI
101 N EUCLID #33	101 N EUCLID 424	101 N EUCLID AVE #26
OAK PARK, IL 60301	OAK PK, IL 60301	OAK PARK, IL 60301
OTHERTIME, IL 00301	071K1K, 1E 00301	O'IRTINIC, IL 00301
16-07-224-026-1031	16-07-224-026-1032	16-07-224-026-1033
DONALD ADELI	RAVI SHVETA VIJH	A HABIS
101 N EUCLID #28	308 LINDEN AV	101 N EUCLID #32
OAK PARK, IL 60301	OAK PARK, IL 60302	OAK PARK, IL 60301
OMC17MCC, IL 00301	O/IK 171KK, 1L 00302	071K171KK, 1L 00301
16-07-224-026-1034	16-07-224-027-0000	16-07-224-028-0000
M L ZAANDER	CHICAGOLAND ST RETAIL	NOT VALID
101 N EUCLID AVE 34	P O BOX 3666	
OAK PARK, IL 60301	OAK BROOK, IL 60522	
omminut, in obser	0.111 BR0 011, 1E 00022	
16-07-224-028-1001	16-07-224-028-1002	16-07-224-028-1003
RALPH R KAZER	PATRICK M WHELAN	SHERON BAUSLEY
1 ELIZABETH COURT	125 N EUCLID AVE 202	125 N EUCLID AV #203
OAK PARK, IL 60302	OAK PARK, IL 60301	OAK PARK, IL 60301
071K171KK, 1E 00302	Om Thick, in 60501	07111 7111111, 1E 00301
16-07-224-028-1004	16-07-224-028-1005	16-07-224-028-1006
EUCLID COMMONS LLC	MELANIE LUMB	S CAHILL A SCHEIBLE
191 WAUKEGAN RD #202	1210 N EUCLID AVE #205	125 N EUCLID AVE #206
NORTHFIELD, IL 60093	OAK PARK, IL 60302	OAK PARK, IL 60301
North IEEE, IE 00075	07HC17HdC, 1E 00302	ornermus, in obser
16-07-224-028-1007	16-07-224-028-1008	16-07-224-028-1009
APMS	ATTILA J WENINGER	DIANA SETIAWAN
PO BOX 490554	768 PIONEER CT	125 N EUCLID AVE 209
CHICAGO, IL 60649	W CHICAGO, IL 60185	OAK PK, IL 60301
	.,	, - <u>-</u>
16-07-224-028-1010	16-07-224-028-1011	16-07-224-028-1012
RYAN EIKMEIER	CY SLIFKA JR	ALEXANDER H TRUONG
125 N EUCLID AVE #301	125 N EUCLIO AVE #302	125 N EUCLID AVE #303
OAK PARK, IL 60301	OAK PARK, IL 60301	OAK PARK, IL 60301
,	,	,
16-07-224-028-1013	16-07-224-028-1014	16-07-224-028-1015
MOUAFFAK BAKHOS	ERICK GONZALEZ	AMBER M HOOPER
351 JAMESTOWN AVE	125 N EUCLID AVE #305	1106 S EUCLID
WESTMONT, IL 60559	OAK PARK, IL 60301	OAK PARK, IL 60304
16-07-224-028-1016	16-07-224-028-1017	16-07-224-028-1018
KEYA SHIAN	MARIO HORNIK	CHARLES BERRY
1132 MAGGIE LN	125 N EUCLID AVE 308	125 N EUCLID AVE 309
WALNUT CREEK, CA 94597	OAK PARK, IL 60301	OAK PARK, IL 60301

16-07-224-028-1019	16-07-224-028-1020	16-07-224-028-1021
JOHN W MCGIVERN	EMMA A SAINT MARTIN	ROBERT DIANA
125 N EUCLID AVE #401	125 N EUCLID AVE 402	125 N EUCLID AVE 403
OAK PARK, IL 60301	OAK PARK, IL 60301	OAK PARK, IL 60301
16-07-224-028-1022	16-07-224-028-1023	16-07-224-028-1024
ANNA WILLIAMSON	TIFFANY MAXWELL	HOME FIRST ILLINOIS LL
125 N EUCLID AVE 404	125 N EUCLID AVE 405	1 N LASALLE ST #700
OAK PARK, IL 60301	OAK PARK, IL 60301	CHICAGO, IL 60602
16-07-224-028-1025	16-07-224-028-1026	16-07-224-028-1027
NICK SOLOMOS	TANYA SIENKO	DEBORAH A HOLMAN
125 N EUCLID AVE #407	125 NORTH EUCLID #408	120 N OAK PK AVE #414
OAK PARK, IL 60301	OAK PARK, IL 60301	OAK PARK, IL 60301
OAKTAKK, IL 00301	OAKTAKK, IL 00301	OAKTAKK, IL 00301
16-07-225-092-0000	16-07-225-093-0000	16-07-225-094-0000
U S REIF PARK ILLINOIS	EXEMPT	COM ED
1270 SOLDIERS FIELD RD		THREE LINCOLN CTR 4TH
BOSTON, MA 21351		OAKBROOK TER, IL 0
16-07-305-014-0000	16-07-305-015-0000	16-07-305-016-0000
NOEL SCHENK	KATHRYN LUCHT	NORMAN HILL
3444 N OZANAM AVE	115 S GROVE	117 S GROVE AVE
CHICAGO, IL 60634	OAK PARK, IL 60302	OAK PARK, IL 60302
emendo, ie ooosa	0/11C1/11CIC, 112 00302	O/11C1711CIC, 112 00302
16-07-305-017-0000	16-07-305-023-0000	16-07-305-023-1001
BRIAN KOSEK	NOT VALID	INC GONE 2 PLAYA
121 S GROVE	1,01,11111	109-11 S. GROVE
OAK PARK, IL 60302		OAK PARK, IL 60302
Officiality, IE 00302		O/11C1711CIC, 112 00302
16-07-305-023-1002	16-07-305-023-1003	16-07-305-023-1004
JENNIFER L RUBIN	WILLIAM B MERRILL	LIZBETH J LEMKE
109-2N S GROVE AVE	313 S TAYLOR AVE	111 S GROVE 2
OAK PK, IL 60304	OAK PARK, IL 60302	OAK PARK, IL 60302
5.11.11t, 12 0050 .	01111111111111111111111111111111111111	07H17Hd1, 12 00302
16-07-305-023-1005	16-07-306-001-0000	16-07-306-002-0000
INC GONE 2 PLAYA	MR MRS J KOZLOWSKI	NCS MGMT CO
109-11 S. GROVE	102 S GROVE	P O BOX 5516
OAK PARK, IL 60302	OAK PARK, IL 60302	RIVER FOREST, IL 60305
0.111.11111, 12 00302	0.11.11.11.11.11.11.11.11.11.11.11.11.11	THY EITH OTHER, IE 00000
16-07-306-003-0000	16-07-306-004-0000	16-07-306-005-0000
MARIA C ABREGO	JAYNE ELLEN ERTEL	M HOHMEIER Y LEE
106 S GROVE	110 S GROVE AV 2	114 S GROVE AVE
OAK PARK, IL 60302	OAK PARK, IL 60302	OAK PARK, IL 60302
16.07.206.007.0000	16.07.206.002.2222	16.05.006.000
16-07-306-007-0000	16-07-306-008-0000	16-07-306-009-0000
CSC REAL ESTATE LLC	JAMES CAROLYN WALTER	MICHIKO PERRY
617 BRYANT CIRCLE DR	124 S GROVE	130 S GROVE AVE
PRINCETON, IL 61356	OAK PARK, IL 60302	OAK PARK, IL 60302

16-07-306-010-0000	16-07-306-011-0000	16-07-306-012-0000
SUSAN M ABBATE	BARBARA WESTERMANN	PATRICIA MEDO
132 S GROVE AV	134 S GROVE AV	138 S GROVE AV
OAK PARK, IL 60302	OAK PARK, IL 60302	OAK PARK, IL 60302
16-07-306-013-0000	16-07-306-015-0000	16-07-306-016-0000
JACK W STRAND	NICK SUE BOUDROS	WENESDAY JOURNAL BLDG
140 S GROVE AV	304 S HOME AVE	P O BOX 887
OAK PARK, IL 60302	OAK PARK, IL 60302	OAK PK, IL 60303
16-07-306-017-0000	16-07-306-018-0000	16-07-306-019-0000
HM OPBC LLC	SOAK PARTNERS	AVE BK TR 1408
149-155 S OAK PK AVE	41 CHICAGO AVE	1446 FRANKLIN AV
OAK PARK, IL 60302	OAK PARK, IL 60302	RIVER FOREST, IL 60305
16-07-306-020-0000 CTLTC CT99004063 10 S LASALLE ST #2750 CHICAGO, IL 60603	16-07-306-021-0000 EXEMPT	16-07-306-022-0000 NOT VALID
16-07-306-022-1001	16-07-306-022-1002	16-07-306-022-1003
MICHELLE SWEENEY	MARGARET REUVERS	SHANE D HAYES
116 S GROVE AVE	116 S GROVE B	116 S GROVE AVE #C
OAK PARK, IL 60302	OAK PARK, IL 60302	OAK PARK, IL 60302
16-07-306-022-1004	16-07-400-001-0000	16-07-400-002-0000
ANNE WOINIAKOWSKI	106 PARTNERS LLC	LULLO PROPERTIES LLC
116 S GROVE #D	325 S HOME AVE	721 SOUTH BLVD
OAK PARK, IL 60302	OAK PARK, IL 60302	OAK PARK, IL 60302
16-07-400-007-0000	16-07-400-008-0000	16-07-400-015-0000
OAK PARK TOWNSHIP	CHICAGO PARTNERS 144 L	BOB EUL
105 S OAK PARK AV	136 SOUTH OAK PARK	119 S EUCLID AVE
OAK PARK, IL 60302	OAK PARK, IL 60302	OAK PARK, IL 60302
16-07-400-016-0000	16-07-400-017-0000	16-07-400-018-0000
JAMES BUSHOUSE	S MCNABI M GANGULY	BART LOGIUDICE
120 N OAK PK ATE100	127 S EUCLID	131 S EUCLID AV
OAK PARK, IL 60301	OAK PARK, IL 60302	OAK PARK, IL 60302
16-07-400-028-0000	16-07-400-029-0000	16-07-400-030-0000
NEALIE SHERIDAN	RICHARD E MORRISSY	JOHN JENNIFER RUTH
115 S EUCLID AVE	117 S EUCLID	101 S EUCLID AVE
OAK PARK, IL 60302	OAK PARK, IL 60302	OAK PARK, IL 60302
16-07-400-031-0000	16-07-400-032-0000	16-07-400-033-0000
HIROSHI HASEGAWA	JENNIFER B SMITH	KATHLEEN PLICHTA
103 S EUCLID #A	105A S EUCLID	148 CHESHIRE WAY
OAK PARK, IL 60302	OAK PARK, IL 60302	NAPLES, FL 34110

16-07-400-034-0000	16-07-400-035-0000	16-07-400-036-0000
ALLAN JANICE BALDWIN	BRANDON SCHULMAN	JANET M ROWE
109A S EUCLID	136 S EUCLID	113A S EUCLID
OAK PARK, IL 60302	OAK PARK, IL 60302	OAK PARK, IL 60302
16-07-400-037-0000	16-07-400-038-0000	16-07-400-039-0000
JOHN E CAMPBELL	ROBERT J KOPECKY	R WHITAKER M DYCUS
101 S EUCLID AV #B	103B S EUCLID AVE	105 S EUCLID AVE #B
OAK PARK, IL 60302	OAK PK, IL 60302	OAK PARK, IL 60302
071K171KK, 12 00302	O/IR 1 R, 1L 00302	Olik Place, IE 00302
16-07-400-040-0000	16-07-400-041-0000	16-07-400-042-0000
ROBERT VANLIEDEKERKE	AXELROD JACQUES	STEPHEN MILLER
107 S EUCLID UNIT B	109B S EUCLID	111 B S EUCLID
OAK PARK, IL 60302	OAK PARK, IL 60302	OAK PARK, IL 60302
,	,	,
16-07-400-043-0000	16-07-400-044-1001	16-07-400-044-1002
BURBRIDGE GILLESPIE	MARY SCHMUTTENMAER	QUAN JIANG
113B S EUCLID	150 S OAK PARK 201	1719 HALLMARK DR
OAK PARK, IL 60302	OAK PARK, IL 60302	TROY, MI 48098
16-07-400-044-1003	16-07-400-044-1004	16-07-400-044-1005
RAYMOND W EDGREN	CORNELIUS BARNES	LARISSA HISTOMI
150 S OAK PARK AV #204	150 S OAK PARK AV 206	150 S OAK PARK AVE
OAK PARK, IL 60302	OAK PARK, IL 60302	OAK PARK, IL 60302
OAKTAKK, IL 00302	OAKTAKK, IL 00302	OAKTAKK, IL 00302
16-07-400-044-1006	16-07-400-044-1007	16-07-400-044-1008
BARBARA GILMORE	LIANG MU	NORTH STAR TRUST
2817 E 6TH ST	150 S OAK PARK AVE 205	150 S OAK PARK 203
LONG BEACH, CA 90814	OAK PARK, IL 60302	OAK PARK, IL 60302
	4.5.0	
16-07-400-044-1009	16-07-400-044-1010	16-07-400-044-1011
KEVIN COLLINS	JAMES BOOTHROYO	HAROLD LEON ROBERTS
150 S OAK PARK 301	150 S OAK PARK 302	150 SOUTH OAK PARK AVE
OAK PARK, IL 60302	OAK PARK, IL 60302	OAK PARK, IL 60302
16-07-400-044-1012	16-07-400-044-1013	16-07-400-044-1014
OMAR SHAKER	KATIE MONAHAN	S YANG HONG NING
150 S OAK PARK AVE 306	150 S OAK PARK AV 308	150 S OAK PARK AVE 307
OAK PARK, IL 60302	OAK PARK, IL 60302	OAK PARK, IL 60302
7/11/11/11/11/11/11/11/11/11/11/11/11/11	0711C1711C1C, 1E 00302	07111711dt, 1E 00302
16-07-400-044-1015	16-07-400-044-1016	16-07-400-044-1017
VICTOR G SABBITHI	RODNEY CHAMBERS	RICHARD WARGER
150 S OAK PK AVE 305	150 S OAK PARK AV 303	150 S OAK PK AVE #401
OAK PARK, IL 60302	OAK PARK, IL 60302	OAK PARK, IL 60302
16 07 400 044 1019	16 07 400 044 1010	16 07 400 044 1020
16-07-400-044-1018	16-07-400-044-1019	16-07-400-044-1020
SORIN DANIELA NITOI	PRITESH P PATHAK	JOSEPH A LEO
150 S OAK PARK AV 402	653 JARLATH AVENUE	150 S OAK PARK AV 204

DES PLAINES, IL 60018

OAK PARK, IL 60302

OAK PARK, IL 60302

16.07.400.044.1001	16 07 400 044 1022	16.07.400.044.1022
16-07-400-044-1021	16-07-400-044-1022	16-07-400-044-1023
TIMOTHY M PYLES	GERALDINE MORRISON	JENNIFER L KOETSIER
150 S OAK PARK AVE 408	150 S OAK PARK AV 407	150 S OAK PK AVE 7C
OAK PARK, IL 60302	OAK PARK, IL 60302	OAK PK, IL 60302
16 07 400 044 1024	16.07.401.001.0000	16 07 401 002 0000
16-07-400-044-1024	16-07-401-001-0000	16-07-401-002-0000
JOHN HEFFERNAN	KIEYUL CHUNG	J L K L MARTINEZ
150 S OAK PARK 403	613 N WILLOW RD	110 S EUCLID AVE
OAK PARK, IL 60302	ELMHURST, IL 60126	OAK PARK, IL 60302
16-07-401-006-0000	16-07-401-007-0000	16-07-401-008-0000
JAMES E TOWNSEND	FELIPE ORTEGA	ROXANE MONACO PUCCETTI
647 SOUTH BLVD	101 S WESLEY	103 S WESLEY AVE
OAK PARK, IL 60302	OAK PARK, IL 60302	OAK PARK, IL 60302
16-07-401-009-0000	16-07-401-010-0000	16-07-401-011-0000
COOK CERVANTES	DENNIS P MICHEL	RICHARD TOMILSON
536 HOLLY AVE APT #1	107 WESLEY AVE	114 S EUCLID
SAINT PAUL, MN 55102	OAK PARK, IL 60302	OAK PARK, IL 60302
16-07-401-012-0000	16-07-401-013-0000	16-07-401-014-0000
CHRIS WINE	CHRIS WINE	M L MITCHELL
120 S EUCLID AV	120 S EUCLID	124 S EUCLID AVE
OAK PARK, IL 60302	OAK PARK, IL 60302	OAK PARK, IL 60302
OAKTAKK, IL 00302	OAKTAKK, IL 00302	OAKTAKK, IL 00302
16-07-401-015-0000	16-07-401-016-0000	16-07-401-017-0000
DIANE SCHNEIDER	RAYMOND LISA NEMEC	B K SCHULMAN
126 S EUCLID AVE	130 S EUCLID AV	136 S EUCLID AVE
OAK PARK, IL 60302	OAK PARK, IL 60302	OAK PARK, IL 60302
5/11 / 11 60302	07H 77Hdt, 12 00302	07HT7HH, 12 00302
16-07-401-018-0000	16-07-401-019-0000	16-07-401-020-0000
D V M D SCHACHT	TEDDY SCOTT	STEVEN GILLMAN
140 S EUCLID AVE	115 S WESLEY AV	121 S WESLEY AV
OAK PARK, IL 60302	OAK PARK, IL 60302	OAK PARK, IL 60302
7.11. 17.11dd, 11. 00302	OTHERTHAN, IE 00302	07HC17HCC, 1E 00302
16-07-401-021-0000	16-07-401-022-0000	16-07-401-023-0000
STEVEN GILLMAN	JILL JEROME	MARTIN KLEST
121 WESLEY AV	444 N MICHIGAN AVE 120	129 S WESLEY
OAK PARK, IL 60302	CHICAGO, IL 60611	OAK PARK, IL 60302
OTIC TARK, IL 00302	cinerido, il ocorr	OMCTAKK, IL 00302
16-07-401-024-0000	16-07-401-025-0000	16-07-401-026-0000
PETER MARY BURGI	MADHU GUPTA	CHARLES WILLIAMS
131 S WESLEY AV	16989 EDGEWATER LN	141 WESLEY AV
OAK PARK, IL 60302	HUNTNGTN BCH, CA 92649	OAK PARK, IL 60302
16.05.401.020.0000	16.07.401.020.1001	16.05.401.020.1000
16-07-401-030-0000	16-07-401-030-1001	16-07-401-030-1002
NOT VALID	MARIA CARDONA 101S	KATHARINE ZOE GRAHAM
	653 SOUTH BOULEVARD 101S	653 S BLVD #2015
	OAKPARK II 60302	OAKPARK II 60302

OAK PARK, IL 60302

OAK PARK, IL 60302

16-07-401-030-1003	16-07-401-030-1007	16-07-401-030-1009
MARY BEASLEY	TEODORA AGUILAR	JOEJ PEDIGO
1242 E MARCONI AVE	655 S BLVD #301	655 SOUTH BLVD 101 N
PHOENIX, AZ 85022	OAK PK, IL 60302	OAK PARK, IL 60302
16-07-401-030-1010	16-07-401-030-1011	16-07-401-030-1012
BERNADETTE ZAJAC	ATHANASIOS VAGIAS	E H YUHASZ
655 S BOULEVARD #201N	655 S BLVD 202 N	107 N REINO RD #403
OAK PARK, IL 60302	OAK PARK, IL 60302	NEWBURY PK, CA 91320
16-07-401-031-0000 NOT VALID	16-07-401-031-1001 MARK DUGO 651 SOUTH BLVD #1 OAK PARK, IL 60302	16-07-401-031-1002 IRMA PERALES 651 SOUTH BLVD #2 OAK PARK, IL 60302
16-07-401-031-1003	16-07-401-031-1004	16-07-401-031-1005
D B FLOREK	CYNTHIA DANIELS	TRICIA SHAW
900 N GROVE AVE	651 SOUTH BLVD 4	651 S BOULEVARD #5
OAK PARK, IL 60302	OAK PARK, IL 60302	OAK PARK, IL 60302
16-07-401-031-1006	16-07-401-031-1007	16-07-401-031-1008
ANTHONY T NGUYEN	MARTIN WARD A	MUHAMMAD SHAKUR
651 S BLVD #6	108 W PINE ST	651 S BLVD #8
OAK PARK, IL 60302	BOYNE, MI 49712	OAK PARK, IL 60302
16-07-401-031-1009 ANDREW SARA FREER 651 S BLVD #9 OAK PK, IL 60302	16-07-406-001-0000 EXEMPT	16-07-406-010-0000 CHICAGO TITLE LAND TR 201 S EUCLID AVE OAK PARK, IL 60302

PD Application Item 9 RESTRICTIONS AND COVENANTS

The final CC+R's will be provided by the Developer for review and comment by the Village prior to Village Board Approval. At this time, the Developer has no knowledge of any Restrictions on the property.

PD Application Item 10 CONSTRUCTION SCHEDULE


SCHEDULE OF DEVELOPMENT

After the approval by the Village Board, the process of developing the project will be according to the following schedule:

Milestones schedule of construction

	Months						
	1	3	5	7	13	15	17
Demolition and site prep	X						
Drawings and permits			Χ				
Excavation			Χ				
Foundation			Χ				
Rough Framing				Χ			
Roof				Χ			
Brick and masonry				Χ			
Mechanics rough					Χ		
Drywall					Χ		
Trim and paint							X
Cleaning and Landscaping						Χ	

PD Application Item 11 CONSTRUCTION TRAFFIC SCHEDULE

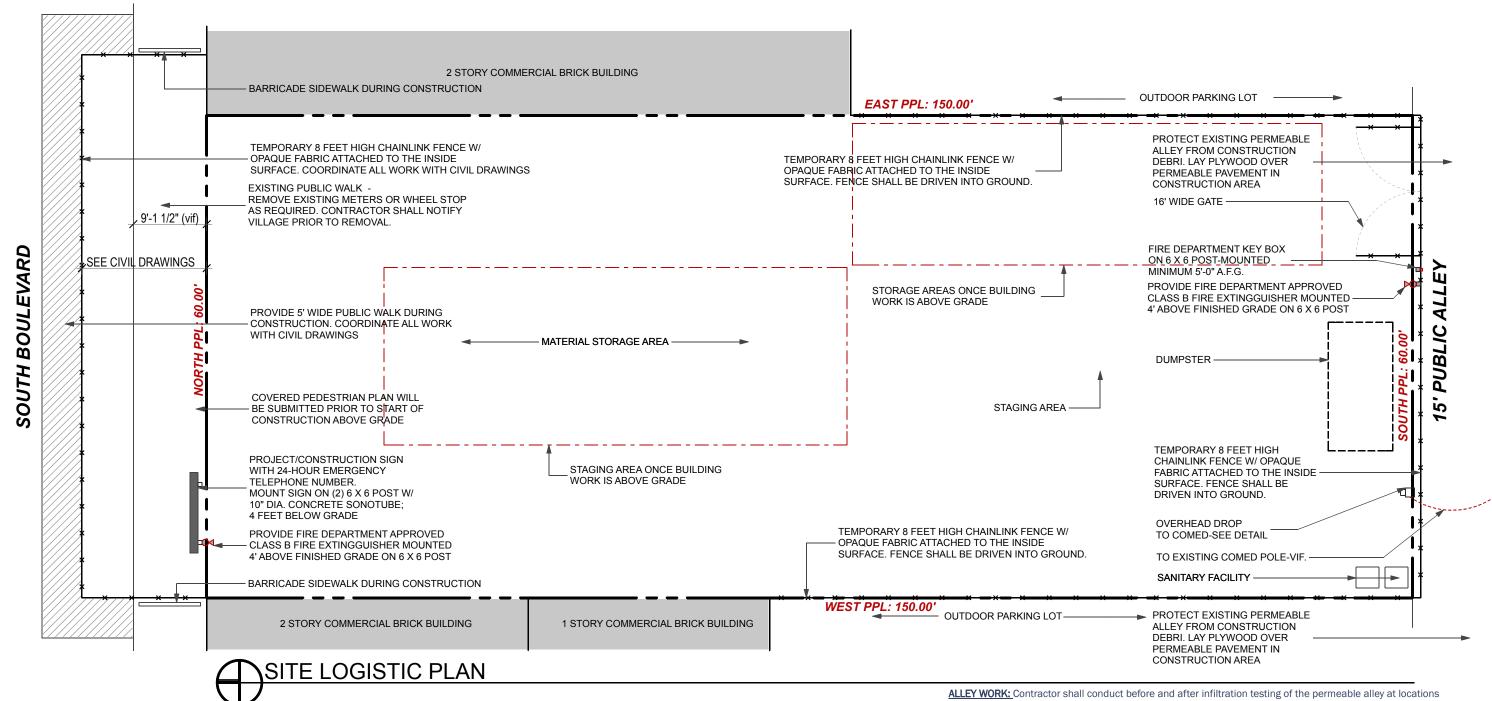

determined by the Village by a testing service approved by the Village of Oak Park, and the contractor shall be responsible for restoring damaged pavers and lost permeability to the alley pavement by methods approved by the Village including but not limited to vacuum sweeping, replacing aggregates, removing and replacing permeable brick pavers and permeable aggregate base course. All contractors doing corrective work on the Village's permeable alley pavements shall be approved by the Village.

john conrad schiess architect

400 Ashland Avenue River Forest Illinois 60305 tel. 708.366.1500

john@jcsarchitect.com

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PROPERTY OWNER:


717 South Boulvard, LLC 3528 Walnut Avenue Wilmette, Illinois 60091 phone: 847-401-2642

Revised for PD | 09.28.16 Submitt for PD | 09.13.16 Revised for Technica I 05.31.16 Issue for Technical 11.13.15 Review Issue for Village 10.21.15

The RESIDENCES at SOUTH BOULEVARD

715-717 S. Boulevard Oak Park, Illinois

Sheet Title CONSTRUCTION TRAFFIC SCHEDULE

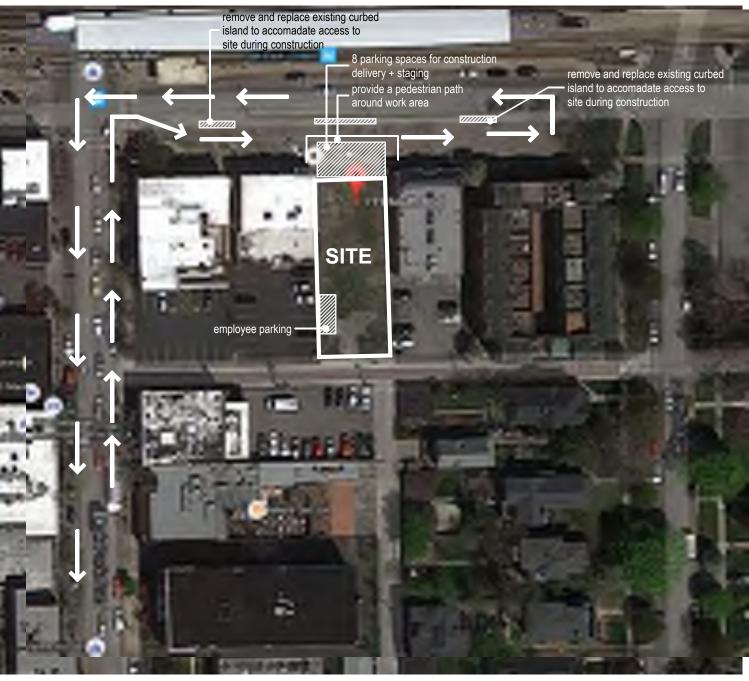

CONSTRUCTION TRAFFIC ROUTE -**coordinate all work with Civil drawings

OCATION + CONSTRUCTION ROUTE + EMPLOYEE PARKING

john conrad schiess architect

400 Ashland Avenue River Forest Illinois 60305 tel. 708.366.1500

john@jcsarchitect.com

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PROPERTY OWNER:

717 South Boulvard, LLC 3528 Walnut Avenue Wilmette, Illinois 60091 phone: 847-401-2642

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Revised for PD	09.29.16				
Submitt for PD	09.13.16				
Revised for Technical					
Review	05.31.16				
Issue for Technica	ıl				
Review	11.13.15				
Issue for Village					
Review	10.21.15				
	Date				

The RESIDENCES at SOUTH BOULEVARD

715-717 S. Boulevard Oak Park, Illinois

Sheet Title CONSTRUCTION ROUTE

PD Application Item 12 MARKET AND FEASIBILITY REPORT

The Market Study by Richard Gloor of Gloor Realty is attached to this report.



GLOOR REALTY CO.

114 NORTH OAK PARK AVENUE • OAK PARK, ILLINOIS 60301 • 708.524.1100 • FAX: 708.524.1286 www.gloor.com

September 28, 2016

To Whom It May Concern:

After reviewing the architectural plans and feature specifications for the development at 717 South Boulevard in Oak Park, here are our findings relative to the Market Study:

- The plans are specific to the buyer profile of empty nesters that have a connection to the Village of Oak Park, have sold their home and want a maintenance-free home in the Village
- 2. The price range of \$425,000 to \$550,000 is an effective way to begin the marketing for these homes. The proposed homes would be in a price range of \$270 \$290 per square foot and would be a great value given the fact that the proposed units at The District House are currently being marketed at \$400 per square foot
- In terms of absorbtion, our current data shows that the market would absorb the proposed 14 units within a 14 to 18 month market time, depending on when the units come to market
- The amenities proposed by the developer are in keeping with the amenities offered both at The District House and at Maple Place Condominiums

In confusion, given the data above, we believe that the proposed development will meet with market success in a reasonable amount of sales time.

Thank you,

Richard C. Gloor Broker/Owner

GLOOR REALTY CO.

QC. Ston

RCG/cjc

PD Application Item 13 TRAFFIC STUDY

Attached is a copy of the Traffic Study.

Trip Generation Assessment

for 715-17 South Boulevard, Oak Park, Illinois

This tables summarize the expected traffic generation by the proposed 14-unit mixed use building at 715-17 South Boulevard in Oak Park, Illinois.

The area traffic information for this report was obtained from a public record, based on the Traffic Impact Study for the proposed District House Development prepared by KLOA and dated 5/10/2016.

Based on the data provided in the ITE Trip Generation Manual, 9th edition (Table 1), the proposed mixed use building is expected to generate 12 trips (combined, entering and exiting) during the morning peak hours and 12 trips during the evening peak hour (Table 2).

Table 1. ITE Trip Generation Manual, 9th Edition Data
Weekday Data

			leckday D	ITE Trip Gen Data			
Land Use	ITE Code	Unit	Time Period	Enter %	Exit %	Rate of Trips per Unit	
Residential Condominiums/ Townhomes (1 to 50)	230	Dwelli ng Units	Daily	50%	50%	5.81	
			AM Generator	19%	81%	0.44	
			PM Generator	64%	36%	0.52	
Medical-Dental	710	KSF	Daily	50%	50%	11.03	
			AM Generator	88%	12%	1.56	
			PM Generator	17%	83%	1.49	
			Daily	50%	50%	36.13	
	720		AM Generator	67%	33%	3.50	
			PM Generator	39%	61%	4.27	
Small Box Store	826	KSF	Daily	50%	50%	44.32	
			AM Generator	48%	52%	6.84	
			PM Generator	56%	44%	5.02	

Table 2. Traffic Generation Calculations

Use Type	ITE	# of	Morning Peak Hour			Evening Peak Hour		
	Code	Units	Enter	Exit	Total	Enter	Exit	Total
Condominium (<50)	230	14	1	5	6	5	3	8
Commercial Use	826	0.85	3	3	6	2	2	4
TOTAL:			4	8	12	7	5	12

It should be noted that, with the convenience of the CTA Green Line train service located steps from the building, there will be non-auto trips generated. Additionally, with the proximity of the building to the Oak Park Downtown, it is possible that some of the residents will walk to their destinations. These potential trip reductions (35%, based on comparison to similar transportation oriented developments (TOD)) were not considered in order to assess the maximum potential traffic impact of the 14-unit condominium building.

Additionally, we considered 3 possible commercial uses (medical office, general office and a small box store) and selected the most intensive use, Small Box Store, for this analyses.

Of the 12 each total morning and evening pick hour about half will be utilizing the alley to the South of the property and the other half will be utilizing South Boulevard.

The traffic impact from the proposed development on the alley traffic, the South Boulevard traffic, Oak Park Avenue traffic and the Oak Park Ave. – South Boulevard intersection is minimal and will not alter the level of service (the ability of the intersection to accommodate traffic) of the Oak Park Ave./South Boulevard intersection.

PD Application Item 14 PARKING STUDY

The Developer hereby requests a waiver from this requirement.

PD Application Item 15 VILLAGE SERVICES

Attached is a copy of the letters from the Police Department, Fire Department and Engineering Department that addresses the impact on Village Services.



November 21, 2016

The Village of Oak Park Village Hall 123 Madison Street Oak Park, Illinois 60302-4272 708.383.6400 Fax 708.383.6692 TTY 708.383.0048 village@vil.oak.park.il.us

Mr. John Schiess John Conrad Schiess Architect, Ltd 400 Ashland Avenue River Forest, Illinois 60305

Re: 717 South Boulevard, Oak Park - Impact on Village Services

Dear Mr. Schiess,

In accordance with the Village of Oak Park's Planned Development submittal requirements, please be advised that to the best of our knowledge the proposed development will not have a negative impact on the Department of Public Works services. Please note that the final locations of the sewer and water service connections to the Villages systems are pending final approval of the Village Engineer.

If you have any questions, please do not hesitate to contact me at (708) 358-5702.

Sincerely,

John P. Wielebnicki, P.E. Director of Public Works Village of Oak Park



The Village of Cak Park Fire Department 100 N. Euclid Avenue Oak Park, Illinois 60301:1404 708.445.3300 Fax 708.383,2495 fire@oak-park.us www.oak-park.us

November 17, 2016

Thomas Ebsen, Fire Chief Village of Oak Park 100 N. Euclid Avenue Oak Park, IL 60301

Re: 717 South Boulevard - Impact on Village Services

Dear Chief Ebsen,

Thank you for taking the time to review the project at The Residences at South Boulevard. In accordance with Village of Oak Park's Planned Development submittal requirements, we seek your acknowledgement that the development will not have a negative impact on the Fire Department. Please sign below to confirm your agreement the development will not have a negative impact on the Fire Department.

Thank you John Conrad Schiess Architect, Ltd., 400 Ashland Avenue, River Forest, IL 60305, or email to john@jcsarchitect.com

Regards,

John Schiess

WOULL USES

Thomas Ebsen, Fire Chief Village of Oak Park, IL Date: 11/17/2016



The Village of Oak Park Village Hall 123 Madison Street Oak Park, Illinois 60302 708.383.6400 Fax 708.383.6692 village@oak.park.us www.oak-park.us

November 17, 2016

Mr. Anthony Ambrose, Police Chief Village of Oak Park 100 N. Euclid Avenue Oak Park, IL 60301

Re: 717 South Boulevard - Impact on Village Services

Dear Chief Ambrose,

Thank you for taking the time to review the project at The Residences at South Boulevard. In accordance with Village of Oak Park's Planned Development submittal requirements, we seek your acknowledgement that the development will not have a negative impact on the Police Department. Please sign below to confirm your agreement the development will not have a negative impact on the Police Department.

Thank you John Conrad Schiess Architect, Ltd., 400 Ashland Avenue, River Forest, IL 60305, or email to john@jcsarchitect.com

Regards,

John Schiess

EXECUTED:

Anthony Ambrose, Police Chief Village of Oak Park, IL Date: | TNOVIO

PD Application Item 16 ENVIRONMENTAL REPORTS

Environmental report as prepared by Anderson Environmental Consulting, Inc. dated December 16, 2016 has been electronically submitted on September 14, 2016.

PD Application Item 17 PERSPECTIVE DRAWINGS



john conrad schiess architect

tel. 708.366.1500

400 Ashland Avenue River Forest Illinois 60305 john@jcsarchitect.com

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The RESIDENCES at SOUTH BOULEVARD

715-717 S. Boulevard Oak Park, Illinois

Sheet Title RENDERING SK3.5



john conrad schiess architect

tel. 708.366.1500

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The RESIDENCES at SOUTH BOULEVARD

715-717 S. Boulevard Oak Park, Illinois

Sheet Title RENDERING SK3.6 PD Application
Item 18
PHOTOS OF SURROUNDING PROPERTIES AND
BUILDINGS







john conrad schiess architect

tel. 708,366,1500

400 Ashland Avenue River Forest Illinois 60305 john@jcsarchitect.com

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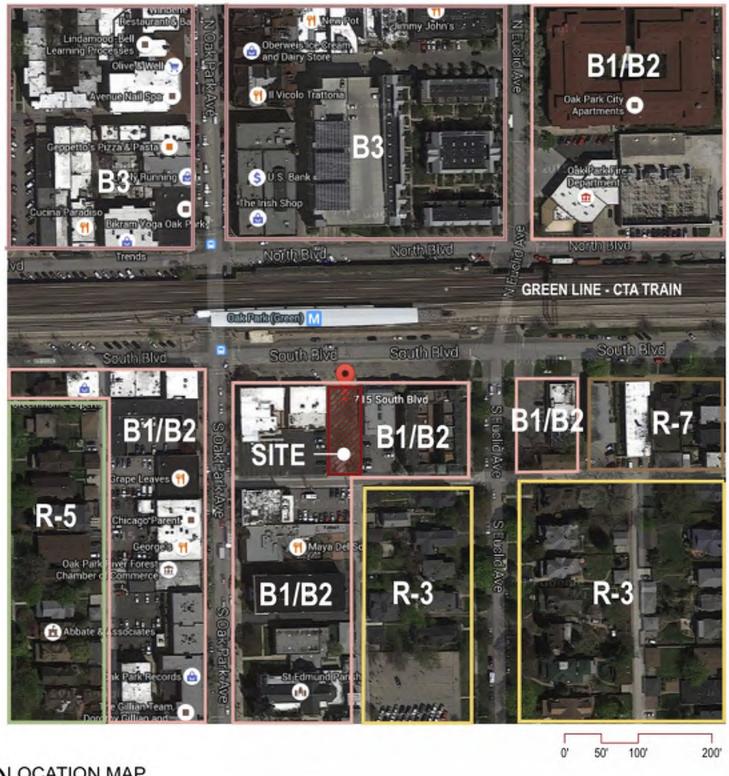
10.21.15

Issue for Village Review

715-717 S. Boulevard Oak Park, Illinois

The RESIDENCES SOUTH BOULEVARD

Sheet Title PHOTOS OF SURROUNDING PROPERTIES AND BUILDINGS PD Application Item 19 LOCATION MAP





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john@jcsarchitect.com

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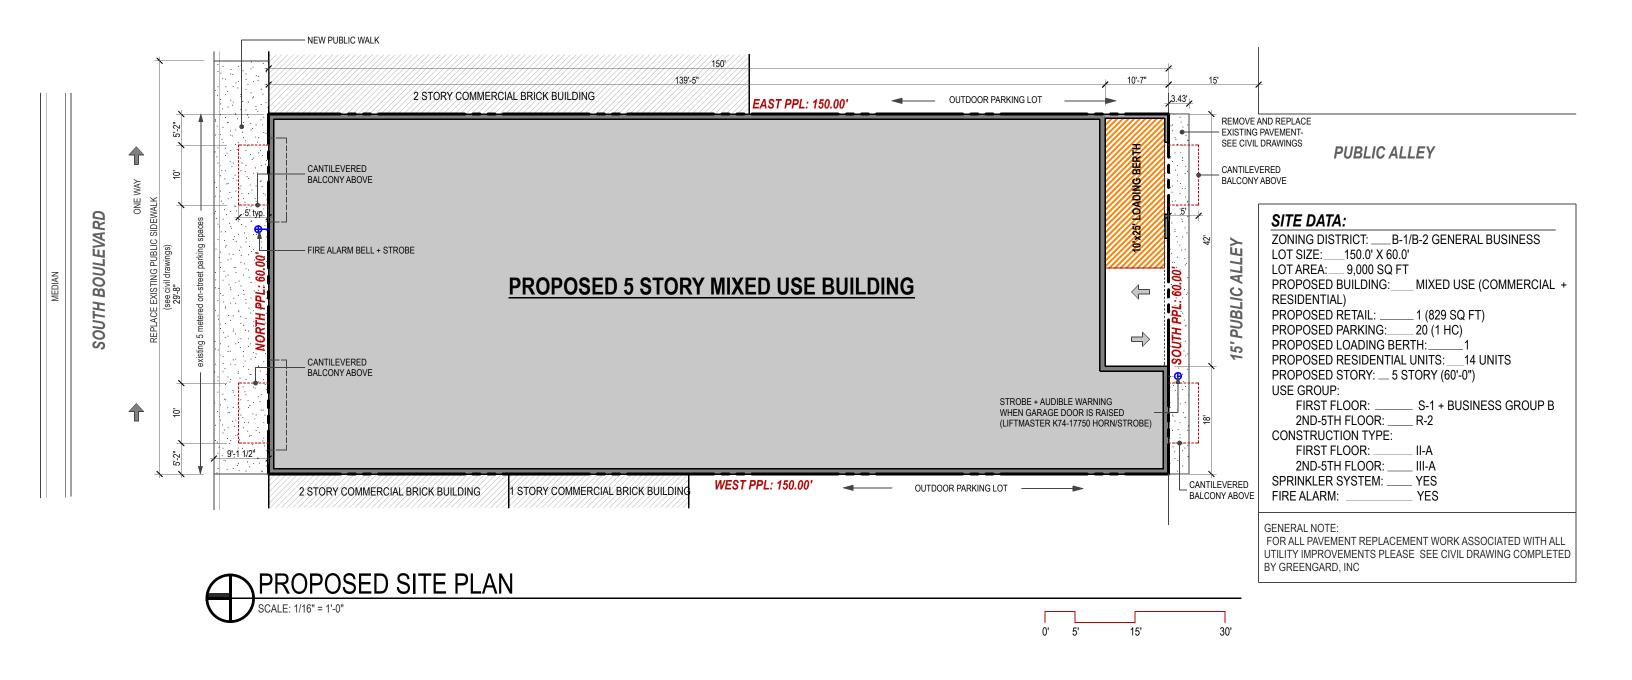
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715-717 S. Boulevard Oak Park, Illinois

Sheet Title The RESIDENCES LOCATION MAP SOUTH BOULEVARD

PD Application Item 20 SITE PLAN



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The RESIDENCES at SOUTH BOULEVARD

715-717 S. Boulevard Oak Park, Illinois

Sheet Title PROPOSED SITE PLAN

PD Application Item 21 LANDSCAPE PLAN



THE HASSLE-FREE INSTANT GREEN ROOF SYSTEM



- SHIPPED FULLY VEGETATED, 10 DAY LEAD TIME
- ❖ « ALL-IN-ONE » TRAY SYSTEM WITH WATER RESERVES
- FAST AND FASY INSTALLATION
- LOW MAINTENANCE
- **WARRANTIES AVAILABLE**









SHIPPED FULLY VEGETATED, 10 DAY LEAD TIME



We recognize that not everyone is a gardener. That is why we believe it is our responsibility to adapt to the building industry, rather than the other way around. Our products are easy to install by people who specialize in building, not plants. Our systems are easy to maintain, and we provide tools to support building owners in long-term maintenance in order to create long lasting healthy green roofs. HYDROPACK® is pre-grown at our facility and shipped fully vegetated to the job site.

« ALL-IN-ONE » TRAY SYSTEM WITH WATER RESERVES

- ▶ HYDROPACK® contains all of the components of a multilayer vegetation system, i.e. drainage, filter and substrate layers (specifically designed for rooftop conditions) as well as the pre-vegetated plant cover!
- ▶ HYDROPACK® includes a **permanent water reserve** that manages rainfall on the roof by absorbing and retaining water, making it ideal for both wet and dry climates. When full, our modules drain excess water efficiently while the system continues to smooth rainfall runoff peaks.

AVAILABLE WITH A RANGE OF PLANT MIXES

• Our plant mixes always come pre-vegetated with coverage of at least 95% from the date of the installation. 3 plant mix options are available; a standard low-maintenance plant mix, an accented blend, or a fully customizable option.





FAST AND EASY INSTALLATION

HYDROPACK, A CONSTRUCTION PRODUCT MADE FOR CONTRACTORS

- Stock of fully vegetated ready to ship modules
- Shipped on flat bed
- Packaged on skids
- Free installation support from our team

HYDROPACK'S FEATURES THAT YOU LIKE

- Clipping system to secure the modules together
- ◆ Efficient drainage of excess water to avoid ponding on the waterproofing membrane
- Strong and thin tray edges make metal edging uncecessary
- ◆ HYDROPACK® modules are always removable, even after many years, if access to the membrane is needed
- ◆ The plants are fully established the day of installation, the plants will not fail before closing the project
- All-in-one module contains all the layers of a green roof
- Water reserves that decrease irrigation needs in the summer months
- Easy to cut trays, make HYDROPACK® flexible to fit unique designs
















	SPECIFIC <i>I</i>	ATIONS			
DIMENSION	Nominal dimensions per unit produced	2 ft. x 1.3 ft. x 4 inch.	600 x 400 x 100 mm		
	Actual dimensions	23 ^{5/8} " x 15 ^{3/4} "			
MATERIAL	Tray	black 100% recycled HDPE			
	Filter fabric	Non-woven 3 oz. sq. ft.	Non-woven 100 g / m ²		
	Growing media	FLL compliant, adapted to Nor	rth America		
	Vegetation	3 options: Standard / Accent /	Custom		
STORM	Water reserve (ASTM E2398)	0.22 gal. per sq. ft.	9 liters / m ²		
WATER MANAGE-	Max. water retention capacity (ASTM E2397)	0.83 gal. per sq. ft. (1.3" rain)	34 liters / m ²		
MENT	Runoff Coefficient (UWM research)	0.3 average			
DDAINACC	Number of drainage holes	47 holes (Ø 3/8") per sq. ft.	500 holes (Ø 9 mm) / n		
DRAINAGE	Drainage clearance above the membrane	1.2 inch.	30 mm		
	Dry weight (ASTM E2397)	15 lbs. per sq. ft.	75 kg / m ²		
WEIGHT	Fully saturated max. weight	22 lbs. per sq. ft.	108 kg / m ²		
WEIGHT	Dead load (ASTM E2397)	22 lbs. per sq. ft.	108 kg / m ²		
	Live Load (ASTM E2397)	1 lbs. per sq. ft.	5.55 kg / m ²		
Wind uplift using guidelines from ANSI/SPR RP-14		Hydropack is a Ballast #2. The trays are interlocki and for more protection can be fasten together with Uresistant zip ties. Wind tunnel test under work.			

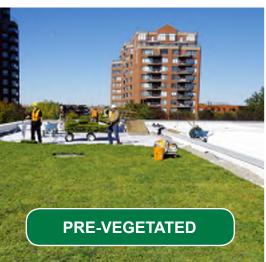

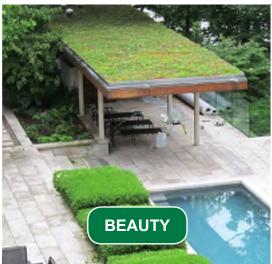



WORKING WITH VEGETAL I.D. IS THE INSURANCE OF WORKING WITH PEOPLE THAT CARE FOR YOUR PROJECT, AND YOUR SUCCESS.

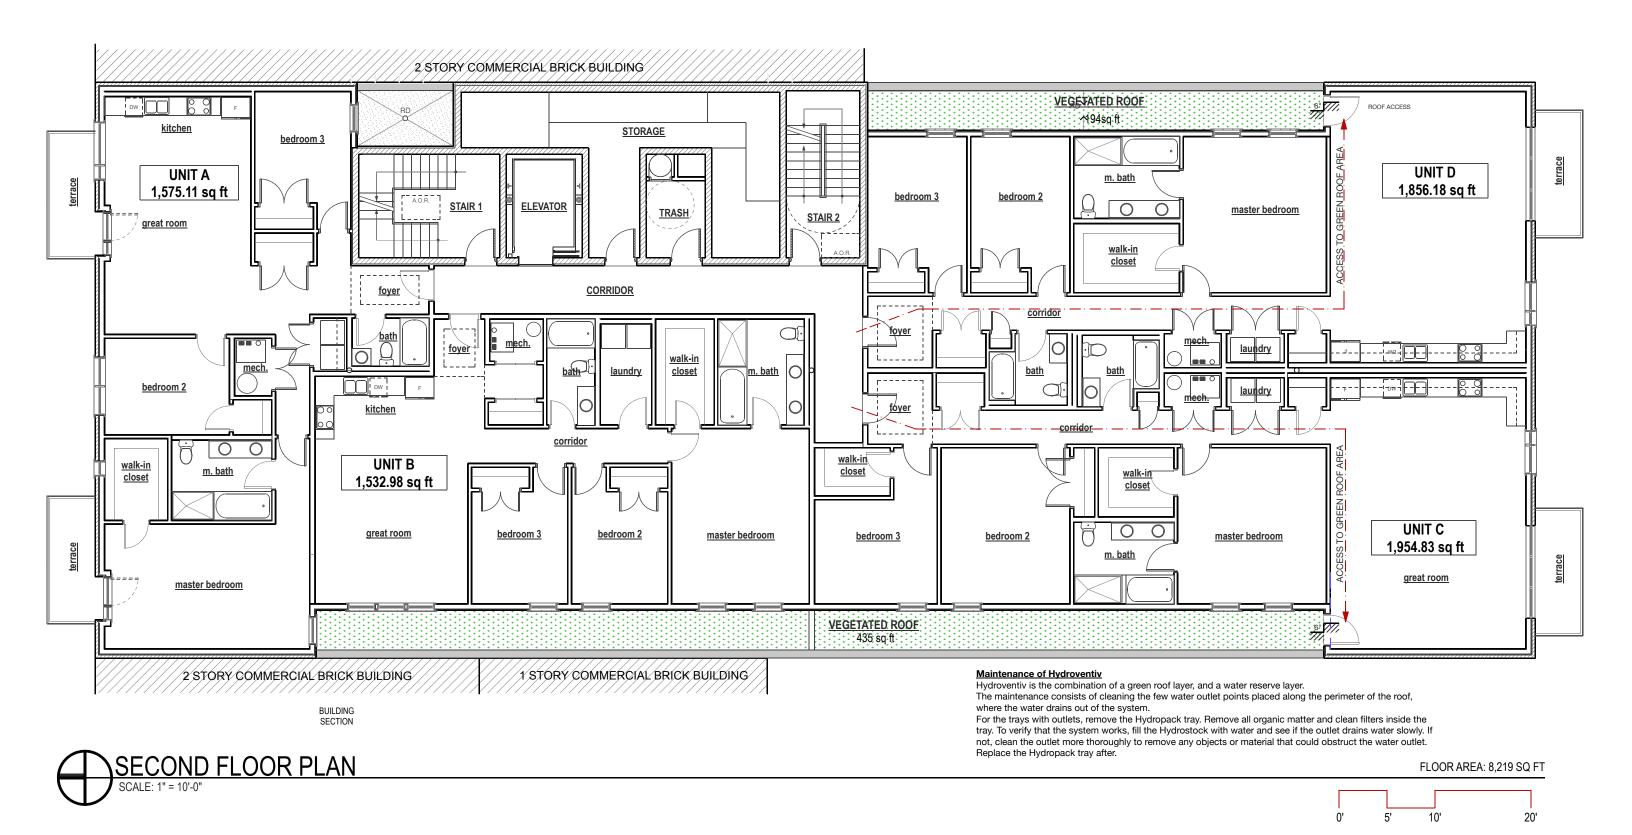

400 Ashland Avenue River Forest Illinois 60305 tel. 708.366.1500

john@jcsarchitect.com

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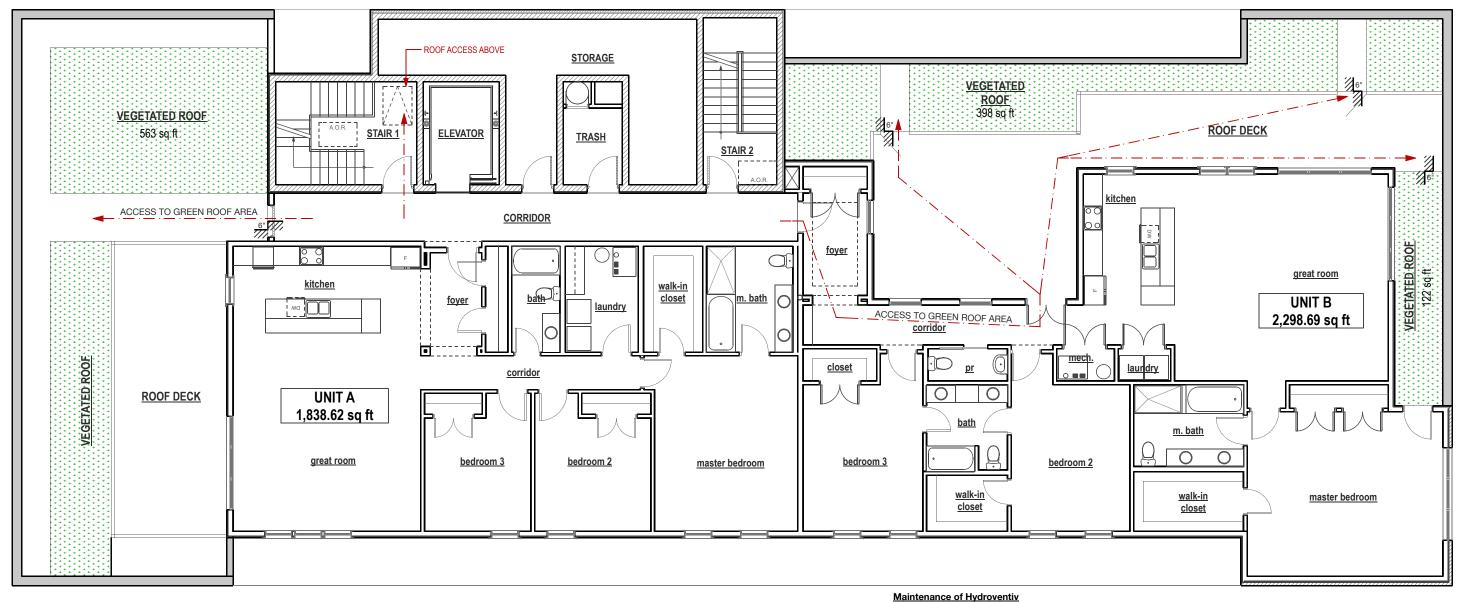
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The RESIDENCES at SOUTH BOULEVARD

715-717 S. Boulevard Oak Park, Illinois

Sheet Title LANDSCAPING PLAN



Hydroventiv is the combination of a green roof layer, and a water reserve layer.

The maintenance consists of cleaning the few water outlet points placed along the perimeter of the roof, where the water drains out of the system.

For the trays with outlets, remove the Hydropack tray. Remove all organic matter and clean filters inside the tray. To verify that the system works, fill the Hydrostock with water and see if the outlet drains water slowly. If not, clean the outlet more thoroughly to remove any objects or material that could obstruct the water outlet. Replace the Hydropack tray after.



20'

john conrad schiess architect

400 Ashland Avenue River Forest Illinois 60305 tel. 708.366.1500

john@jcsarchitect.com

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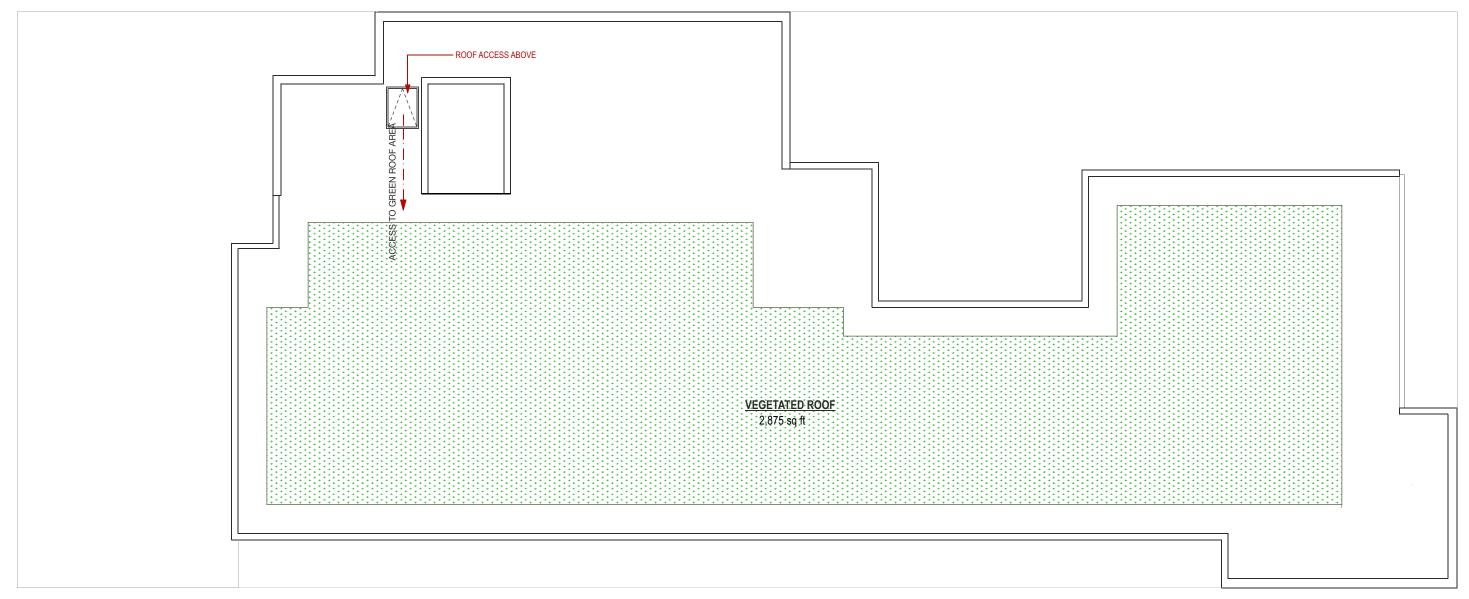
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The RESIDENCES at SOUTH BOULEVARD

715-717 S. Boulevard Oak Park, Illinois

Sheet Title LANDSCAPING PLAN

FLOOR AREA: 5.380 SQ FT



Maintenance of Hydroventiv

Hydroventiv is the combination of a green roof layer, and a water reserve layer.

The maintenance consists of cleaning the few water outlet points placed along the perimeter of the roof, where the water drains out of the system.

For the trays with outlets, remove the Hydropack tray. Remove all organic matter and clean filters inside the tray. To verify that the system works, fill the Hydrostock with water and see if the outlet drains water slowly. If not, clean the outlet more thoroughly to remove any objects or material that could obstruct the water outlet. Replace the Hydropack tray after.

ROOF AREA: 5,394 SQ FT



john conrad schiess architect

tel. 708.366.1500

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john@jcsarchitect.com

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The RESIDENCES at SOUTH BOULEVARD

715-717 S. Boulevard Oak Park, Illinois

Sheet Title LANDSCAPING PLAN

PD Application Item 22 DETAILED SIGN ELEVATIONS

Given the design of the proposed building and nature of it's intended use, the Applicant hereby requests a waiver from this requirement.

PD Application Item 23 BUILDING ELEVATIONS



PROPOSED NORTH ELEVATION

john conrad schiess architect @ 2015

john conrad schiess architect

400 Ashland Avenue River Forest Illinois 60305 tel. 708.366.1500

john@jcsarchitect.com

SCALE: 1/8" = 1'-0"

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The RESIDENCES at SOUTH BOULEVARD

715-717 S. Boulevard Oak Park, Illinois



PROPOSED WEST ELEVATION

SCALE NTS

EXTERIOR FINISH LEGEND:

- 01. EXISTING 2 STORY MASONRY BUILDING @ FOREGROUND 02. CANTILEVERED METAL BALCONY W/ TEMPERED GLASS PANEL SYSTEM
- 03. PRE-FINISH HARDIE CEMENT BOARD SIDING OR SIMILAR. COMPARABLE MATERIAL (COLOR #1)
- 04. MASONRY UNIT (COLOR #2) 05. PRECAST STONE BAND(COLOR #3)
- 06. EXTERIOR DOOR WITH METAL GUARDRAIL
- 07. ALUMINUM COPING
- 08. PRE-FINISH HARDIE CEMENT BOARD BAND OR SIMILAR COMPARABLE MATERIAL (COLOR #2)
- 09. MASONRY UNIT (COLOR #1)
- 10. PRE-FINISH HARDIE CEMENT BOARD SIDING OR SIMILAR COMPARABLE MATERIAL(COLOR #3)
- 11. WOOD CLAD CASEMENT WINDOW
- 12. PRE-FINISH HARDIE CEMENT PANEL OR SIMILAR COMPARABLE MATERIAL (COLOR #2)

john conrad schiess architect

400 Ashland Avenue River Forest Illinois 60305 tel. 708,366,1500

john@jcsarchitect.com

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The RESIDENCES SOUTH BOULEVARD

715-717 S. Boulevard Oak Park, Illinois



PROPOSED EAST ELEVATION

EXTERIOR FINISH LEGEND:

- 01. EXISTING 2 STORY MASONRY BUILDING @ FOREGROUND 02. CANTILEVERED METAL BALCONY W/ TEMPERED GLASS PANEL SYSTEM
- 03. PRE-FINISH HARDIE CEMENT BOARD SIDING OR SIMILAR COMPARABLE MATERIAL(COLOR #1)
- 04. MASONRY UNIT (COLOR #2)
- 05. PRECAST STONE BAND(COLOR #3)
- 06. EXTERIOR DOOR WITH METAL GUARDRAIL
- 07. ALUMINUM COPING
- 08. PRE-FINISH HARDIE CEMENT BOARD BAND OR SIMILAR COMPARABLE MATERIAL (COLOR #2)
- 09. MASONRY UNIT (COLOR #1)
- 10. PRE-FINISH HARDIE CEMENT BOARD SIDING OR SIMILAR COMPARABLE MATERIAL (COLOR #3)
- 11. WOOD CLAD CASEMENT WINDOW
- 12. PRE-FINISH HARDIE CEMENT PANEL OR SIMILAR COMPARABLE MATERIAL (COLOR #2)

john conrad schiess architect

400 Ashland Avenue River Forest Illinois 60305 tel. 708,366,1500

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The RESIDENCES SOUTH BOULEVARD

715-717 S. Boulevard Oak Park, Illinois



PROPOSED SOUTH ELEVATION

SCALE: 1/8" = 1'-0"

John conrad schiess architect @ 2015

john conrad schiess architect

400 Ashland Avenue River Forest Illinois 60305 tel. 708,366,1500

john@jcsarchitect.com

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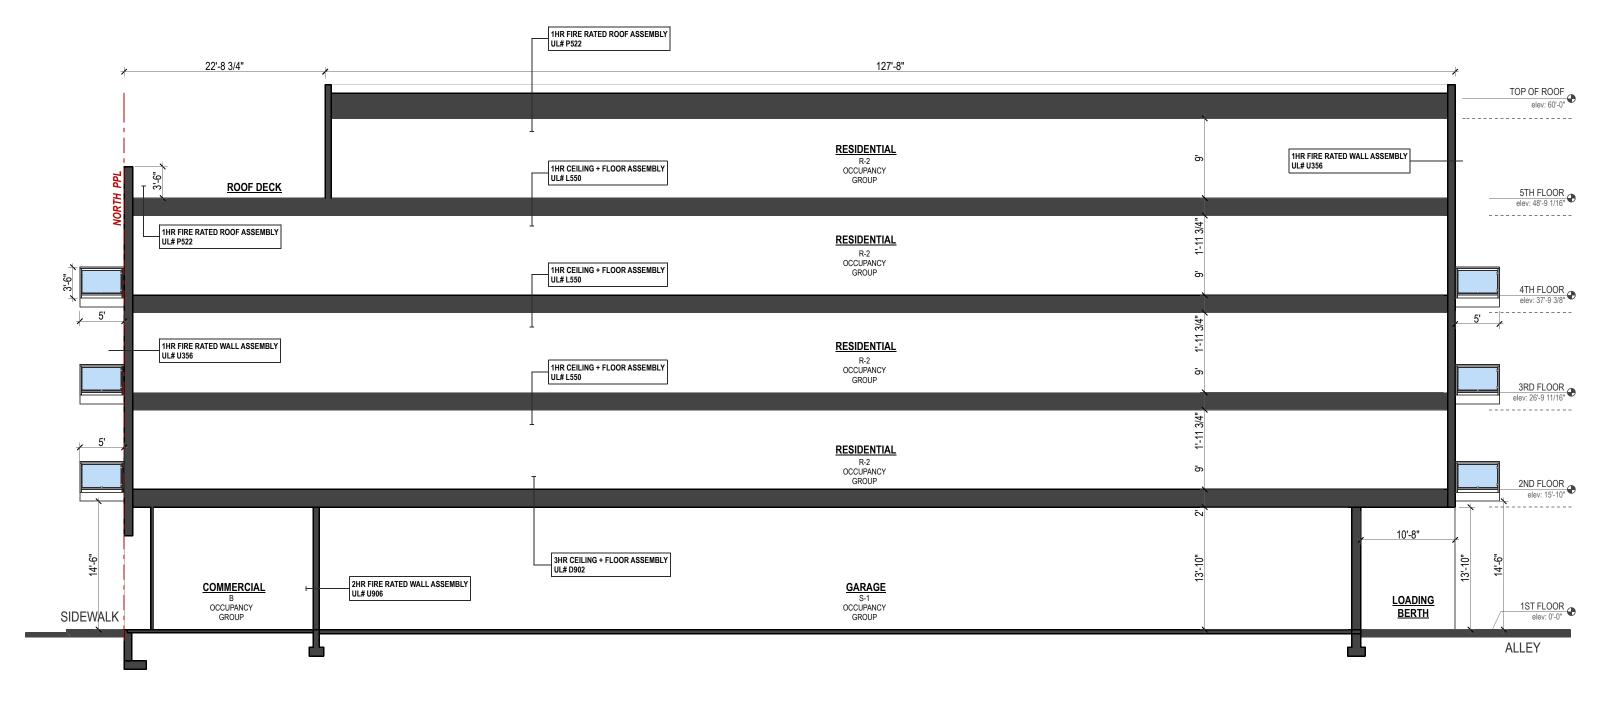
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The RESIDENCES SOUTH BOULEVARD

715-717 S. Boulevard Oak Park, Illinois



SCHEMATIC BUILDING SECTION



john conrad schiess architect

400 Ashland Avenue River Forest Illinois 60305
tel. 708.366.1500 | john@jcsarchitect.com

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 PROPERTY OWNER:
 Revised for PD | 10.04.16

 717 South Boulvard, LLC
 Revised for PD | 109.29.16

 3528 Walnut Avenue
 Submitt for PD | 09.13.16


 Wilmette, Illinois 60091 phone: 847-401-2642
 Revised for Technical Review | 05.31.16

 Revised for Technical Review | 05.31.16
 Revised for Technical Review | 05.17.16

 Issue for Technical Review | 02.08.16
 Review | 02.08.16

Sheet Title
BUILDING SECTION

Sheet No.

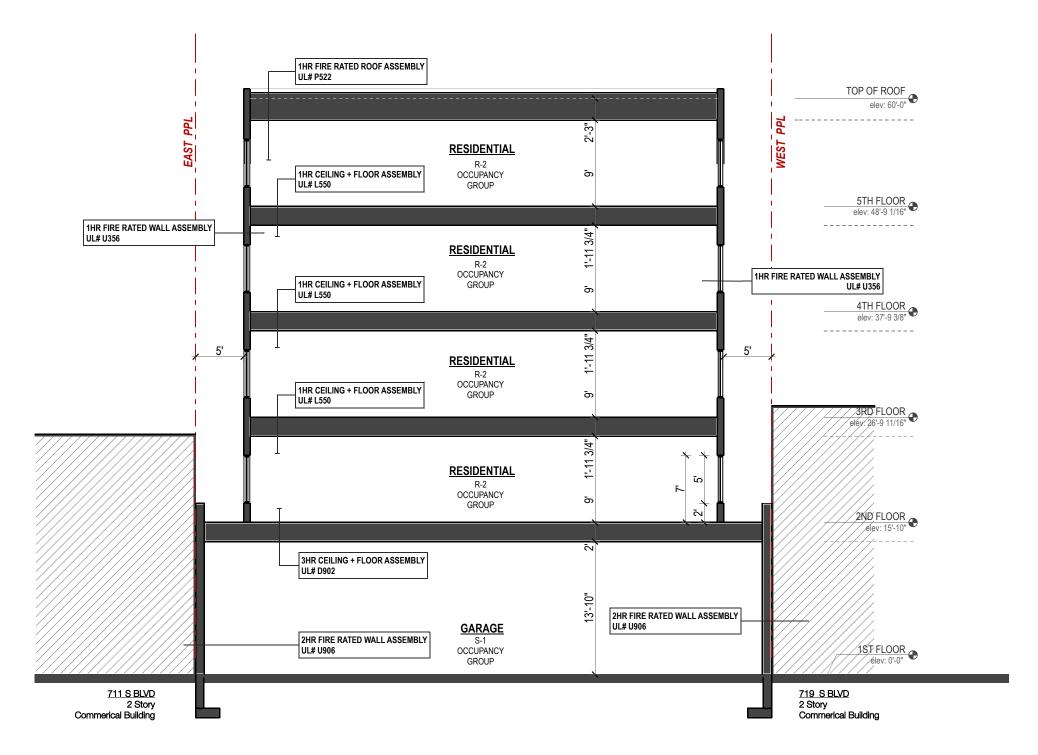

SCHEMATIC BUILDING SECTION



john conrad schiess architect

400 Ashland Avenue River Forest Illinois 60305 tel. 708.366.1500

john@jcsarchitect.com

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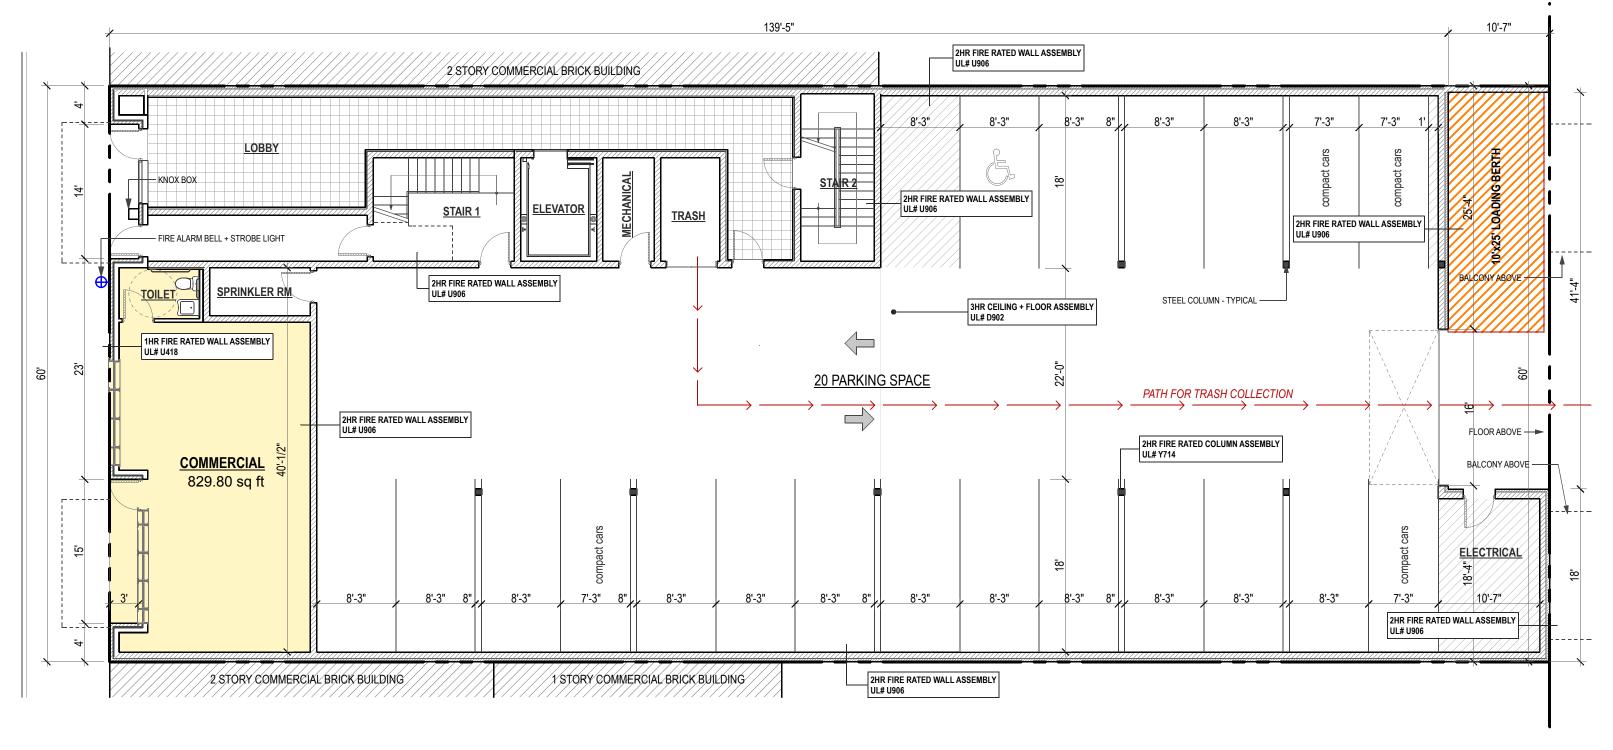
Revised for PD 09.29.16 Submitt for PD 09.13.16 Revised for Technical 05.31.16 Review Revised for Technical 05.17.16 02.08.16 Issue for Technical 11.13.15 Review

The RESIDENCES at SOUTH BOULEVARD

715-717 S. Boulevard Oak Park, Illinois

Sheet Title **BUILDING SECTION** PD Application Item 24 FLOOR PLANS

In response to a clarification regarding the trash and recycling pick up route, please see SK1.1 revised.







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john@jcsarchitect.com

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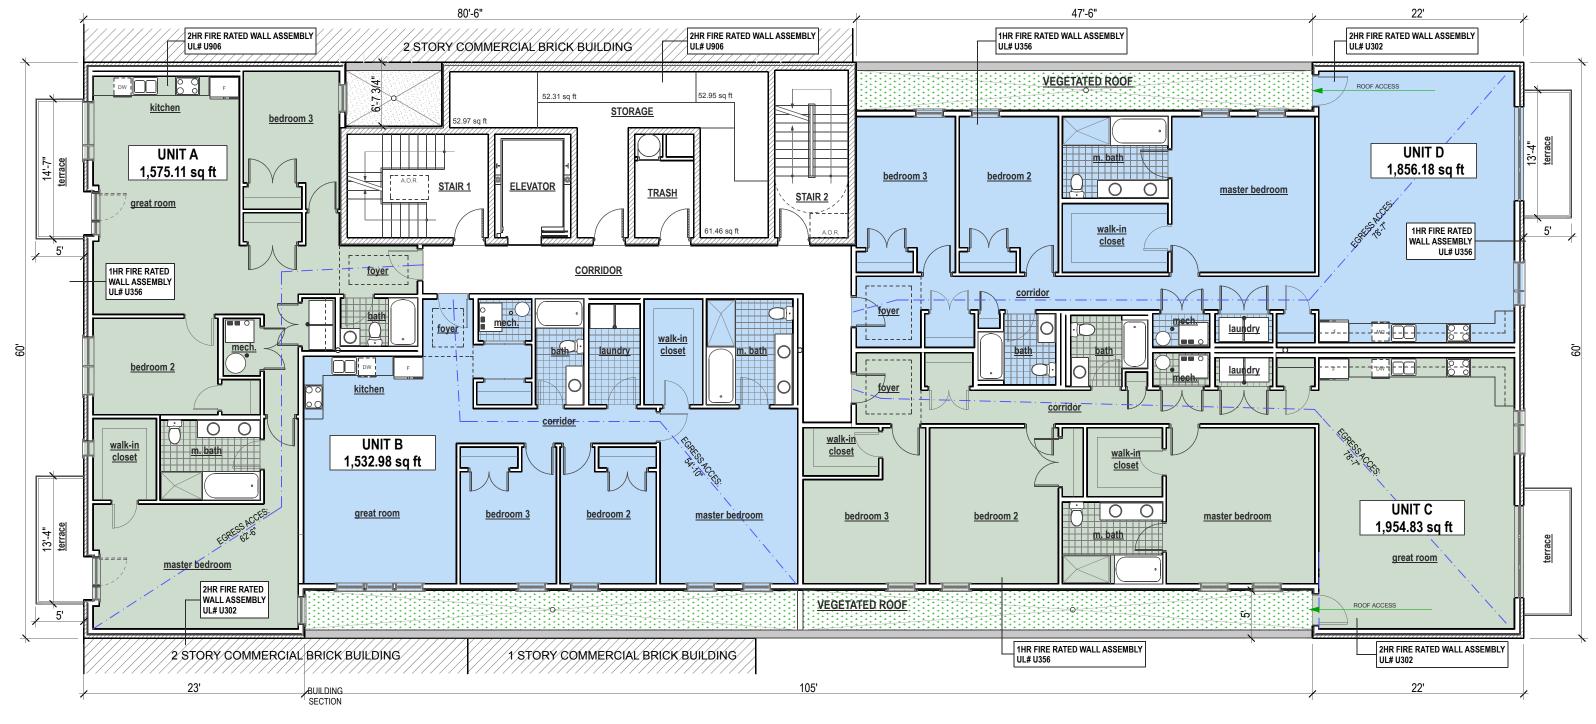
PROPERTY OWNER: 717 South Boulvard, LLC

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Revised for PD	10.04.16
Revised for PD	09.29.16
Submitt for PD	09.13.16
Revised for Technic Review	oal 05.31.16
Revised for Technic Review	cal 05.17.16
Issue for Technical	
Review	02.08.16
	Date

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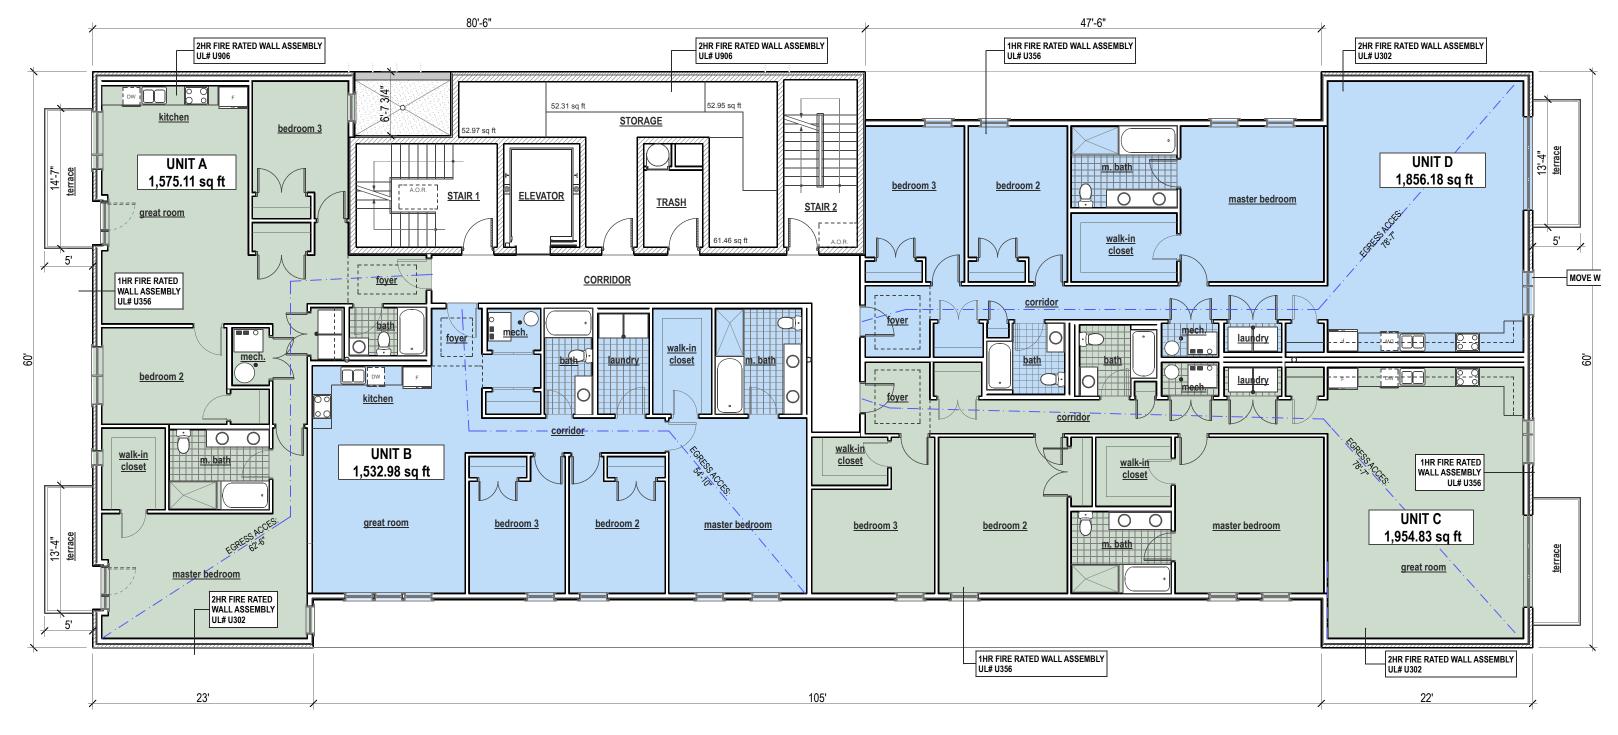
PROPERTY OWNER:

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Submitt for PD | 09.13.16 Revised for Technical 05.31.16 Review Revised for Technical Review Issue for Technical 05.17.16 Review 02.08.16 Issue for Technical 11.13.15 Issue for Village 10.21.15 Review Date

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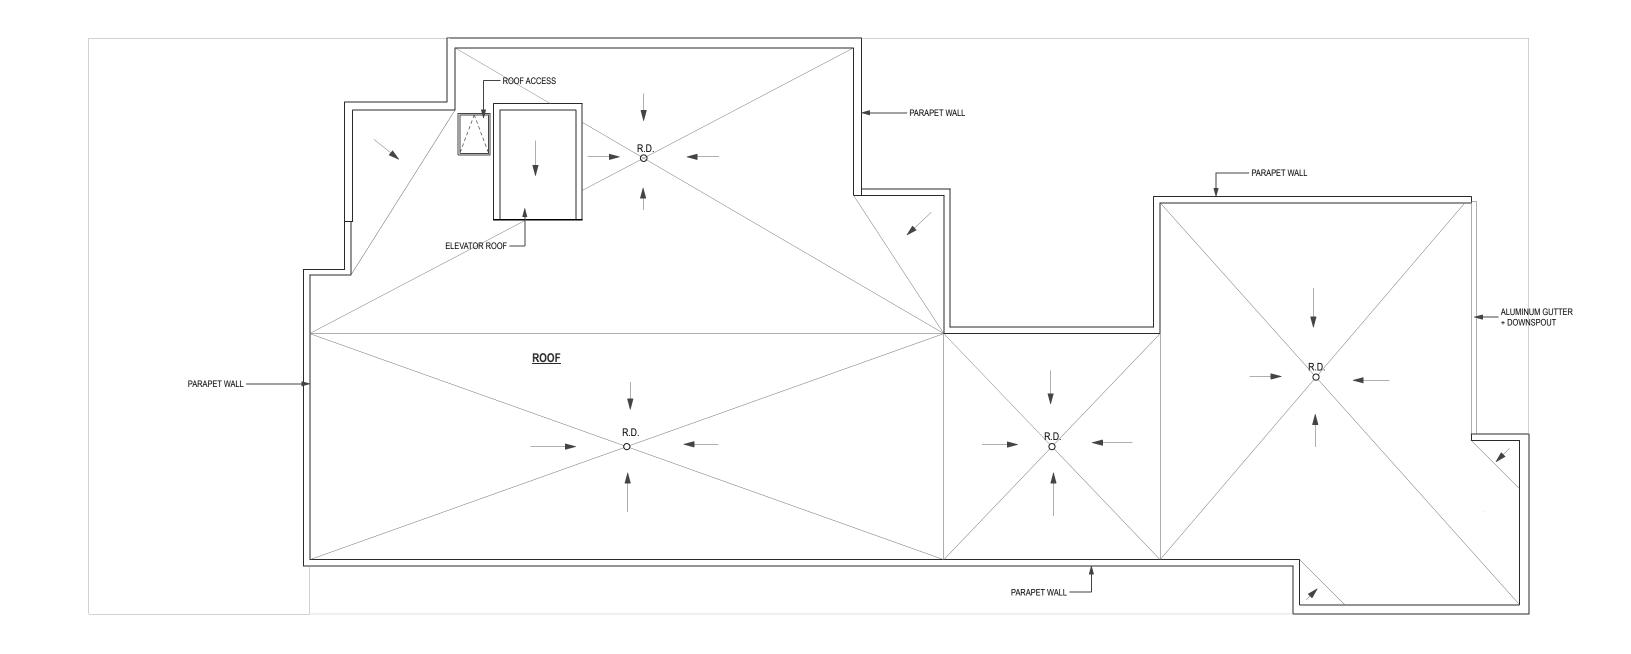
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Submitt for PD | 09.13.16 Revised for Technical 05.31.16 Review Revised for Technical 05.17.16 Review Issue for Technical 02.08.16 Review Issue for Technical 11.13.15 Review Issue for Village 10.21.15 Review Date

The RESIDENCES SOUTH BOULEVARD

715-717 S. Boulevard Oak Park, Illinois





ROOF AREA: 5,394 SQ FT 20'

john conrad schiess architect

tel. 708.366.1500

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PROPERTY OWNER:

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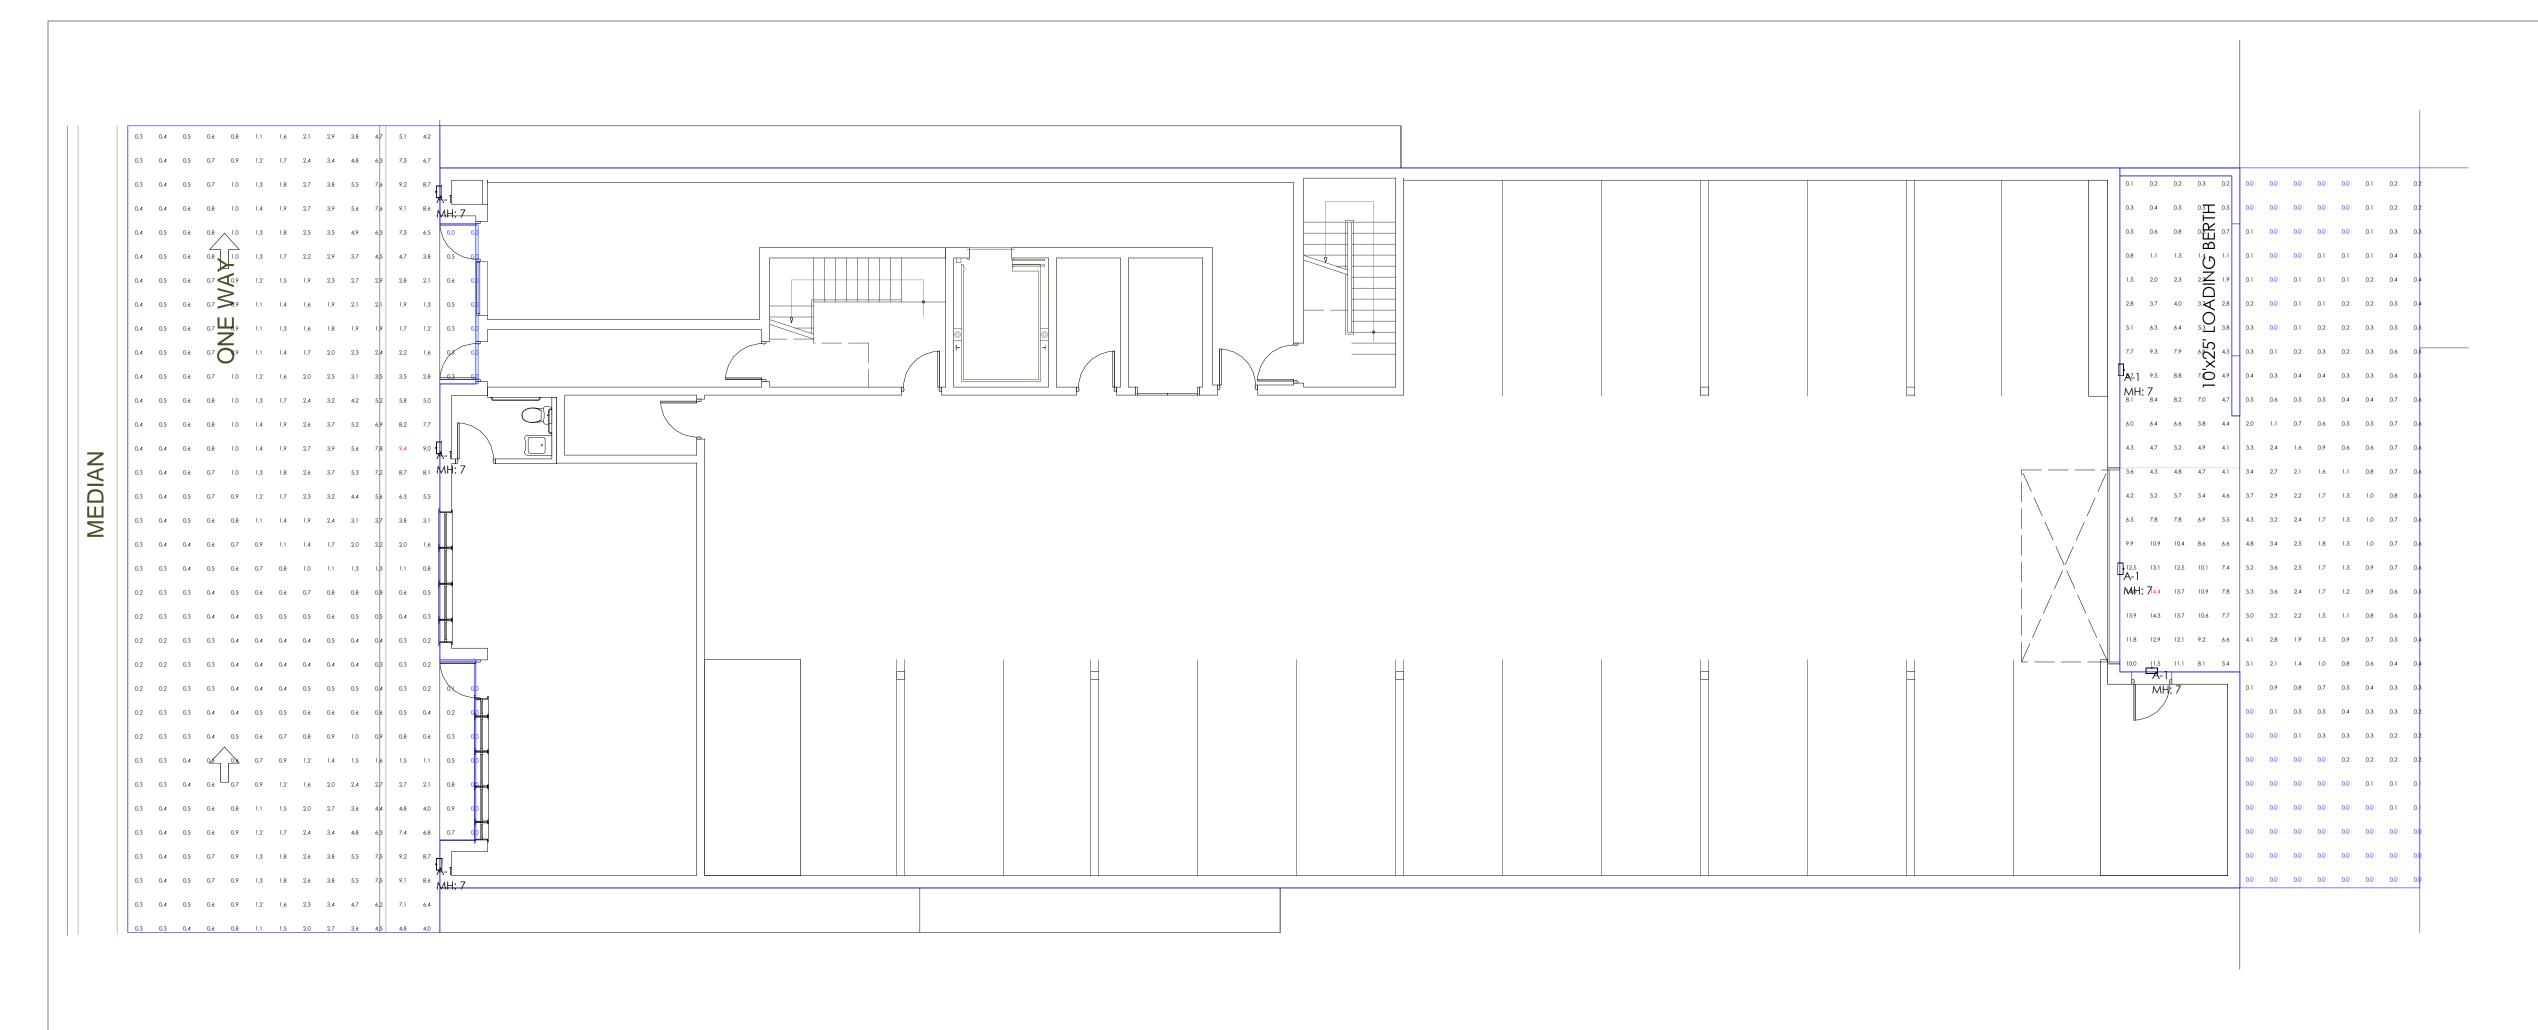
Submitt for PD | 09.13.16 Revised for Technical Review Issue for Technical 05.31.16 Review 02.08.16 Issue for Technical 11.13.15 Issue for Village 10.21.15 Review Date

The RESIDENCES at SOUTH BOULEVARD

715-717 S. Boulevard Oak Park, Illinois

Sheet Title **ROOF PLAN**

PD Application Item 25 EXTERIOR LIGHTING PLAN




Luminaire Sc	chedule					
Symbol	Qty	Label	Arrangement	Total Lamp Lumens	LLF	Description
	6	A-1	SINGLE	N.A.	0.900	BPM-L35_0-100-277v-CGL-BZ-40K

Room Summary
Label Type Wall Ht. Description


Calculation Summary									
Label	CalcType	Units	Avg	Max	Min	Avg/Min	Max/Min	Description	
15' Public Alley_15' Public A	Illuminance	Fc	2.34	14.4	0.0	N.A.	N.A.	Readings @ grade	
South Boulevard Planar	Illuminance	Fc	1.79	9.4	0.0	N.A.	N.A.	Readings @ grade	



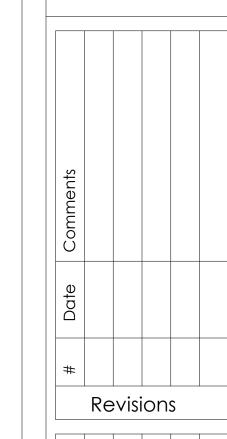

715-717 South Boulevard
Project Address

Page 1 of 1

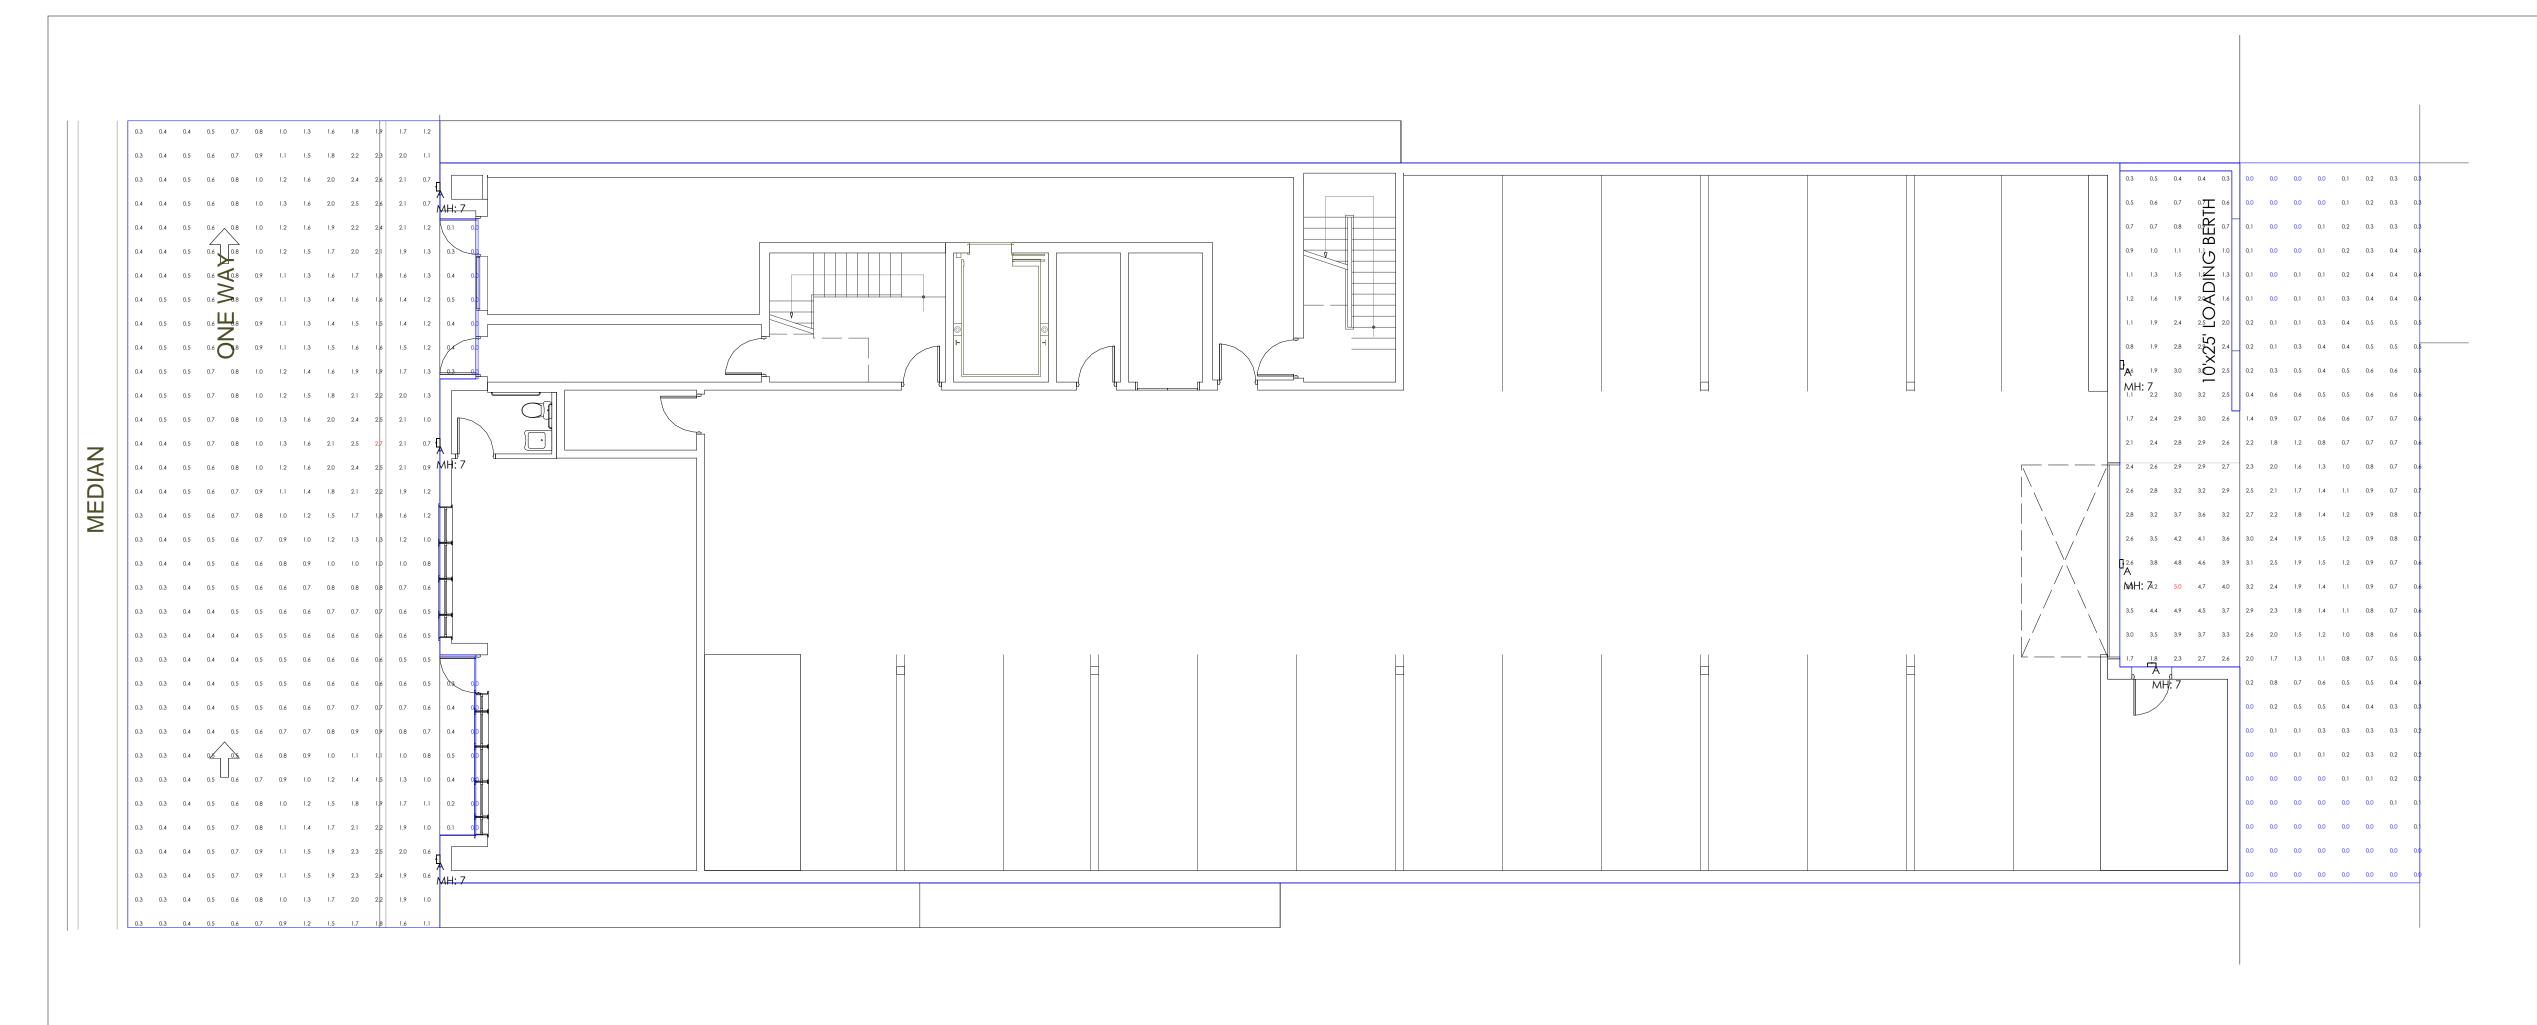

Lumir	naire Sc	hedule					
Symb	ool	Qty	Label	Arrangement	Total Lamp Lumens	LLF	Description
]	6	A	SINGLE	N.A.	0.900	GRDW-24-L36_5-WAL-TB-30K

Room Summary
Label Type Wall Ht. Description

Calculation Summary									
Label	CalcType	Units	Avg	Max	Min	Avg/Min	Max/Min	Description	
15' Public Alley_15' Public A	Illuminance	Fc	1.16	5.0	0.0	N.A.	N.A.	Readings @ grade	
South Boulevard Planar	Illuminance	Fc	0.92	2.7	0.0	N.A.	N.A.	Readinas @ arade	




	Comments					
	Date					
	#					
		Re	visi	on	S	

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	Drawn By: Chris Collins			
	/: Chr	Date:6/7/2016	-8	
	IWN By	le:6/7	Scale: 1" = 8'	
	Dra	Dat	Scc	

715-717 South Boulevard
Project Address

Page 1 of 1

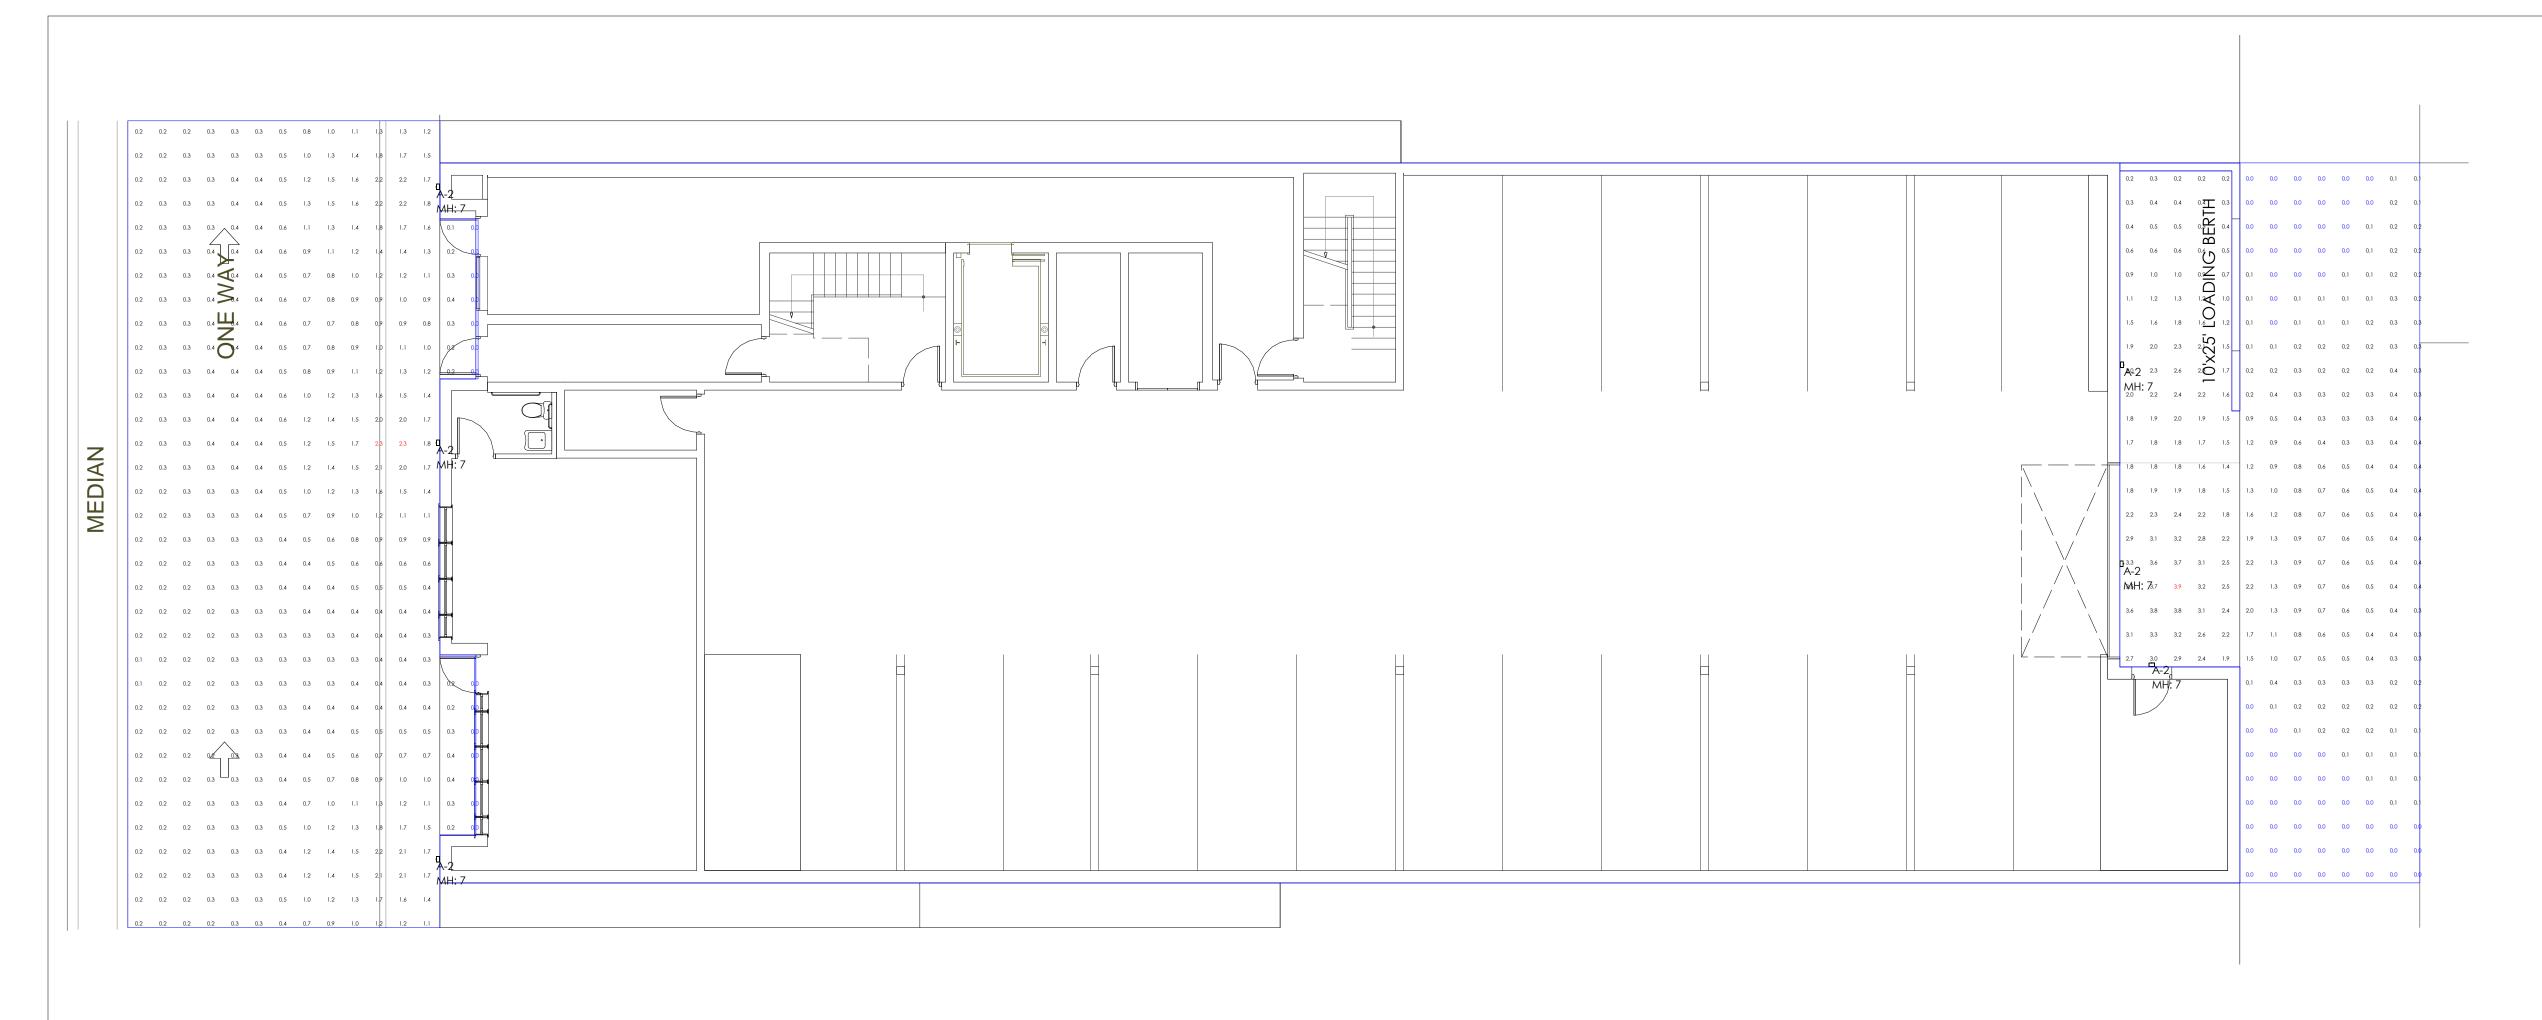


Luminaire Sc	chedule					
Symbol	Qty	Label	Arrangement	Total Lamp Lumens	LLF	Description
	6	A-2	SINGLE	N.A.	0.900	CAC-L29_4-100-277V-51K

Room Summary
Label Type Wall Ht. Description

Calculation Summary								
Label	CalcType	Units	Avg	Max	Min	Avg/Min	Max/Min	Description
15' Public Alley_15' Public A	Illuminance	Fc	0.79	3.9	0.0	N.A.	N.A.	Readings @ grade
South Boulevard Planar	Illuminance	Fc	0.62	2.3	0.0	N.A.	N.A.	Readings @ grade



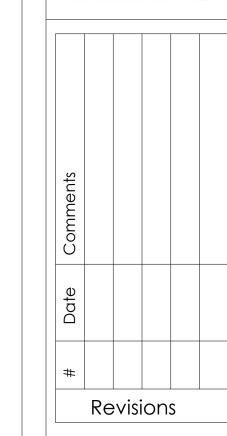

			, , , , ,	<u> </u>	
	Drawn By: Chris Collins	Date:6/7/2016	Scale: 1" = 8'		

715-717 South Boulevard
Project Address

Page 1 of 1



ARCHITECTURAL OUTDOOR

GUARDIAN W LED



PROJECT:


TYPE:

ORDERING #:

COMMENTS:

FEATURES

- Extruded Aluminum Housing w/ Matte Silver Polyester Powder Coat Finish
- · Aluminum Fascia w/ Matte Silver Polyester Powder Coat Finish
- Die Cast Aluminum End Caps w/ Matte Silver Polyester Powder Coat Finish
- High Impact White Acrylic Diffuser (50% DR Acrylic)
- Steel Reflector w/ Hi-Reflectance White Powder Coat Finish
- · Recessed Steel Screws
- Thermal Compensation Technology Ensures Longer LED Lifetime, Which is Ideal For Fixtures Being Placed in Area With Fluctuating or Higher Ambient Temperatures
- Fixture Mounts Directly to Surface w/ Two Wall Anchors (Not Included)
- ELV Driver Over-Voltage, Over-Current, and Short-Circuit Protection w/ Auto Recovery
- Constant Current, Dimmable to 10% From 120V to 230V
- 120V 277V
- Surge Protector
- CSA Listed Wet Location
- ADA Compliant
- Motion Sensor

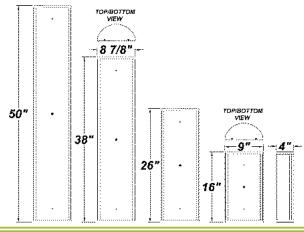

ORDERING INFORMATION

Example: (GRDW - L33.6 - 120 - 12VCC - WAL - TB - 51K)

Matte Silver is Standard Finish

			<u> </u>	<u> </u>		
PRODUCT	SOURCE/WATTAGE	VOLTAGE	DRIVER OPTIONS	DIFFUSER	FINISH	OPTIONS
Guardian W 16" (GRDW)	L33.6 - 33.6W LED Strip(s) L18.0 - 18W LED Strip(s)	120 - 277V (L18.0 is Dimmable From 120 - 230V)	12VCC - 12V Constant Current Non-Dimming Electronic Driver (For L33.6) TE500 - 500mA ELV Low Voltage Dimming Electronic Driver (For L18.0)	WAL - White Acrylic Lens	SM - Matte Silver TB - Textured Black AC - Antique Copper AS - Antique Silver BT - Bronze Mist CP - Copper KC - Kenworth	30K - 3000K Color Temp. 35K - 3500K Color Temp. (L18.0 Only) 40K - 4000K Color Temp. 51K - 5100K Color Temp. (L33.6 Only) OEL - Single End Window
Guardian W 2' (GRDW24)	L36.5 - 36.5W LED Strip(s) L46.5 - 46.5W LED Strip(s) L49.5 - 49.5W LED Strip(s) L70 life time for 50,000hr	(120 - 230V Dimmable)	ZE1050 - 1050mA Line Voltage Dimming Incandescent Driver (For L36.5) (Dimmable 0 - 10V) ZE1100 - 1100mA Line Voltage Dimming Incandescent Driver (For L46.5) (Dimmable 0 - 10V) ZE1150 - 1150mA Line Voltage Dimming Incandescent Driver (For L49.5) (Dimmable 0 - 10V)		Chrome SN - Sand SW - Swedish Steel BZ - Textured Bronze TW - Textured White RAL Colors or Custom Match - Consult Factory	TEL - Twin End Windows (Both Ends)



REPLACEMENT PARTS PART NO.

16" Acrylic LED Lens Assembly 38200
2' Acrylic LED Lens Assembly 38216



NOTES

We reserve the right to revise the design or components of any product due to parts availability or change in UL standards, without assuming any obligation or liability to modify any products previously manufactured, and without notice.



ARCHITECTURAL OUTDOOR

GUARDIAN W LED



PROJECT:


TYPE:

ORDERING #:

COMMENTS:

FEATURES

- Extruded Aluminum Housing w/ Matte Silver Polyester Powder Coat Finish
- · Aluminum Fascia w/ Matte Silver Polyester Powder Coat Finish
- Die Cast Aluminum End Caps w/ Matte Silver Polyester Powder Coat Finish
- High Impact White Acrylic Diffuser (50% DR Acrylic)
- Steel Reflector w/ Hi-Reflectance White Powder Coat Finish
- Recessed Steel Screws
- Thermal Compensation Technology Ensures Longer LED Lifetime, Which is Ideal For Fixtures Being Placed in Area With Fluctuating or Higher Ambient Temperatures
- Fixture Mounts Directly to Surface w/ Two Wall Anchors (Not Included)
- ELV Driver Over-Voltage, Over-Current, and Short-Circuit Protection w/ Auto Recovery
- Constant Current, Dimmable to 10% From 120V to 230V
- 120V 277V
- Surge Protector
- CSA Listed Wet Location
- ADA Compliant
- Motion Sensor

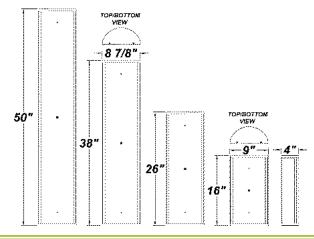

ORDERING INFORMATION

Example: (GRDW - L72.0 - 120 - 277V - ZE714 - WAL - SW - 40K)

Matte Silver is Standard Finish

		<u> </u>	<u> </u>	<u> </u>	<u> </u>	<u> </u>
PRODUCT	SOURCE/WATTAGE	VOLTAGE	DRIVER OPTIONS	DIFFUSER	FINISH	OPTIONS
Guardian W 3' (GRDW36)	L72.0 - 72.0W LED Strip(s)	120 - 277V (120 - 230V Dimmable)	ZE714 - 700mA & 1400mA ELV Low Voltage Dimming Incandescent Drivers (For L72.0) (Dimmable 0 - 10V)	WAL - White Acrylic Lens	SM - Matte Silver TB - Textured Black AC - Antique Copper AS - Antique Silver BT - Bronze Mist	30K - 3000K Color Temp. 35K - 3500K Color Temp. 40K - 4000K Color Temp. OEL - Single End Window TEL - Twin End Windows
Guardian W 4' (GRDW48)	L70.0 - 70.0W LED Strip(s) L75.0 - 75.0W LED Strip(s) L70 life time for 50,000hr		ZE1050 - 1050mA Line Voltage Dimming Incandescent Driver (For L70.0) (Dimmable 0 - 10V) ZE1100 - 1100mA Line Voltage Dimming Incandescent Driver (For L75.0) (Dimmable 0 - 10V)		CP - Copper KC - Kenworth Chrome SN - Sand SW - Swedish Steel BZ - Textured Bronze TW - Textured White	(Both Ends)
					RAL Colors or Custom Match - Consult Factory	



BUY AMERICA ACT HOSSIGN

REPLACEMENT PARTS PART NO.

3' Acrylic LED Lens Assembly 38217 4' Acrylic LED Lens Assembly 38218



NOTES

We reserve the right to revise the design or components of any product due to parts availability or change in UL standards, without assuming any obligation or liability to modify any products previously manufactured, and without notice.



Project:	
Type:	
Ordering # :	
COMMENTS:	

PRODUCT	SOURCE/WATTAGE	30K SPECIFICATIONS	40K SPECIFICATIONS	51K SPECIFICATIONS
Guardian W 16"	L33.6 - 33.6W LED Strip(s)	Eight 4.2W LED Strips 30K - 3000K Color Temp. 3 Nichia NS3x183 Series LEDs Per Strip - SW30Bin, Color Temp = 3000K Nominal	Eight 4.2W LED Strips 40K - 4000K Color Temp. 3 Nichia NS3x183 Series LEDs Per Strip - SW30Bin, Color Temp = 4000K Nominal	Eight 4.2W LED Strips 51K - 5100K Color Temp. 3 Nichia NS3x183 Series LEDs Per Strip - SW51Bin, Color Temp = 5100K Nominal
		- Constant Voltage at 12 Volts by Driver - 80 CRI typ. (75 CRI min) 2000 Lumens - 39W Input = Estimated 51.3 Lumens Per Watt	- Constant Voltage at 12 Volts by Driver - 80 CRI typ. (75 CRI min) 2054 Lumens - 39W Input = Estimated 52.7 Lumens Per Watt	- Constant Voltage at 12 Volts by Driver - 80 CRI typ. (75 CRI min) 2160 Lumens - 39W Input = Estimated 55.4 Lumens Per Watt

	PRODUCT	SOURCE/WATTAGE	30K SPECIFICATIONS	35K SPECIFICATIONS	40K SPECIFICATIONS
- Estimated 132 Lumens Per Watt - Estimated 134.8 Lumens Per Watt - Estimated 139 Lumens Per Watt	Guardian W 16"	L18.0 - 18.0W LED Strip(s)	30K - 3000K Color Temp. - 34 fV, Color Temp = 3000K Nominal - Constant Current 500 Milliamps Driver - 16.8W Input = 2218 LED Lumens	35K - 3500K Color Temp. - 34 fV, Color Temp = 3500K Nominal - Constant Current 500 Milliamps Driver - 16.8W Input = 2265 LED Lumens	40K - 4000K Color Temp. - 34 fV, Color Temp = 4000K Nominal - Constant Current 500 Milliamps Driver - 16.8W Input = 2335 LED Lumens

556546				(0) (0) = 0 = 0 = 0
PRODUCT	SOURCE/WATTAGE	30K SPECIFICATIONS	35K SPECIFICATIONS	40K SPECIFICATIONS
Guardian W 2'	L36.5 - 36.5W LED Strip(s)	L36.5	L36.5	L36.5
		30K - 3000K Color Temp.	35K - 3500K Color Temp.	40K - 4000K Color Temp.
		- 34 fV, Color Temp = 3000K Nominal - Constant Current 1050 Milliamps Driver - 36.9W Input = 4898 LED Lumens - Estimated 132.7 Lumens Per Watt	- 34 fV, Color Temp = 3500K Nominal - Constant Current 1050 Milliamps Driver - 36.9W Input = 4987 LED Lumens - Estimated 135.1 Lumens Per Watt	- 34 fV, Color Temp = 4000K Nominal - Constant Current 1050 Milliamps Driver - 36.9W Input = 5165 LED Lumens - Estimated 140 Lumens Per Watt
	L46.5 - 46.5W LED Strip(s)	L46.5	L46.5	L46.5
		30K - 3000K Color Temp.	35K - 3500K Color Temp.	40K - 4000K Color Temp.
		- 34 fV, Color Temp = 3000K Nominal - Constant Current 1050 Milliamps Driver - 38.8W Input = 5064 LED Lumens - Estimated 130.5 Lumens Per Watt	- 34 fV, Color Temp = 3500K Nominal - Constant Current 1050 Milliamps Driver - 38.8W Input = 5155 LED Lumens - Estimated 132.9 Lumens Per Watt	- 34 fV, Color Temp = 4000K Nominal - Constant Current 1050 Milliamps Driver - 38.8W Input = 55340 LED Lumens - Estimated 137.6 Lumens Per Watt
	L46.5 - 49.5W LED Strip(s)	L49.5	L49.5	L49.5
	2.0.0 .0.0.1 222 oa.p(c)	30K - 3000K Color Temp.	35K - 3500K Color Temp.	40K - 4000K Color Temp.
		- 34 fV, Color Temp = 3000K Nominal - Constant Current 1050 Milliamps Driver - 40.7W Input = 5156 LED Lumens - Estimated 126.7 Lumens Per Watt	- 34 fV, Color Temp = 3500K Nominal - Constant Current 1050 Milliamps Driver - 40.7W Input = 5250 LED Lumens - Estimated 129 Lumens Per Watt	- 34 fV, Color Temp = 4000K Nominal - Constant Current 1050 Milliamps Driver - 40.7W Input = 5437 LED Lumens - Estimated 133.6 Lumens Per Watt







PROJECT:
TYPE:
Ordering # :
COMMENTS:

PRODUCT	SOURCE/WATTAGE	30K SPECIFICATIONS	35K SPECIFICATIONS	40K SPECIFICATIONS
Guardian W 3'	L72.0 - 72.0W LED Strip(s)	L72.0 30K - 3000K Color Temp. - 34 fV, Color Temp = 3000K Nominal - Constant Current 1400 Milliamps Driver & 700 Milliamps Driver - 69.2W Input = 9169 LED Lumens - Estimated 132.5 Lumens Per Watt	L72.0 35K - 3500K Color Temp. - 34 fV, Color Temp = 3500K Nominal - Constant Current 1400 Milliamps Driver & 700 Milliamps Driver - 69.2W Input = 9362 LED Lumens - Estimated 135.3 Lumens Per Watt	L72.0 40K - 4000K Color Temp. - 34 fV, Color Temp = 4000K Nominal - Constant Current 1400 Milliamps Driver & 700 Milliamps Driver - 69.2W Input = 9652 LED Lumens - Estimated 139.5 Lumens Per Watt

PRODUCT	SOURCE/WATTAGE	30K SPECIFICATIONS	35K SPECIFICATIONS	40K SPECIFICATIONS
Guardian W 4'	L70.0 - 70.0W LED Strip(s)	L70.0 30K - 3000K Color Temp.	L70.0 35K - 3500K Color Temp.	L70.0 40K - 4000K Color Temp.
		- 34 fV, Color Temp = 3000K Nominal - Constant Current 1050 Milliamps Driver - 71.8W Input = 9814 LED Lumens - Estimated 136.7 Lumens Per Watt	- 34 fV, Color Temp = 3500K Nominal - Constant Current 1050 Milliamps Driver - 71.8W Input = 10021 LED Lumens - Estimated 139.6 Lumens Per Watt	- 34 fV, Color Temp = 4000K Nominal - Constant Current 1050 Milliamps Driver - 71.8W Input = 10331 LED Lumens - Estimated 143.9 Lumens Per Watt
	L75.0 - 75.0W LED Strip(s)	L75.0 30K - 3000K Color Temp.	L75.0 35K - 3500K Color Temp.	L75.0 40K - 4000K Color Temp.
		- 34 fV, Color Temp = 3000K Nominal - Constant Current 1100 Milliamps Driver - 75W Input = 10146 LED Lumens - Estimated 135.3 Lumens Per Watt	- 34 fV, Color Temp = 3500K Nominal - Constant Current 1100 Milliamps Driver - 75W Input = 10360 LED Lumens - Estimated 138.1 Lumens Per Watt	- 34 fV, Color Temp = 4000K Nominal - Constant Current 1100 Milliamps Driver - 75W Input = 10680 LED Lumens - Estimated 142.4 Lumens Per Watt







ARCHITECTURAL OUTDOOR


BRONZE CUP MD LED




PROJECT:		
TYPE:		
ORDERING #:		
COMMENTS:		

FEATURES

- · Cast Aluminum Housing w/ Textured Bronze Polyester Powder Coat Finish
- Clear Prismatic Borosilicate Glass Lens
- Permlight BB66WA 35W LED Module
- Antron AC-50CDI.4UV-TS 50W LED Driver
- Surge Protector
- · Fully Gasketed
- · Stainless Steel Zinc-Coated Screws
- Mounts Direct to Flat Surface w/ Four #8 Wall Anchors (Not Included)
- · Cast-In Template
- · Ideal For Stairwell And Passageway Lighting
- CSA Listed For Wall Mounting
- L70 Life Time For 50,000hr

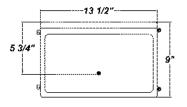

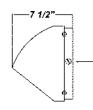

0.50" Conduit Entries One Each on Opposite Sides, One On Top. and One on Back of Housing

ORDERING INFORMATION

Example: (BPM - L35.0 - 100 - 277V - CGL - TB - 50K)

Textured Bronze is Standard Finish

BPM					
PRODUCT	SOURCE/WATTAGE	VOLTAGE	DIFFUSER	FINISH	OPTIONS
Bronze Cup Md	L35.0 - 35W LED Module	100 - 277V	CGL - Clear Glass Lens (Standard)	SM - Matte Silver TB - Textured Black AC - Antique Copper AS - Antique Silver BT - Bronze Mist CP - Copper SN - Sand SW - Swedish Steel BZ - Textured Bronze TW - Textured White RAL Colors or Custom Match - Consult Factory	40K - 4000K Color Temperature 50K - 5000K Color Temperature PCL120 - Photocell 120V PCL277 - Photocell 277V DIM - Dimmable Driver (0 - 10V) SDIM - Step-Dimmable Driver (Dimmable to 25% & 50%) PDIM - Pulse Width Dimmable Driver (0 - 10V) F - Fused EB - Bodine BSL23 - Will light Two 5.5W LED Strips - Average 340 total Lumens Please Note: 120V or 277V Must Be Specified When Ordering The EB Option Driver Specifications - 66 LEDs Per Strip - SW50Bin, Color Temp = 5000K Nominal - Constant Current at 1050mA by Driver - 80 CRI typ. (75 CRI min) 4200 Lumens - 41W Input = Estimated 102 Lumens Per Watt



REPLACEMENT PARTS PART NO

Clear Tempered Glass Diffuser 37033 Dark Sky Visor (Please Specify Color When Ordering) 5301999 (Must Order Separately)

NOTES

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PROJECT:
TYPE:
Ordering # :
Comments:

PRODUCT SOURCE	CE/WATTAGE 40K	SPECIFICATIONS 50K	SPECIFICATIONS
Bronze Cup MD LED L35.0 - (1)	- 66 LEDs Per S - SW50Bin, Colo - Constant Curre - 80 CRI typ. (75	trip - 66 LEDs Per 3 or Temp = 4000K Nominal - SW50Bin, Co ent at 1050mA by Driver - Constant Curr of CRI min) 3990 Lumens - 80 CRI typ. (7	ED Specifications Strip for Temp = 5000K Nominal rent at 1050mA by Driver Country Cou






CALCUTTA CA LED



PROJECT:
TYPE:
Ordering # :
COMMENTS:

FEATURES

- Die-Cast Aluminum Housing w/ Textured Bronze Polyester Powder Coat Finish
- Clear Prismatic Ribbed Borosilicate Glass lens
- Thermal Compensation Technology Ensures Longer LED Lifetime, Which is Ideal For Fixtures Being Placed in Area With Fluctuating or Higher Ambient Temperatures
- 120V 277V
- Dimmable Driver
- Surge Protector
- Mounts Directly to 4" Junction Box (By Others)
- CSA Listed Wet Location For Wall Mount

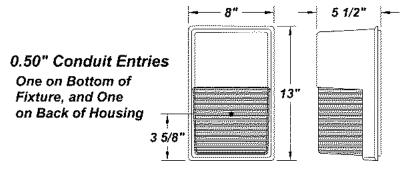

	ORDERING INFORMATION				
Example : (CAC - L19.0 - 120V - 277V -TB - 50K)			Textured Bronze is Standard Finish		
CAC			1		
PRODUCT	SOURCE/WATTAGE	VOLTAGE	DIFFUSER	FINISH	OPTIONS / SPECS
Calcutta CA LED	L19.0- (1) LumaFit LED Module 19.0 LED Module - (LM80 Standard) 50,000 Hours(L70)	120V - 277V 50 / 60Hz Please See "Options / Specs" Column For Voltage Specifications	Not Applicable	BZ - Textured Bronze	50K - 5000K Color Temp. 2610 Array Lumens 1543 Delivered Lumens 23.9W Input = 64.6 Lumens Per Watt SF - Single Fused DF - Double Fused


REPLACEMENT PARTS	PART NO.
Replacement Clear Glass Diffuser	37027

NOTES


We reserve the right to revise the design or components of any product due to parts availability or change in UL standards, without assuming any obligation or liability to modify any products previously manufactured, and without notice.




PD Application Item 26 SHADOW STUDY

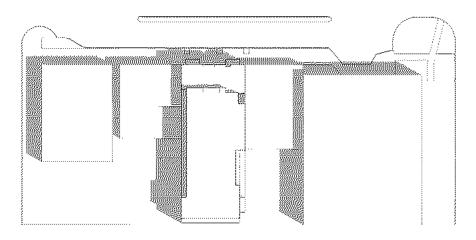

JUNE 22 10AM

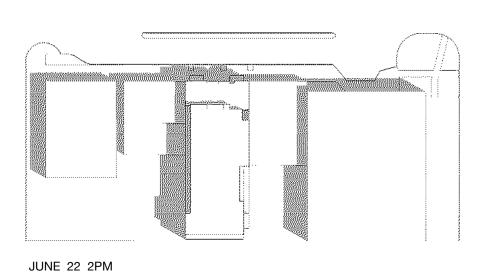

DECEMBER 22 10AM

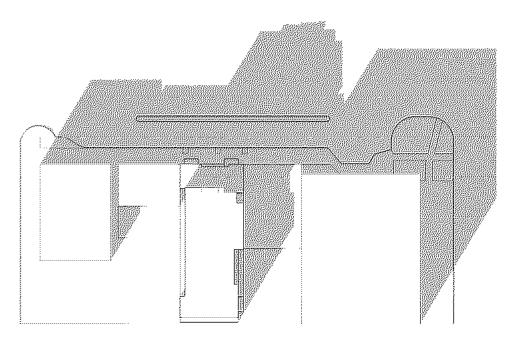

DECEMBER 22 2PM

john conrad schiess architect

400 Ashland Avenue River Forest Illinois 60305 tel. 708.366.1500

john@jcsarchitect.com

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PROPERTY OWNER:

717 South Boulvard, LLC 3528 Walnut Avenue Wilmette, Illinois 60091 phone: 847-401-2642

Submitt for PD | 09.13.16 Revised for Technical 05.31.16 Review Issue for Technical 11.13.15 Review

Issue for Village Review


10.21.15


The RESIDENCES at SOUTH BOULEVARD


715-717 S. Boulevard Oak Park, Illinois

Sheet Title SHADOW STUDY

PD Application Item 27 PRELIMINARY ENGINEERING PLAN

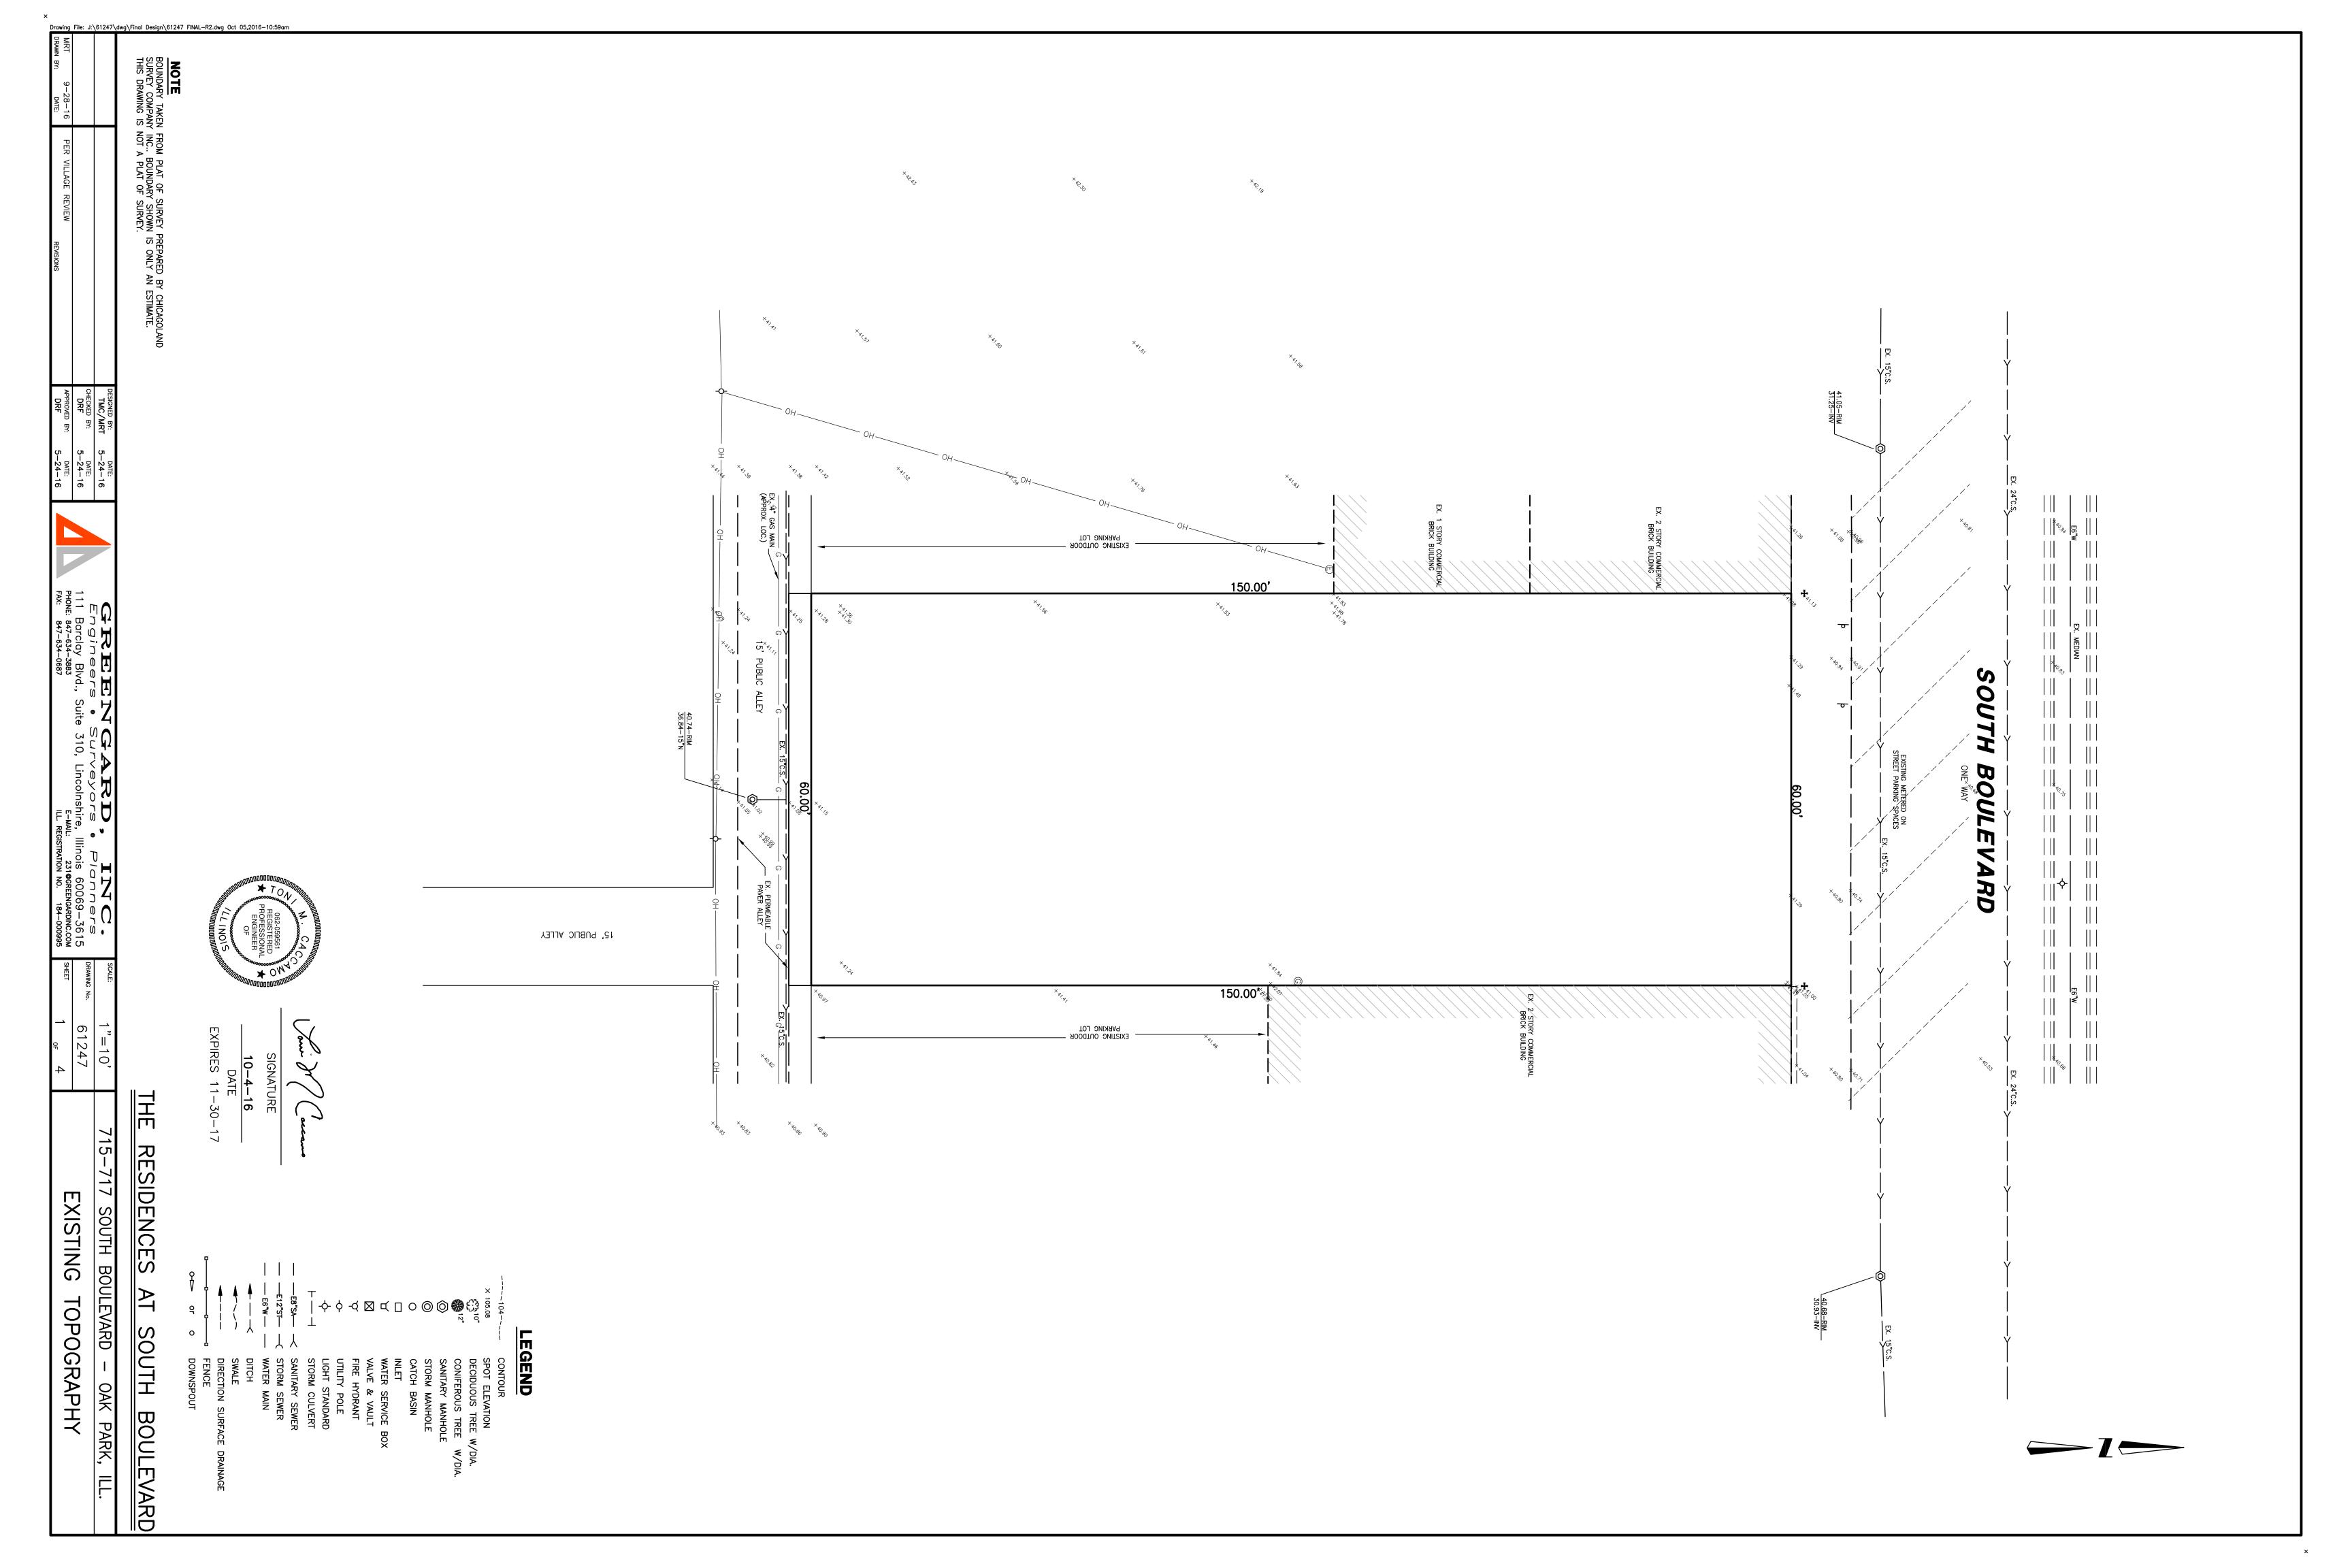

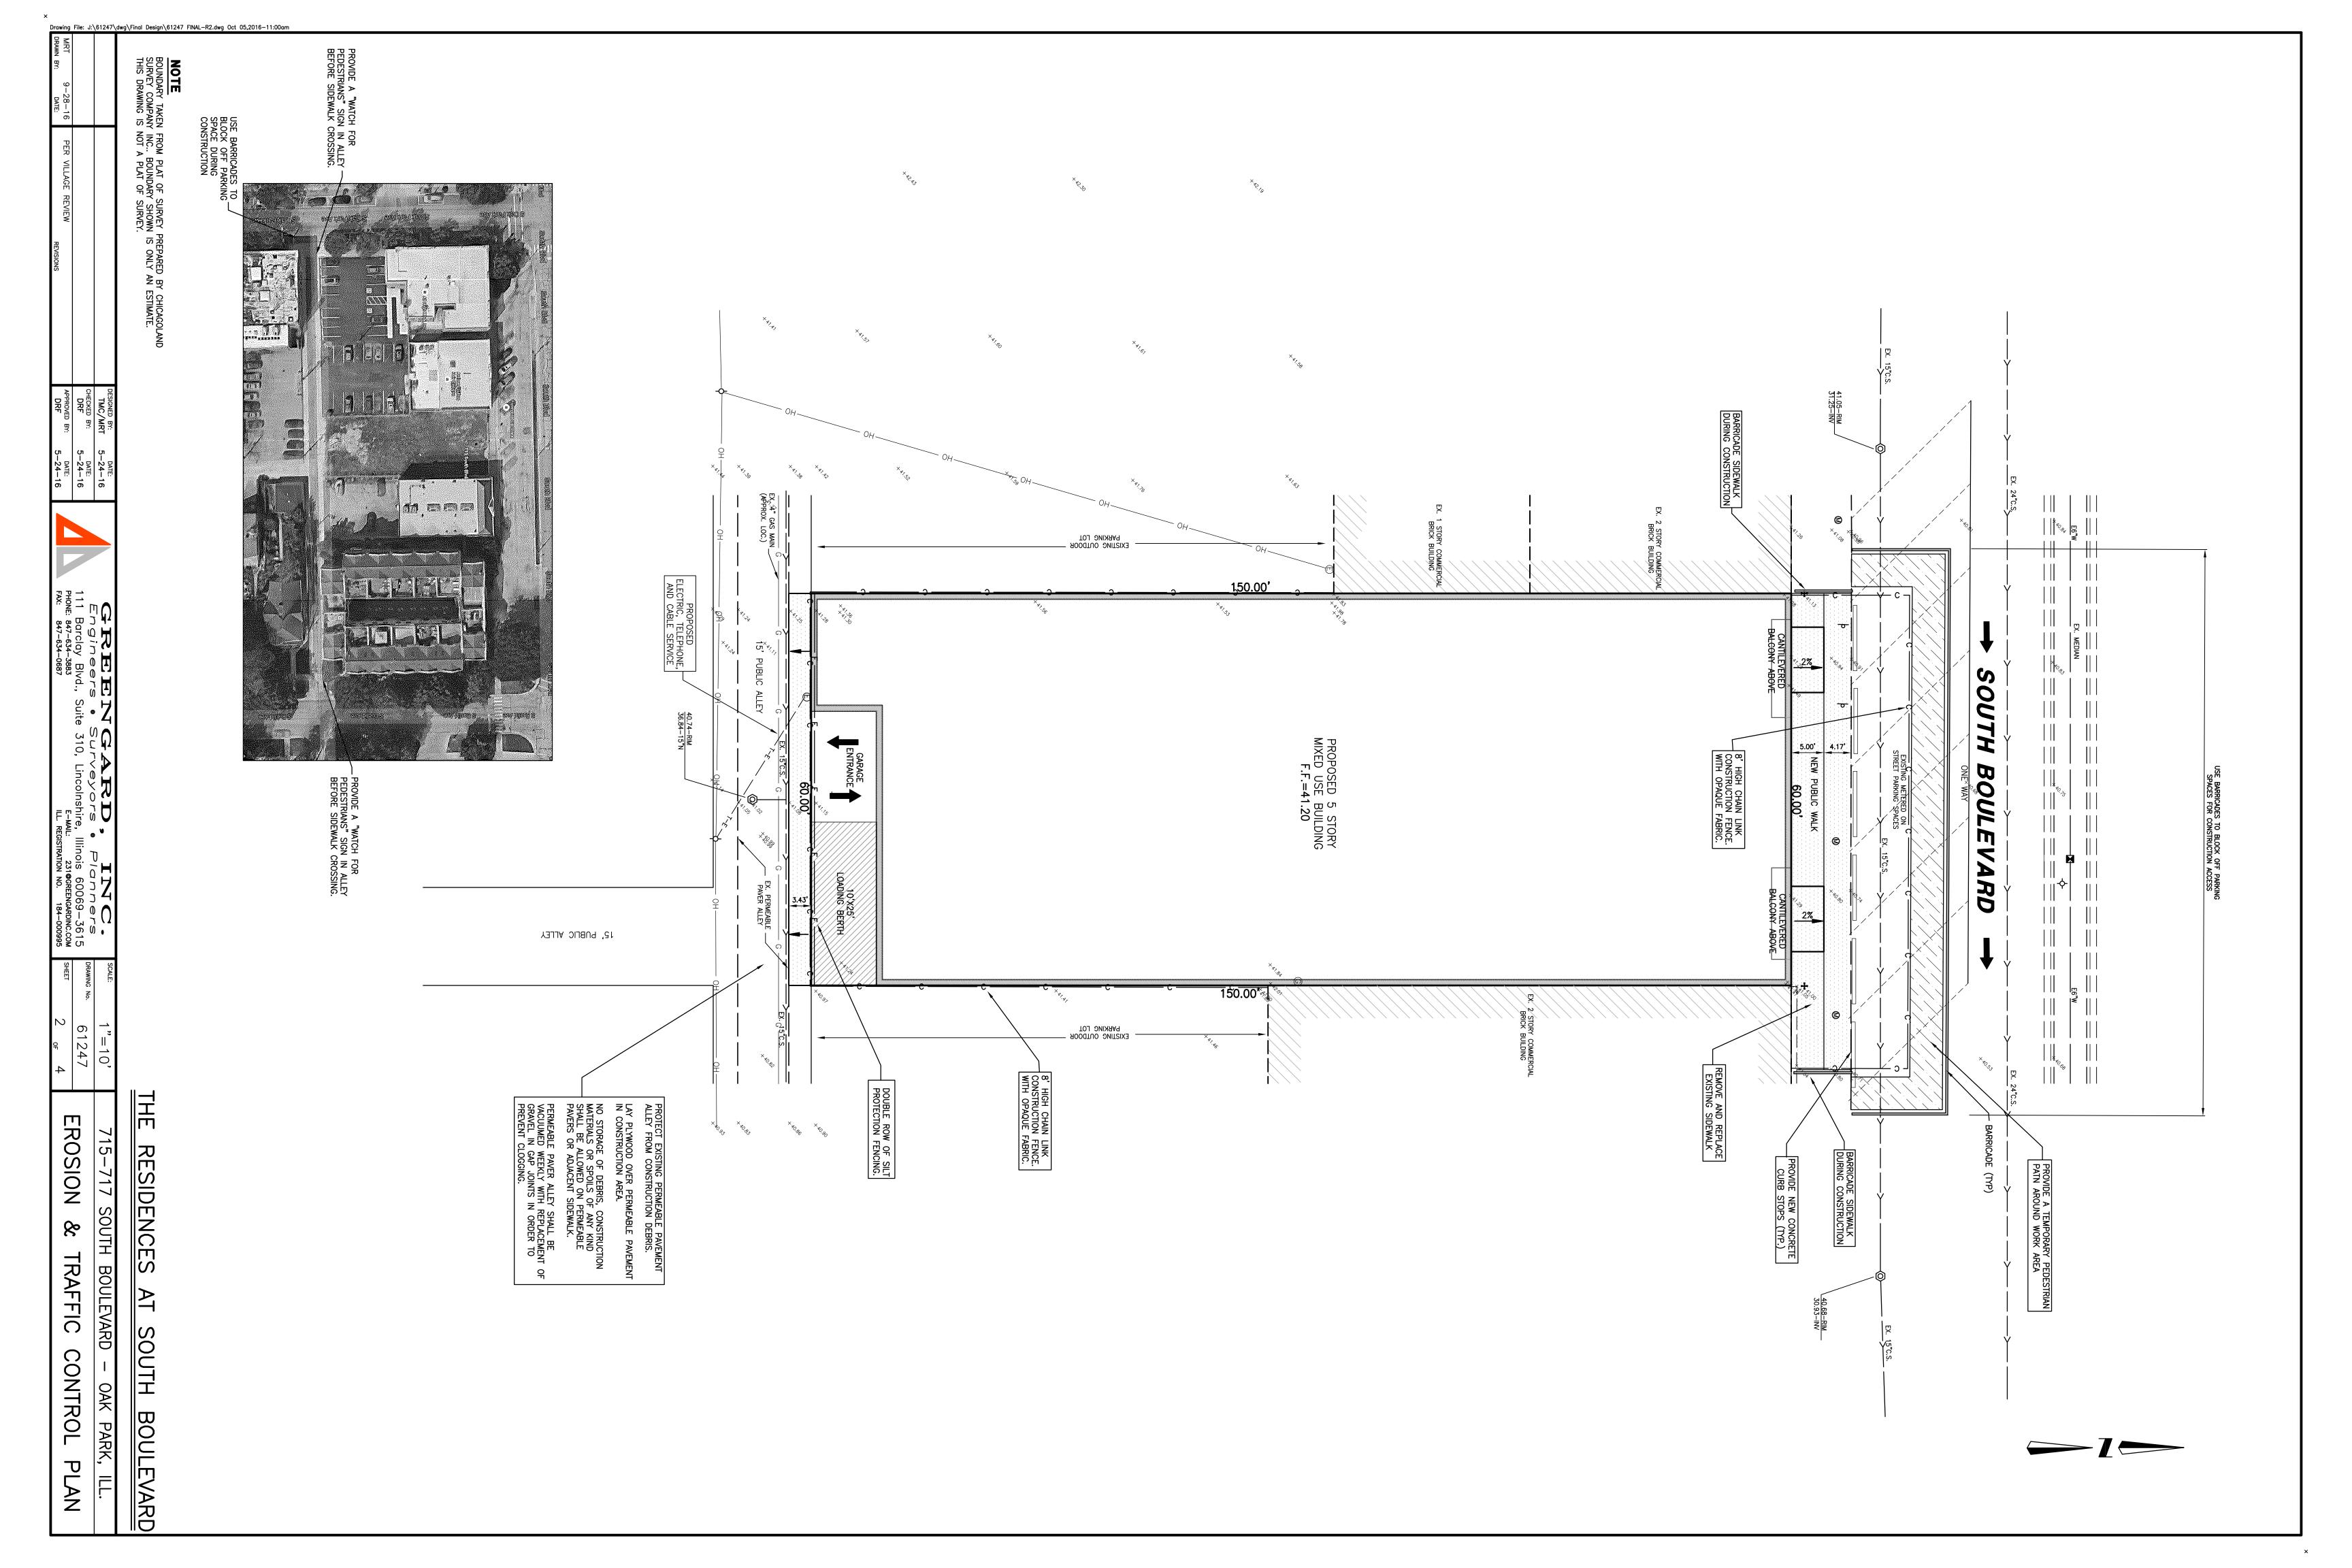


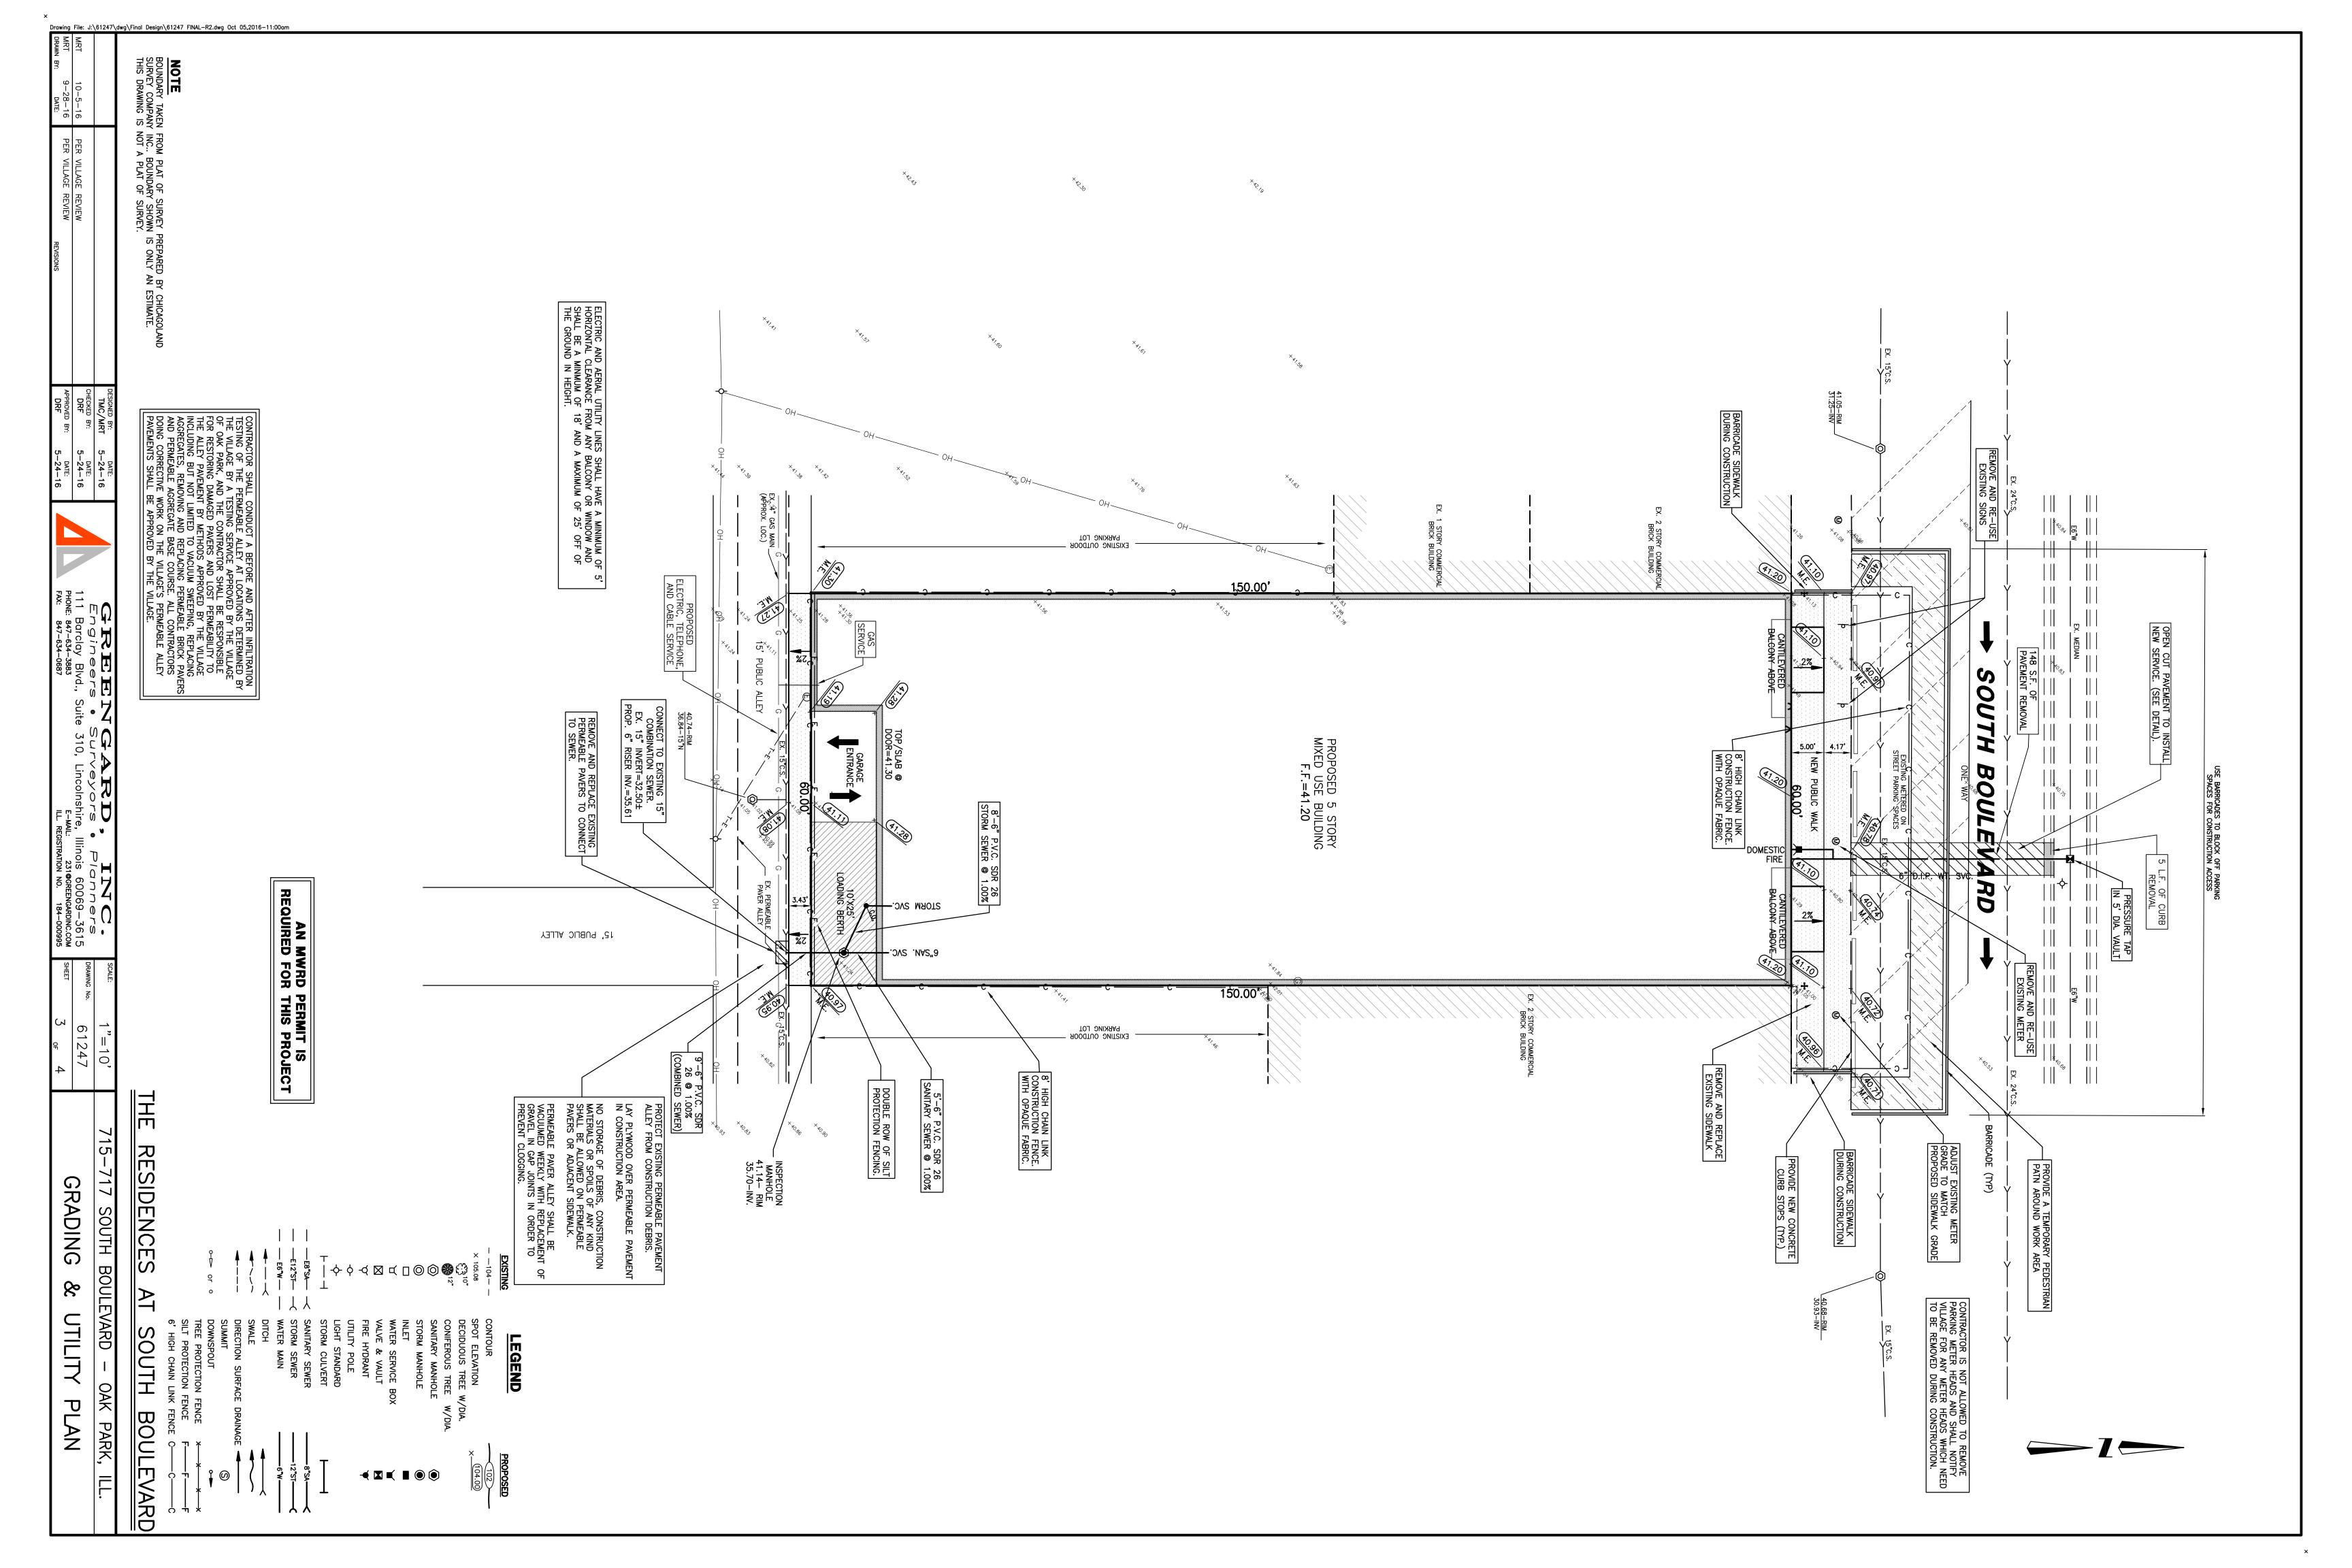






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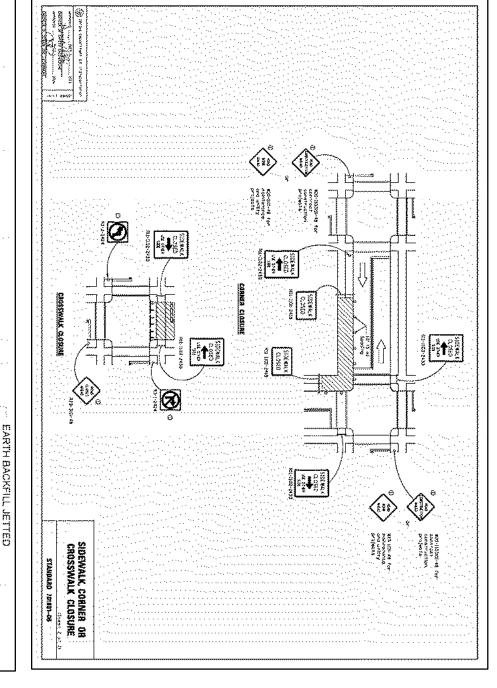
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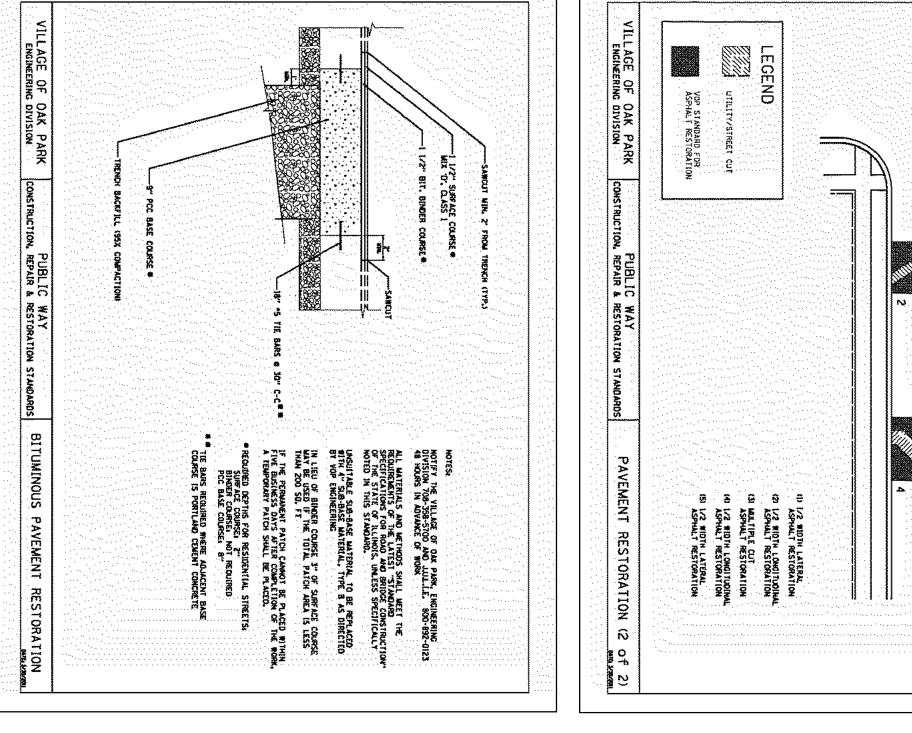





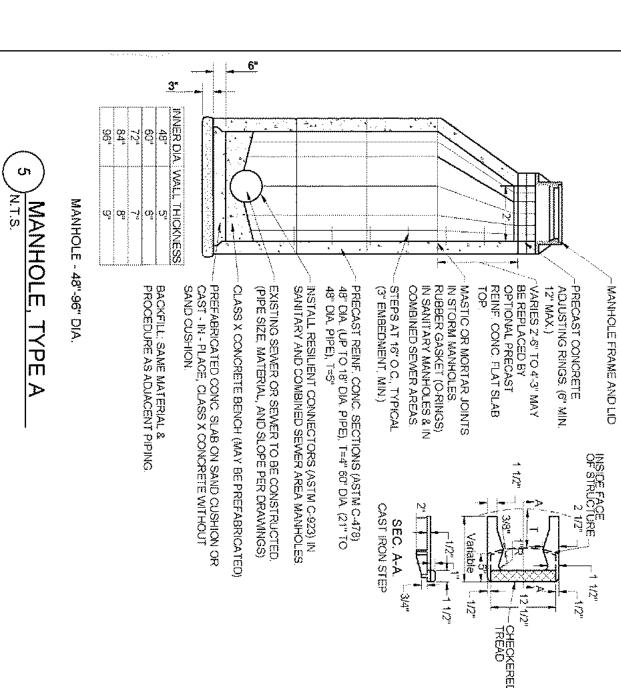


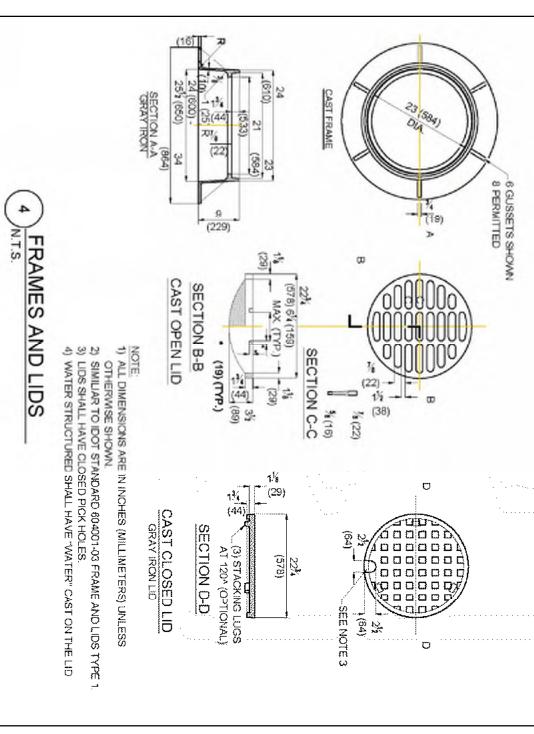
VILLAGE OF OAK PARK ENGINEERING DIVISION

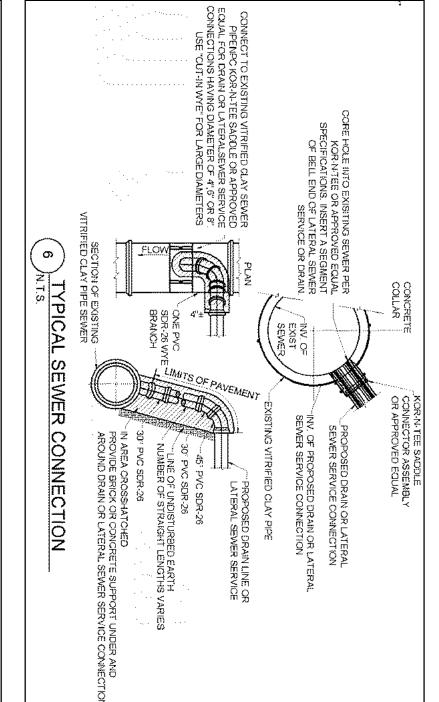
PUBLIC WAY CONSTRUCTION, REPAIR & RESTORATION STANDARDS

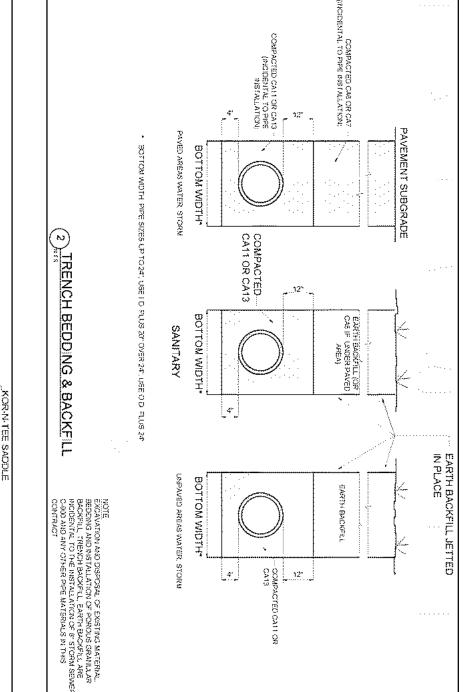

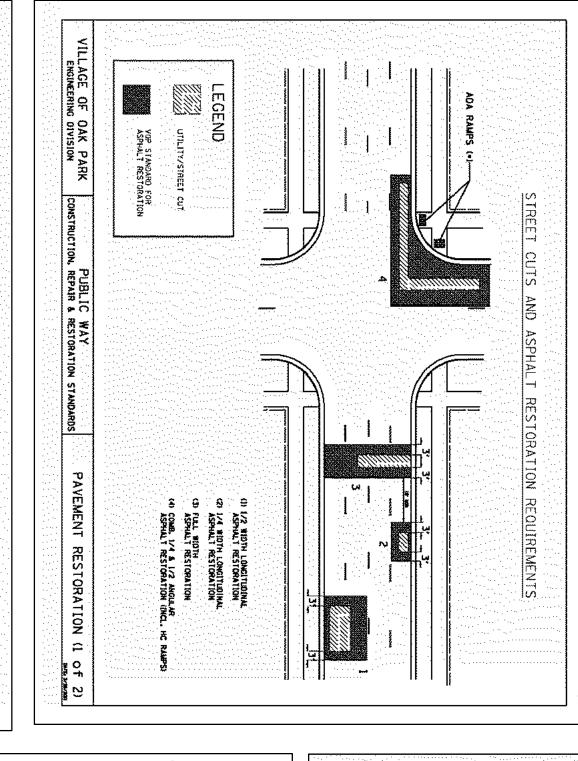


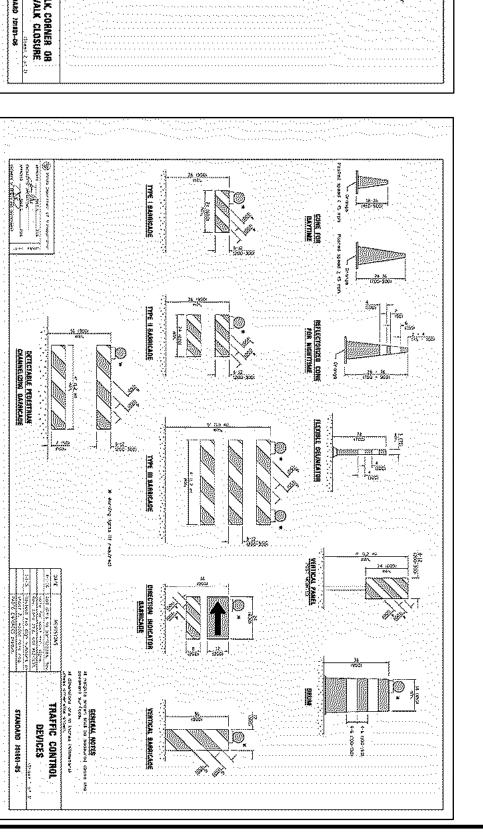

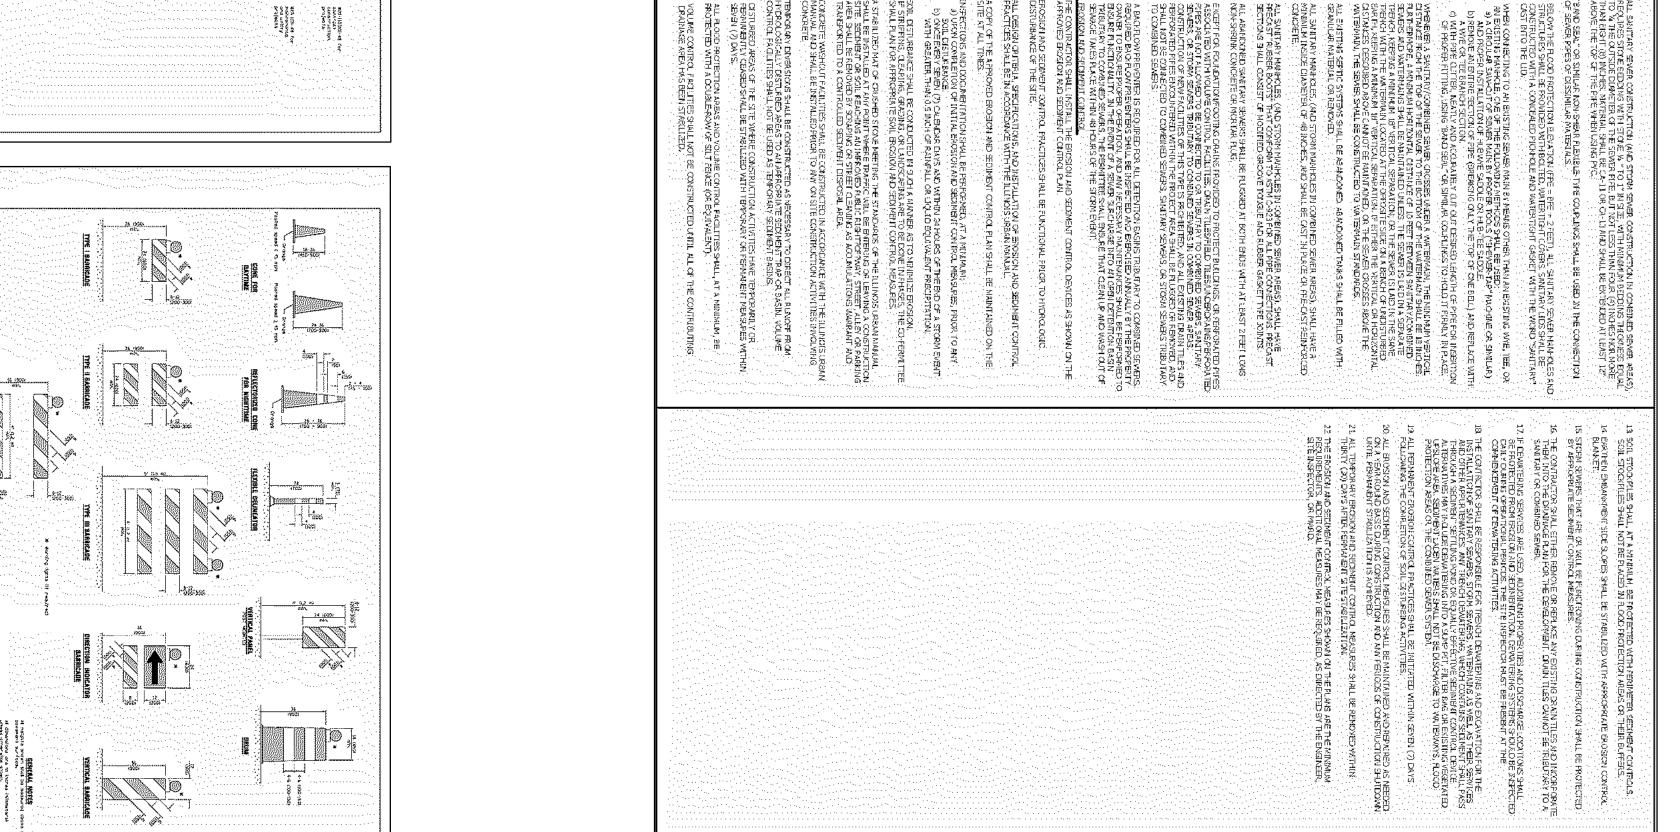

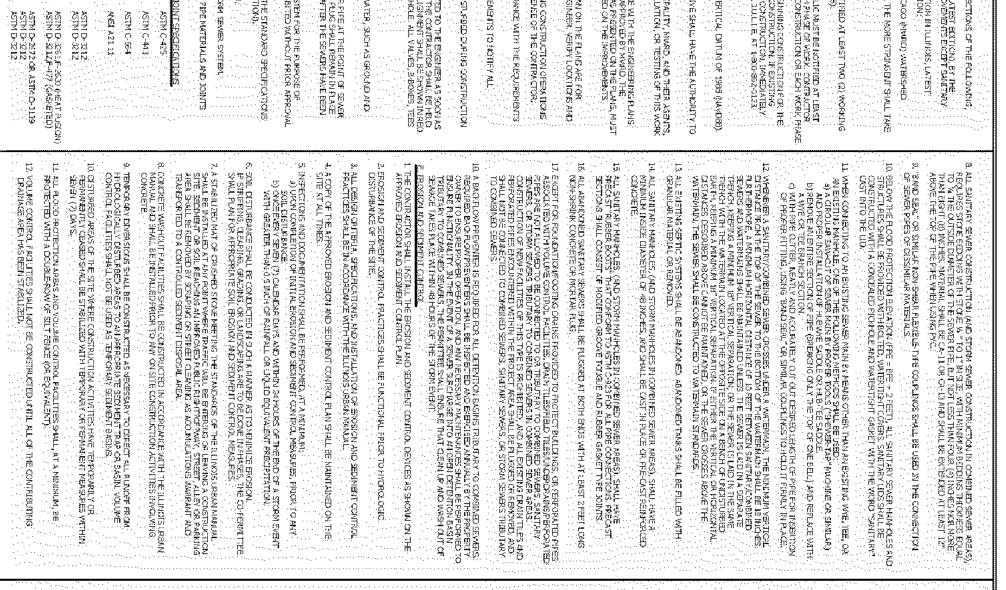



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4 INCHTO 32-INCH 4 INCHTO 32-INCH	WATER WAIN DUALITY PVC.	POLYVINYL CHLORIDE (PVC) PIPE 6 INCH TO 35-INCH DIAMETER, SER, 26 IB-INCH TO 27-INCH DIAMETER, F/DY=46	DUCTILE IREMPIFE	CAST TRON SOIL PIPE CAST TRON SOIL PIPE		7. ALL SANITARY SEWER RIPE MATERIALS AND JOINTS (AND STORM SEWER FIRE MATERIALS AND JOINTS IN A CONSENSE) SEVER AREA) SHALL CONFORM TO THE FOLLOWING:	6. ALL DOWNSPOUTS AND FOOTING DRAINS SHALL DISCHARGE TO THE STORM SEWER SYSTEM.	4. ALL SANITARY SEWER CONSTRUCTION SHALL BE IN ACCORDANCE WITH THE STANDARD SPECIFICATIONS FOR WATER, AND SEWER MAIN CONSTRUCTION IN ILLINOIS (LATEST EDUTION);	IL CESCHARGING ANY ENROCHETED WATER ENTO THE SANITARY SEWER SYSTEM FOR THE PURPOSE OF SEWER HUSHING OF LINES FOR THE DEFLECTION TEST SHALL BE PROHIBITED WITHOUT FRIOR APPROVALERCY THE MUSICIPALITY OR WINNED.	2. A WATER-TIGHT PLUG SHALL 2E INSTALLED IN THE DOWNSTREAM SEMER PIPE AT THE POINT OF SEMEN CONNECTION PRIOR TO COMMERCING ANY SEMEN CONSTRUCTION. THE PLUG SHALL REMAIN IN PLACE UNTIL REMOVAL 15 AUTHORIZED BY THE MUNICIPALITY AND/OR MAKED AFTER THE SEMENS HAVE BEEN TESTED AND ACCEPTED.	D. SWITTARY SEMER. 1. THE CONTRACTOR SHALL TAKE MEASURES TO PREVENT ALM POLITUTED WATER, SUCH AS GROUND AND SUFFACE MATTER, FROM ENTERING THE EXISTING SMULTARY SEMERS.	IO RECORD CRAMMOS SHALL BE REPT BY THE CONTRACTOR AND SLAWITTED TO THE ENGINERR AS SOCK AS SUNCESSROUNC IMPROVEMENTS ARE CONFLETED FINAL PAYMENTS TO THE CONTRACTOR SHALL BE HOLD LINITL. THEY ARE SUCCEIVED, ANY CHANGES IN LENGTH, LOCATION OR ALLISMYSTY SHALL BE SHOWN HINKING ALL WES OR BENDS SHALL BE LOCATED FROM THE DOMASTREAM MAYARDLE, ALL VALVES, P.BOXES, TEBS OR, BENDS SHALL BE LOCATED FROM THE DOMASTREAM MAYARDLE. ALL VALVES, P.BOXES, TEBS OR, BENDS SHALL BE TIED TO A FIRE HYDRAMT.	9, ALL NEW AND EXISTENS UTILITY STRUCTURES ON SITE AND IN AREAS DISTURBED CURING CONSTRUCTION.	B. THE UNDERGROUND COMPLACTOR SHALL MAKE ALL MEDESSIRY APPAINGEMENTS TO NOTIFY ALL MEDESSIRY APPAINGEMENTS TO NOTIFY ALL	2. MATERIAL, AND COMPACTION HESTING SHALL BE PERFORMED IN ACCORDANCE WITH THE REQUIREMENTS OF THE MURICIPALITY, MOVED, AND OWNER.	6. ANY EXISTING PAVENENT, SIDEWALK, DRIVENAY, JEC., DAMAGED DURING CONSTRUCTION CREAR FICHE AND NOT CALLED FOR TO BE REMOVED 3-MILL BE REPLACED AT THE EXPENSE OF THE CONTRACTOR.	5. THE LOCATION OF MARIOUS UNDERGROUND UTILITIES WHICH ARE SHOWN ON THE FLAND ARE FOR THE CONTRICT OF THE PLAND ARE FOR ELEVATIONS (FIREX. YEAR) THE CONSTRUCTION COERATIONS.	A THE PROPOSED IMPROVEMBRIS MUST BE CONSTRUCTED IN ACCORDANCE WITH THE ENGINEERING PLANS. AS REPROVED BY MAKED AND THE MUNICIPALITY CRUZES CHANGES ARE APPROVED BY MAKED. THE NAME, MUST MANULIFY, OR AUTHORIZED AGENT. THE CONSTRUCTION DETAILS, AS PRESENTED ON THE PLANS, MUST BE FOLLOWED ON THE IMPROVEMENTS. INDICATED ON THE PLANS.	3. THE CONTRACTOR(5) SHALL INDEMNIFY THE OWNER, BIGWEER, MUNICIPALITY, MWAD, AND THEIR ASSENS, ETC., FROM ALL LIMBLITY INVOLVED WITH THE CONSTRUCTION, INSTALLYTION, OR TESTING OF THIS WORK ON THE PROJECT.	2. NOWED, THE NUMBERALITY AND THE CONNER OF CONNERS REPRESENTATIVE SHALL HAVE THE AUTHORITY TO INSPECT, APPROVE, AND REJECT THE CONSTRUCTION INPROVEMENTS.	C. SEMERAL MOTES 1. BLUE, EMANTICAL SKYLOND CONSTRUCTION OF 1969 (MAYDOO) CONVERSION FACTOR IS	3. THE COMPRIACTOR SHALL WITH'S ALL, UTILITY COMPANIES PRIOR TO BEGINNING CONSTRUCTION FOR THE EXACT LOCATIONS OF UTILITIES AND FOR THEIR PROTECTION QURING CONSTRUCTION, IMMEDIATELY UTILITIES AND HOLD THAT CONFLICT INLOCATION WITH NEW CONSTRUCTION, IMMEDIATELY NOTIFY THE ENGINEER SO THAT THE CONFLICT ON BE RESOLVED, OUL DULL E AT 1-800-882-0123.	2 THE VILLAGE OF <u>OAK PARK</u> BUSIMEERING DEPARTMENT AND PUBLIC MUST BE NOTIFIED AT LEAST GHOURS PRIOR TO THE START OF CONSTRUCTION AND PRICR TO EACH PUNCE OF WORK, CONTRUCTION SHALL DETERMINE TENS REQUIRING INSPECTION PRICR TO START OF CONSTRUCTION OR EACH WORK, P	E. NOTHFICHTIONS 1. THE MAND LOCAL SEMER SYSTEMS SECTION DAYS PRIOR TO THE COMMERCENESS SECTION	* IN CASE OF CONFIGURE THE APPLY PRESCRIPTING AND SHALL CONTROL ALL CO	ILLINOIS DEFAIL REMI OF INFORMATIONS FOR ALL INFORMED ENDING ENDING SEVER AND WATER AND WATER AND WATER AND WATER AND WATER AND WATER FOR CONSTRUCTION IN ILLINOIS, LATEST & STANDARD SECTION (SOMS) FOR SANITARY SEMES AND WATER RIGHT CONSTRUCTION! **VILLAGE OF **VILLAGE OF **VILLAGE OF **THE METROPOLITAN WATER RELAMATION DISTRICT OF GREATER CHICAGO (NINDO) WATERSHED. **THE METROPOLITAN WATER RELAMATION DISTRICT OF GREATER CHICAGO (NINDO) WATERSHED.	A. REPERSONATION SHALL BE IM ACCORDAN EXCEPT AS MOCKHED HEREIN OR CTUTTED HEREIN OF THE PROPERTY OF THE PROPE	The second secon
#STM 0-2241 #WWW 0900	ASTM 0-3350 ASTM 0-3035	ASTM 0-3034 ASTM ₹-679	AVS1 821.51	ASTM C-75		DOINTS (AND STORM SEMER RM TO THE FOLLOWING:	E PARTINES SEMER PARTIESTO	DE IN ACCORDANCE VATH I	OTHE SAMITARY SEMER SYSTEM THOM TEST SHALL BE PROHI	N THE DOWNSTREAM SEMER EVIER CONSTRUCTION. THE RICHALITY AND/OR MYRO, A	DING SAVITARY SOLUTION	COMIRACTOR AND SLEWITT ETTED. FINAL, PAYMENTS TO N LENGTH, LOCATION ON AL OM THE DOWNSTREAM MAY NE.	IS ON SITE AND IN APEAS OF IN TO PINAL INSPECTION,	KE ALL NECESSARY APRANG	BE PERFORMED IN ACCORD	WAY, ETC., DAYAGED CURIN	CHARLE SHOW CORNELL SHOW	HASTRUCTED IA ACCCRIMNO L'TY UNILESS CHANGES ARE CONSTRUCTION DETAILS, A HAIQUES MUST BE POLLOW	OWNER, ENGINEER, MUNICI THE CONSTRUCTION, INSTAL	OP OWNERS REPRESENTATION IN PROPERTY.	CE THE NORTH AMERICAN Y	ALL COMPANIES PRIOR TO BEY THIS PROTECTION DURING A MEN PROTECTION DURING A MEN PROTECTION DURING A	UNG DEPARTMENT AND PUB JOTION AND PRICE TO EACH JION PRICE, TO START OF C	N WORK (OML, 768-883-108)	CABLE CROMANCES NOTED, STRUCTION.	AN (LID) SOLEN MAIN CONSTRUCTO VACER MAIN CONSTRUCTO DESTRUCT OF GREATER CHIC	CE WITH THE APPLICABLE SE	
ASTM D-2672 OR ASTM D-3139 #STM D-3212	ASIM D-3261,F-3530 (HEAT FUSION) ASIM D-3212,F-477 (GASHETED)	ASTM D-2012. ASTM D-3012	ANEI A21.11	ASIM C-443	ASIM C-425	PIPE MATERIALS AND JOINTS	XXM SEWEN SYSTEM.	THE STANDARD PECIFICATIONS TION).	STEM FOR THE PURPOSE OF BITED WITHOUT PRIOR APPROVAL	R PIPE AT THE POINT OF SEMER PLUG SHALL REMAIN IN FLACE PITER THE SEMERS HAVE BEEN	WITER, SUCH AS GROUND AND:	TED TO THE ENGINEER AS SOON AS THE CONTRACTOR SHALL RE HELD. JESHIENT SHALL BE SHOWN IN SED. HOLE. ALL VALVES, 3-BOXES, TEES	SULPHICHER CONSTRUCTION	EMBAIS TO NOTIFY ALL	DANCE WITH THE REQUIREMENTS	AS CONSTRUCTION OFERA HONS:	SINES VERDA LOCKLICAR VAD	E WITH THE ENGINEES INC. PLAYS PEPROVED BY MUND, THE SO PRESENTED ON THE PLAYS, MUST SO ON THE IMPROVEMENTS.	PALITY, NIVAD, AND THEIR AGENTS, LATION, OR TESTING OF THIS WORK	IVE SHALL HAVE THE AUTHORITY TO	ERTICAL DATIAN OF 1989 (MAYDES).	SHANIAG CONSTRUCTION FOR THE CONSTRUCTION, IN EXISTING CONSTRUCTION, INVESTALIELY CONSTRUCTION, INVESTALIZA CONSTRUCTION, INVESTALIZA CONSTRUCTION (INVESTALIZA)	LIC MUST BE NOTIFIED AT LEAST HENATE OF WORK, CONTRUCTOR CONSTRUCTION OR EACH WORK, PHASE	STEWER SYSTEMS SECTION FIELD OFFICE MUST BE NOTIFIED AT LEAST TWO (2) WORKING THE COMMENCEMENT OF ANY WORK (CML, XX8-588-4X85);	THE MORE STRIMGENT SHALL TAKE	COMPANY (CONTRACT) NOI SERVICE SERVICE SERVICE SERVICE SERVICE	COMONS OF THE FOLLOWING, ATEST EXTION), BY THE NUMBER OF THE FAMILIES.	
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SOUTH BOULEVARD

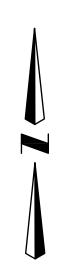



LIGHT TRUCK (LSU)

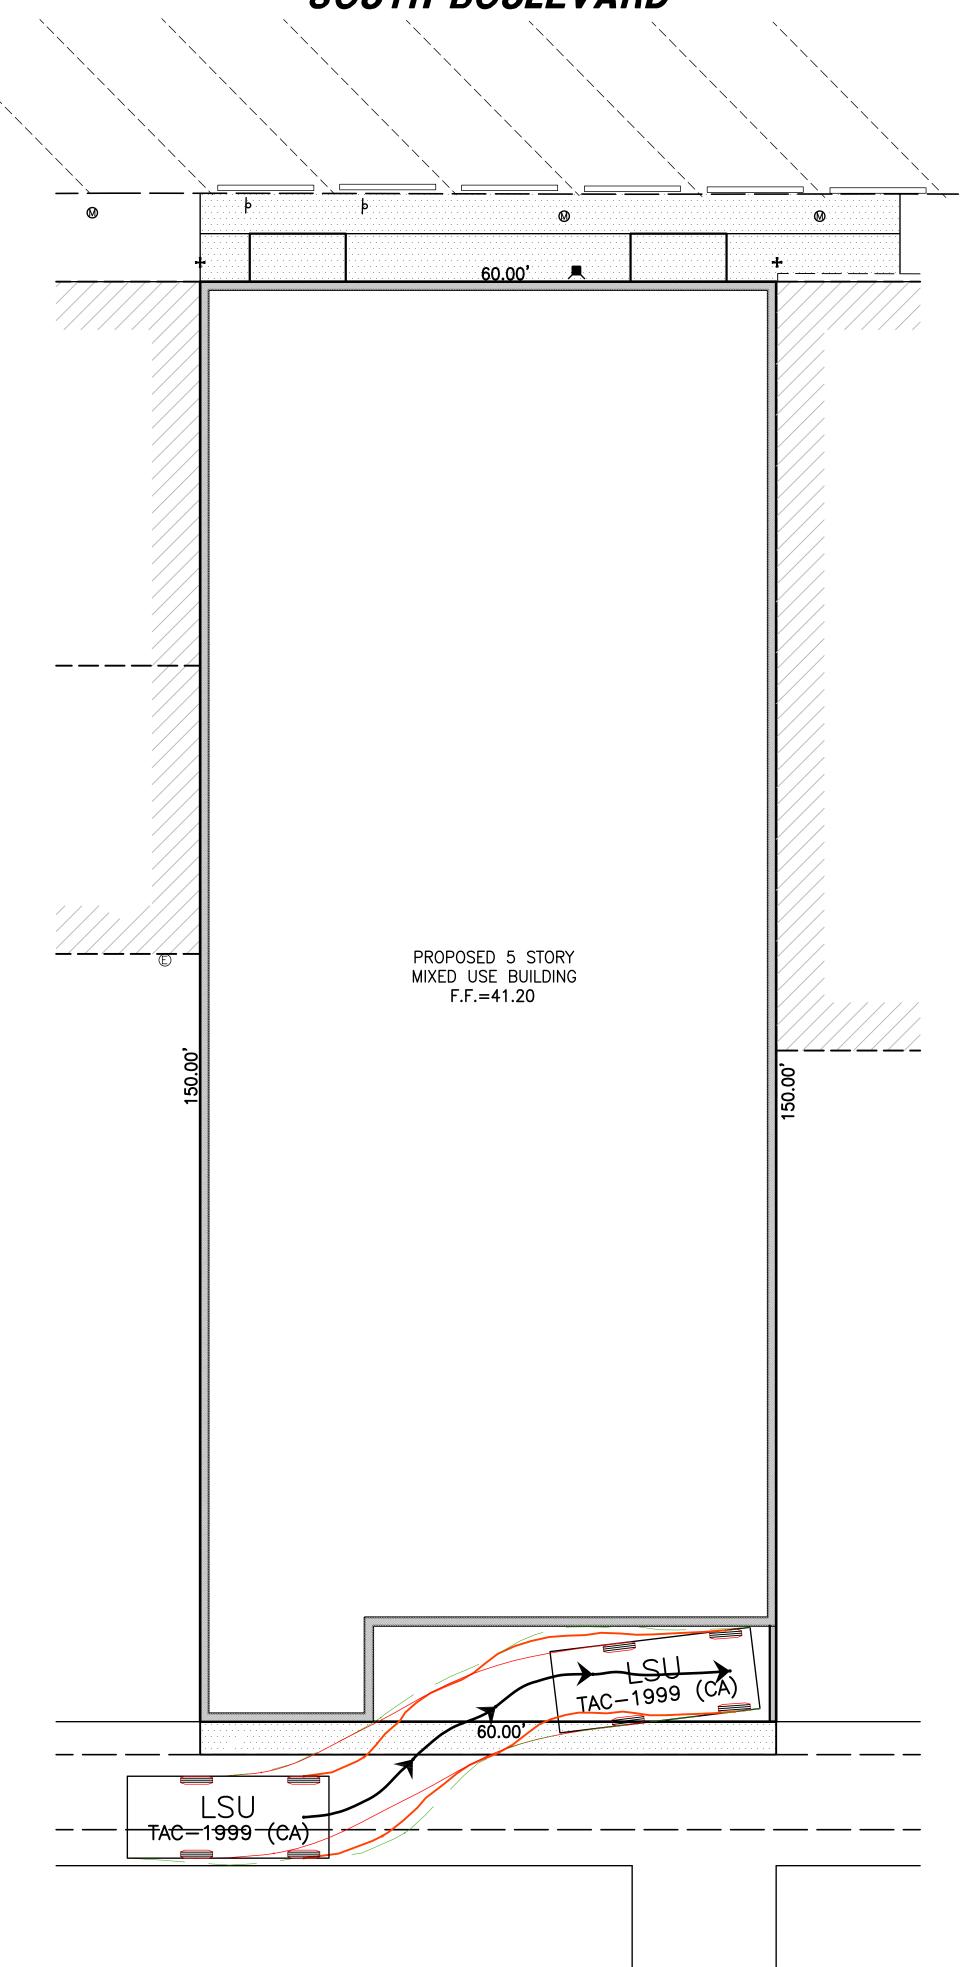MOTE

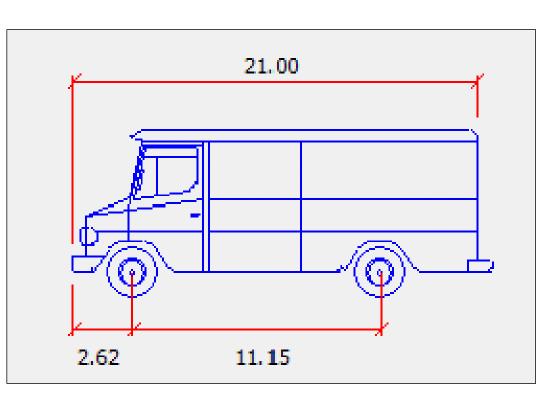BOUNDARY TAKEN FROM PLAT OF SURVEY PREPARED BY CHICAGOLAND SURVEY COMPANY INC.. BOUNDARY SHOWN IS ONLY AN ESTIMATE. THIS DRAWING IS NOT A PLAT OF SURVEY.

THE RESIDENCES AT SOUTH BOULEVARD

		DESIGNED BY:	DATE: 9-29-16	GREENGARD, INC.	SCALE:	1"=10'	715-717 SOUTH BOULEVARD - OAK PARK, ILL.
		CHECKED BY:	DATE: 9-29-16	111 Barclay Blvd., Suite 310, Lincolnshire, Illinois 60069—3615	RAWING No.	61247	AUTO-TURN EXHIBIT - LIGHT TRUCK
DRAWN BY: DATE:	REVISIONS	APPROVED BY: DMW	DATE: 9-29-16	PHONE: 847–634–3883 E–MAIL: 231@GREENGARDINC.COM FAX: 847–634–0687 ILL. REGISTRATION NO. 184–000995	SHEET	1 _{of} 1	AUTU-TURN EXHIBIT - LIGHT TRUCK

PD Application Item 28 GREATER DOWNTOWN MODEL

The Developer hereby states that, once approved by the Village Board, the developer shall produce a scale model for the Greater Downtown Model.

PD Application Item 29 ENERGY ANALYSYS

Given the fact that the proposed building will conform to LEED standards and current year energy code requirements and the nature of the building's intended use, the Applicant hereby requests a waiver from this requirement. Further, the inclusion of a geothermal heat source for a building on the scale as proposed and given the building's footprint on the site, is neither economical nor feasible.

PD Application Item 30 HISTORICALLY SIGNIFICAT PROPERTIES

Given the location of the proposed building and its specific location, the Applicant hereby requests a waiver from this requirement.

PD Application Item 31 LEED REQUIREMENTS

Given the fact that the proposed building will conform to LEED standards and current year energy code requirements and the nature of the building's intended use, the Applicant hereby requests a waiver from full documentation of LEED Certification. A third party LEED Rater will be engaged by the Developer.

PD Application Item 32 RECORDATION

The Developer hereby certifies that a final plat of recordation shall be filed with Cook County upon the Village of Oak Park Granting the rights requested within this application.

PD Application Item 33 NEIGHBORHOOD MEETING NOTICE

Citizen participation:

To maintain a high and representative level of citizen involvement in village affairs

To maximize opportunities for citizen involvement in the decision-making process

The Developer recognizes the importance of input from neighbors regarding development. Rather than waiting until the public hearing process to involve interested parties, the architect, John Schiess has hosted two neighborhood meetings prior to the submittal of this application.

717 SOUTH BOULEVARD, LLC

400 Ashland River Forest Illinois 60305

CORDIALLY INVITES YOU TO A

NEIGHBORHOOD MEETING

TO DISCUSS THE DEVELOPMENT OF THE PROPERTY AT 715-717 SOUTH BOULEVARD

WHERE:

Oak Park Public Library, Veteran's Room 834 Lake St. Oak Park, IL 60301

WHEN:

APRIL 14th, 2016 7:00 PM - 8:00 PM

The architect will make a presentation and answer questions regarding the proposed development.

-JUNE 28, 2016

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