


# OAK PARK ZONING MAP

Adopted March 6, 2023

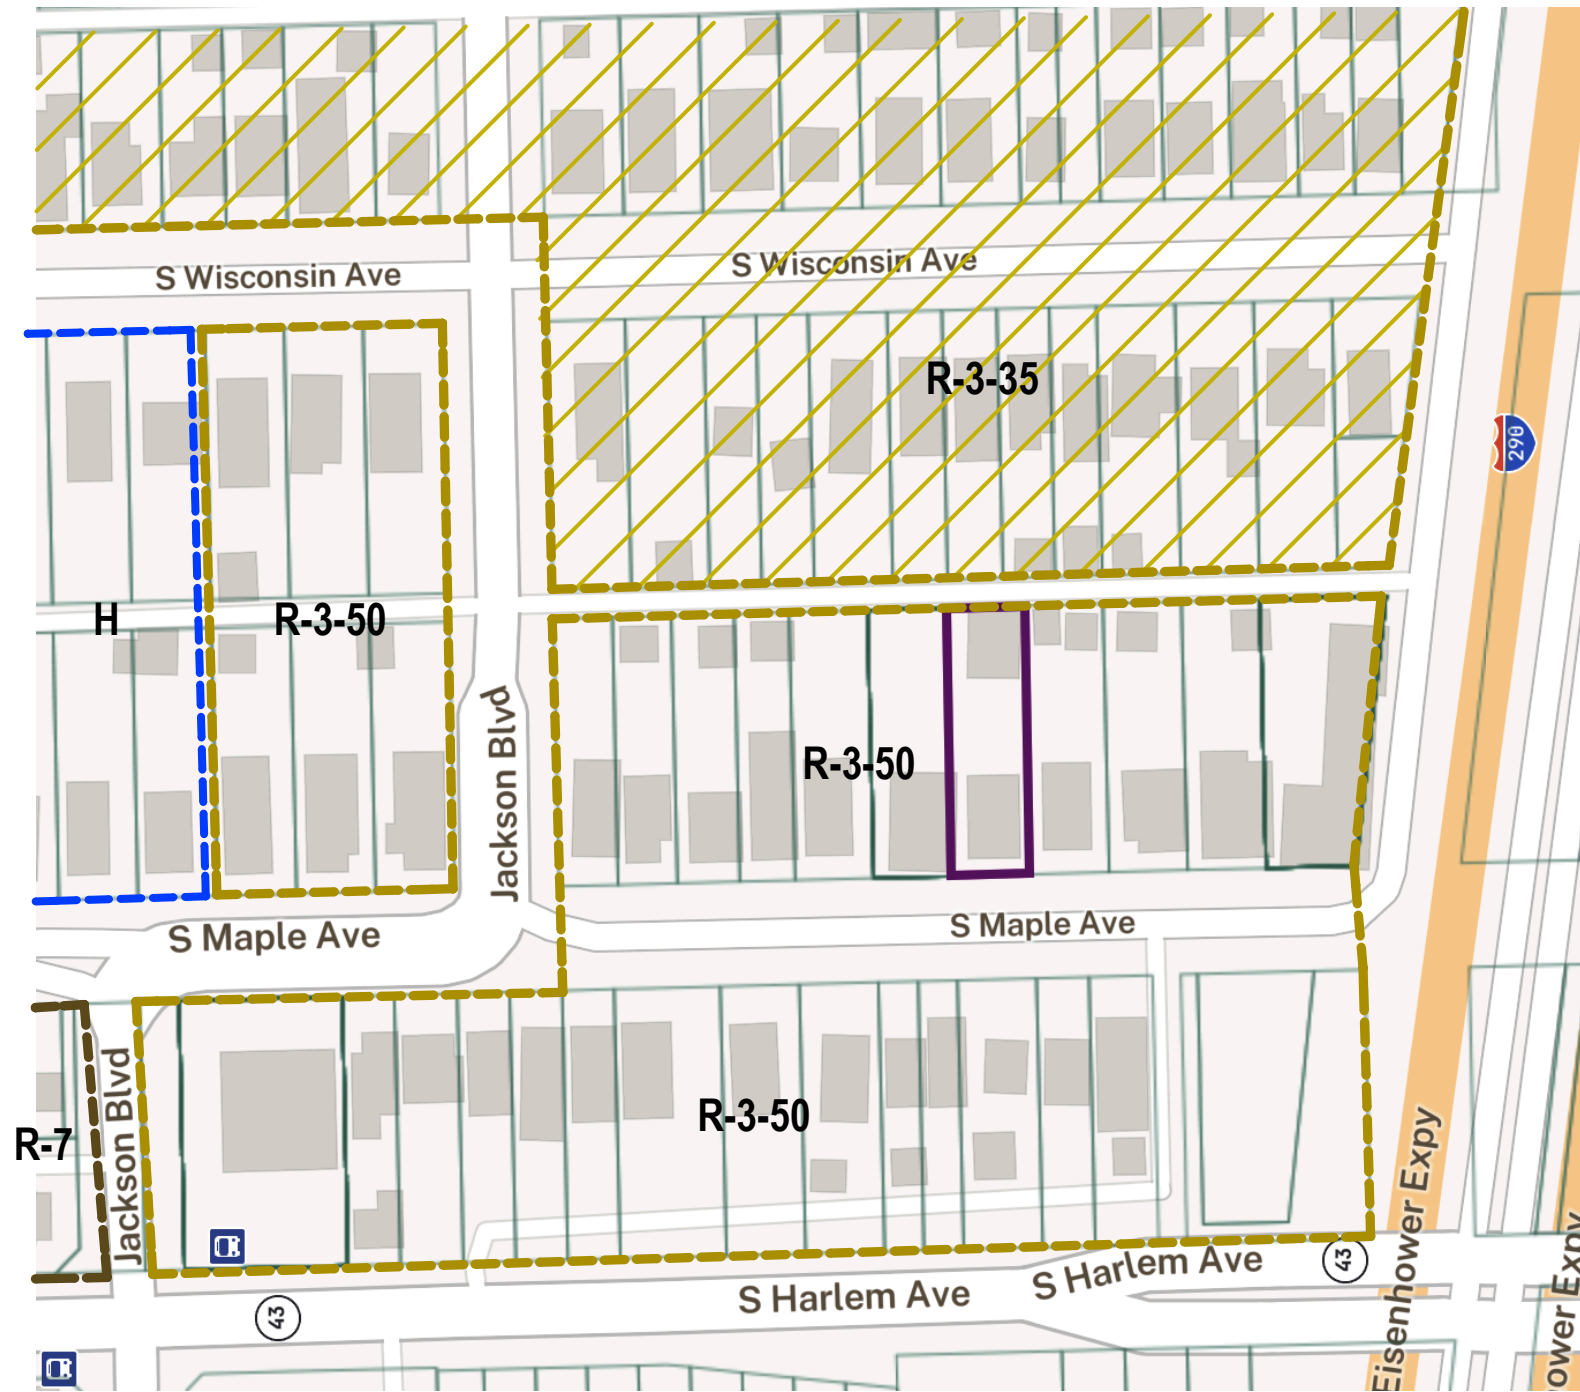

## LEGEND

- R-1 Single Family
- R-2 Single Family
- R-3-35 Single Family
- R-3-50 Single Family
- R-4 Single Family
- R-5 Two-Family
- R-6 Multi-Family
- R-7 Multi-Family
- NC Neighborhood Commercial
- GC General Commercial
- HS Harrison Street
- MS Madison Street
- NA North Avenue
- RR Roosevelt Road
- DT Downtown
- H Hospital
- OS Open Space
- I Institutional

**CURRENT ZONING DISTRICT**  
NOT TO SCALE



**John Conrad Schiess**

Architect + LEED AP

905 Home Avenue  
Oak Park Illinois 60304  
tel. 708.366.1500  
john@jcsarchitect.com

architecture +

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OWNER:  
**SERGIY ZAMULA**  
1324 Franklin Ave.  
River Forest, Illinois 60305  
630.687.0420  
zsklan111@yahoo.com

Issue for VARIATION	07.17.2024
Date	


820

S. MAPLE  
Oak Park Illinois  
60304

Sheet Title  
ZONING MAP

SK1.1

Sheet No.

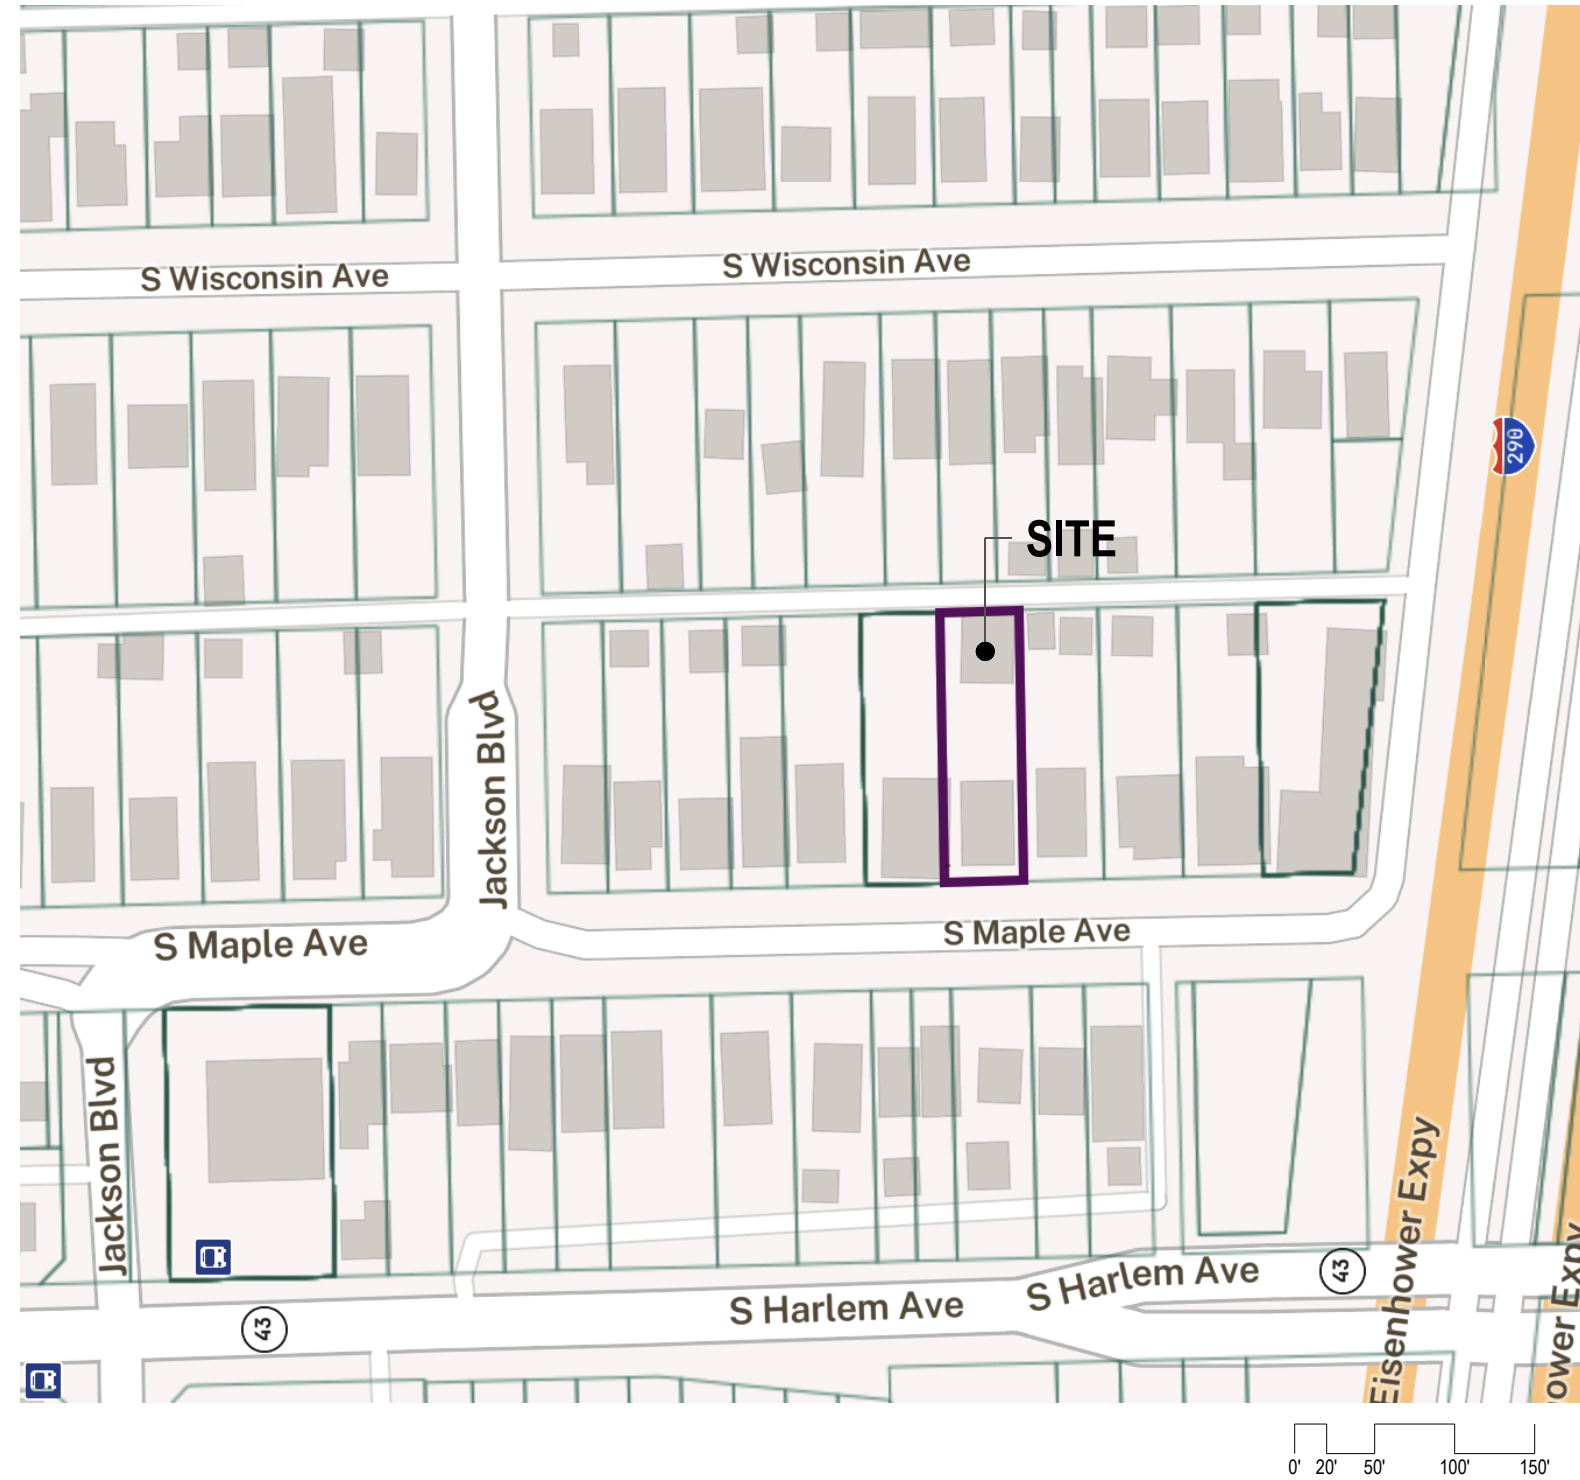

 **LOCATION MAP**  
SCALE: 1" = 100'-0"



**John Conrad Schiess**

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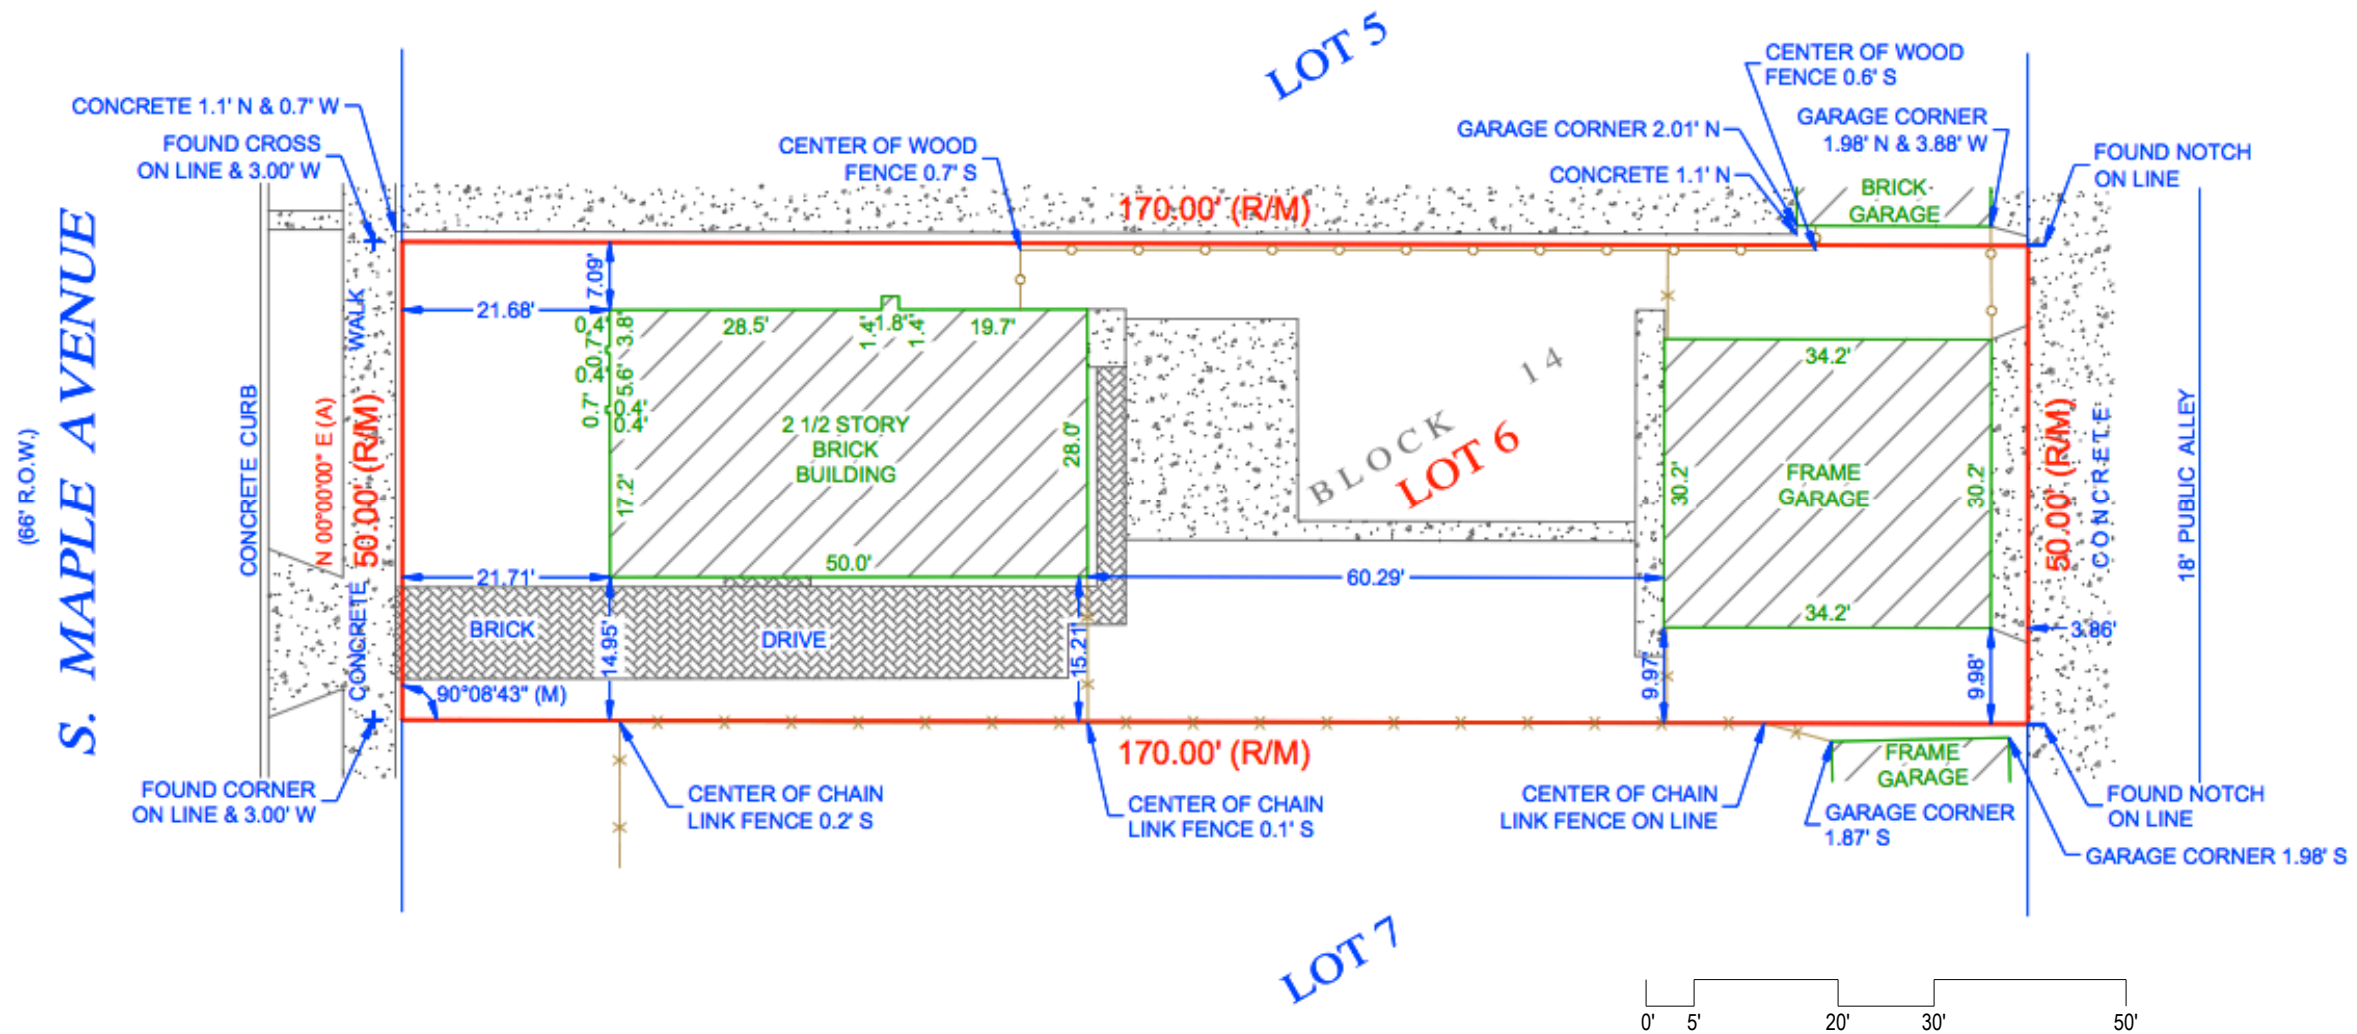
Issue for VARIATION	07.17.2024
	Date

**820**  
S. MAPLE  
Oak Park Illinois  
60304

Sheet Title  
LOCATION MAP

**SK1.2**

Sheet No.



 **SITE PLAN**  
SCALE: 1" = 20'-0"



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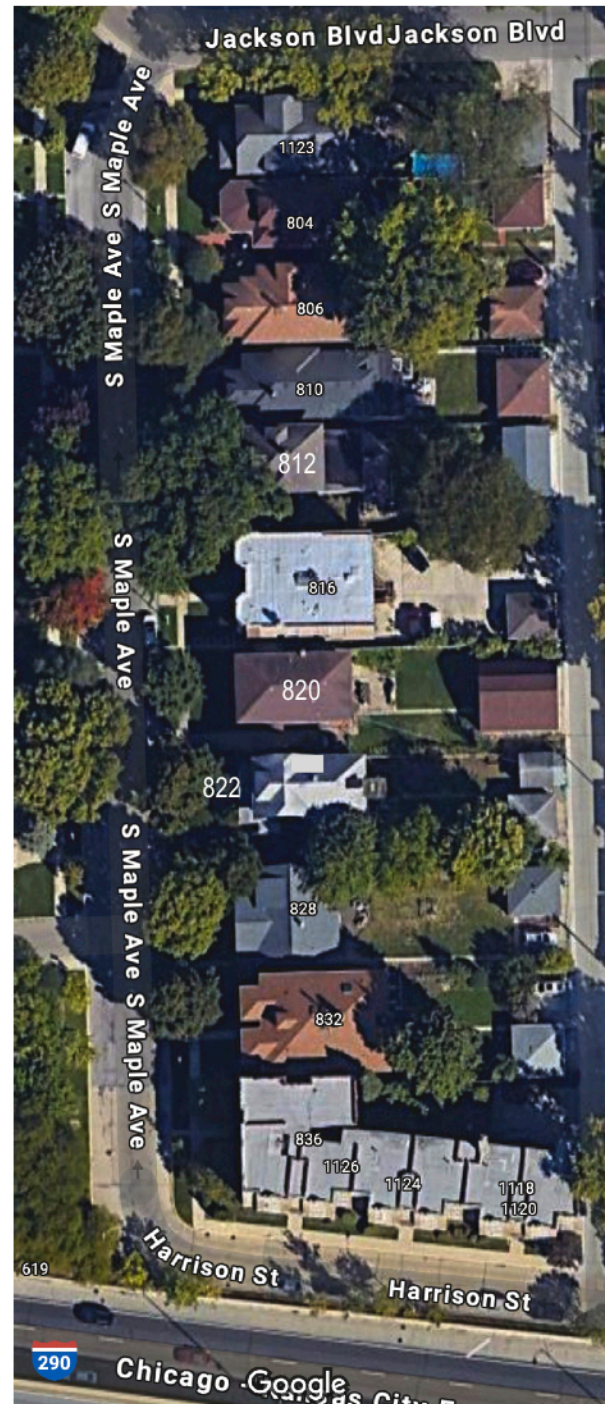
**820**  
S. MAPLE  
Oak Park Illinois  
60304

Sheet Title  
SITE PLAN

**SK1.3**

Sheet No.





812 MAPLE



822 MAPLE



828 MAPLE



810 MAPLE



820 MAPLE



832 MAPLE



806 MAPLE



816 MAPLE



836 MAPLE

PHOTOGRAPHS



John Conrad Schiess  
Architect + LEED AP

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Issue for VARIATION	07.17.2024
	Date

**820**  
S. MAPLE  
Oak Park Illinois  
60304

Sheet Title  
PHOTOGRAPHS

**SK1.4**

Sheet No.



**LEGEND**

A = ASSUMED  
 C = CALCULATED  
 CH = CHORD  
 CL = CENTERLINE  
 D = DEED  
 E = EAST  
 F.I.P. = FOUND IRON PIPE  
 F.I.R. = FOUND IRON ROD  
 FT. = FEET/FOOT  
 L = ARC LENGTH  
 M = MEASURED  
 N = NORTH  
 NE = NORTHEAST


NW = NORTHWEST  
 P.O.B. = POINT OF BEGINNING  
 P.O.C. = POINT OF COMMENCEMENT  
 R = RECORD  
 RAD = RADIUS  
 R.O.W. = RIGHT OF WAY  
 S = SOUTH  
 S.I.P. = SET IRON PIPE  
 S.I.R. = SET IRON ROD  
 SE = SOUTHEAST  
 SW = SOUTHWEST  
 W = WEST

# PLAT OF SURVEY OF

LOT 6 IN BLOCK 14 IN W. J. WILSON'S ADDITION TO OAK PARK, BEING A SUBDIVISION OF PART OF LOT 1 (EXCEPT THE FIRST 40 ACRES) IN SUBDIVISION OF SECTION 18, (EXCEPT THE WEST 1/2 OF THE SOUTHWEST 1/4) IN TOWNSHIP 39 NORTH, RANGE 13, EAST OF THE THIRD PRINCIPAL MERIDIAN, IN COOK COUNTY, ILLINOIS.


AREA OF SURVEY:

"CONTAINING 8,500 SQ. FT. OR 0.19 ACRES MORE OR LESS"

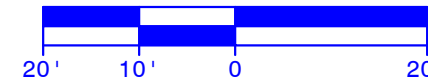

**BASIS OF BEARING:**  
 EAST LINE OF S. MAPLE AVENUE AS FOUND  
 MONUMENTED AND OCCUPIED.  
 N 00°00'00" E (A)

= CHAIN LINK FENCE  
 = WOOD FENCE  
 = METAL FENCE  
 = VINYL FENCE  
 = EASEMENT LINE  
 = SETBACK LINE  
 = INTERIOR LOT LINE

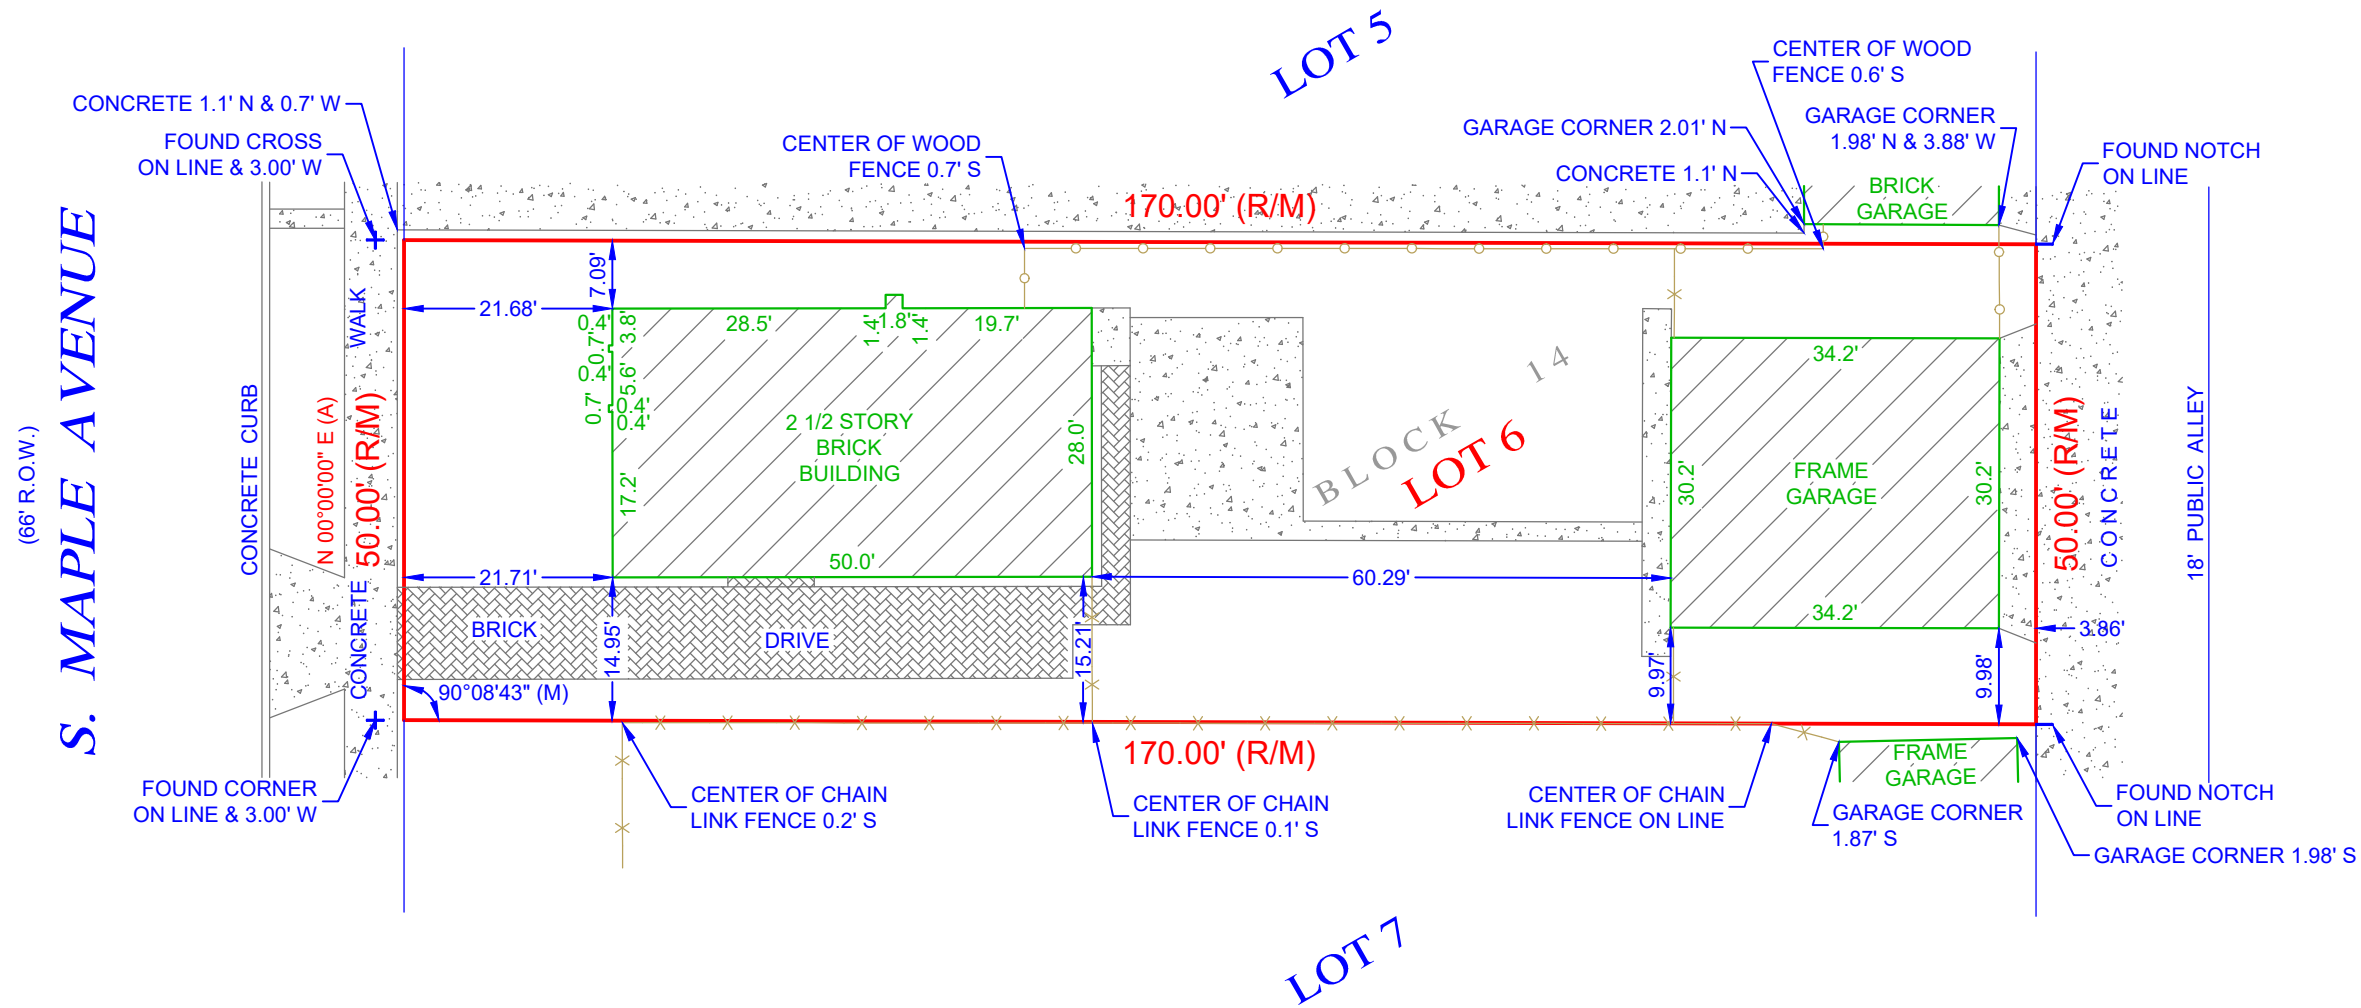

Morris Engineering, Inc.  
 515 Warrenville Road, Lisle, IL 60532  
 Phone: (630) 271-0770  
 FAX: (630) 271-0774  
 WEBSITE: WWW.ECIVIL.COM

STATE OF ILLINOIS }SS  
 COUNTY OF DUPAGE }  
 I, THE UNDERSIGNED, AN ILLINOIS PROFESSIONAL LAND SURVEYOR, DO HEREBY CERTIFY THAT "THIS PROFESSIONAL SERVICE CONFORMS TO THE CURRENT ILLINOIS MINIMUM STANDARDS FOR A BOUNDARY SURVEY," AND THAT THE PLAT HEREON DRAWN IS A CORRECT REPRESENTATION OF SAID SURVEY.  
 DATED, THIS 19TH DAY OF OCTOBER, A.D., 2023,  
 AT LISLE, ILLINOIS.

*Thomas J. Cesal*

ILLINOIS PROFESSIONAL LAND SURVEYOR NO. 035-2205  
 LICENSE EXPIRATION DATE NOVEMBER 30, 2024  
 ILLINOIS BUSINESS REGISTRATION NO. 184-001245



**NOTE:**

- ALL TIES SHOWN ON THIS SURVEY ARE MEASURED TO THE BUILDING'S SIDING (BRICK, FRAME, STUCCO, METAL, ETC.) AND NOT TO THE FOUNDATION, UNLESS NOTED OTHERWISE.
- ROOF LINES AND OVERHANGS ARE TYPICALLY NOT SHOWN HEREON.
- COMPARE ALL DISTANCES AND POINTS IN FIELD AND REPORT ANY DISCREPANCIES TO SURVEYOR AT ONCE.
- NO DIMENSIONS SHALL BE ASSUMED BY SCALING.

ADDRESS COMMONLY KNOWN AS 820 S. MAPLE AVENUE  
 OAK PARK, ILLINOIS  
 CLIENT SERGIY ZAMULA  
 FIELDWORK DATE (CREW) 10/17/2023 (MD/PC)  
 DRAWN BY: RT REVISED: JOB NO. 23-10-0131





# Application for Public Hearing VARIANCE

YOU MUST PROVIDE THE FOLLOWING INFORMATION: IF ADDITIONAL SPACE IS NEEDED, ATTACH EXTRA PAGES TO THE PETITION.

Name of Business (if Applicable): NOT APPLICABLE

Address/Location of Property in Question: 820 SOUTH MAPLE AVENUE OAK PARK, ILLINOIS 60304

Property Identification Number(s)(PIN): 16-18-127-007-0000

Name of Property Owner(s): SERGIY ZAMULA

Address of Property Owner(s): 1324 FRANKLIN AVENUE RIVER FOREST, ILLINOIS 60305

E-Mail of Property Owner(s): ZSKLAN111@YAHOO.COM Phone: (630) 687-0420

If Land Trust, name(s) of all beneficial owners: (A Certificate of Trust must be filed.) NOT APPLICABLE

Name of Applicant(s) (if different than Property Owner): SAME AS OWNER

Applicant's Address: \_\_\_\_\_

Applicant's Contact Information: Phone \_\_\_\_\_ E-Mail \_\_\_\_\_

Other: \_\_\_\_\_

Property Interest of Applicant:  Owner \_\_\_\_\_ Legal Representative \_\_\_\_\_ Contract Purchaser \_\_\_\_\_ Other \_\_\_\_\_

(If Other - Describe): \_\_\_\_\_

Property Type:  1 or 2 Family Residential  Multiple-Family  Commercial  Mixed-Use  Hospital  Institutional

Zoning District:  R-1  R-2  R-3(50)  R-3(35)  R-4  R-5  R-6  R-7

DT (1 - 2 - 3)  GC  HS  MS  NA  NC  RR

H  OS  I

Describe Variance Proposal: \_\_\_\_\_

*Permit the construction of a basement accessory unit in the building of the existing non-conforming two-family unit on premises known as 820 S. Maple in the R-3-5 single family zoning district.*



Size of Parcel (from Plat of Survey): 8,500 Square Feet

Adjacent:	Zoning Districts	Land Uses
To the North:	<u>R-3-50</u>	<u>SINGLE FAMILY</u>
To the South:	<u>EISENHOWER EXPY</u>	<u>ROADWAY</u>
To the East:	<u>R-3-35</u>	<u>SINGLE FAMILY</u>
To the West:	<u>R-3-50</u>	<u>SINGLE FAMILY</u>

Is the property in question currently in violation of the Zoning Ordinance?  Yes  No  
If Yes, how? \_\_\_\_\_

Is the property in question currently subject to any zoning relief?  Yes  No  
If Yes, how? \_\_\_\_\_  
If Yes, please provide relevant Ordinance No.'s \_\_\_\_\_

Is the subject property located within any Historic District?  Yes  No

If Yes:  Frank Lloyd Wright  Ridgeland/Oak Park  Gunderson

From what Section(s) of the Zoning Ordinance are you requesting approval / relief?

Article: 9.3 (B) (8)(a) Section: \_\_\_\_\_  
Article: \_\_\_\_\_ Section: \_\_\_\_\_  
Article: \_\_\_\_\_ Section: \_\_\_\_\_

Explain why, in your opinion, the grant of this request will be in harmony with the neighborhood and not contrary to the intent and purpose of the Zoning Ordinance or Comprehensive Plan;

This request is in harmony in that the cuurent property was built to accomodate three residential units.  
\_\_\_\_\_  
Moreover, the existing neighborhood has multi-family, 2, 3 and four unit  
properties.  
And the use is consistent with surrounding uses  
\_\_\_\_\_



I (we) certify that all the above statements and the statements contained in any papers or plans submitted herewith are true to the best of my (our) knowledge and belief.

I (we) consent to the entry in or upon the premises described in this application by any authorized official of the Village of Oak Park for the purpose of securing information, posting, maintaining and removing such notices as may be required by law.

SERGIY ZAMULA

(Printed Name) Applicant

[Signature]  
(Signature) Applicant

6/4/2024  
Date

SAME AS APPLICANT

(Printed Name) Owner

[Signature]  
(Signature) Owner

[Signature]  
Date


**Owner's Signature must be notarized**

SUBSCRIBED AND SWORN TO BEFORE ME THIS

04 DAY OF June, 2024

M. Smolik

(Notary Public)

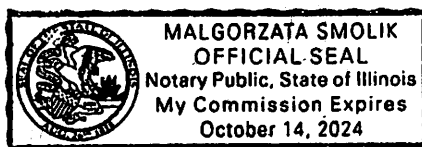

December 12, 2024

820 South Maple Avenue

## **Narrative**

### Historic context

The Applicant's is requesting to permit the construction of a basement accessory unit in the building of the existing non-conforming two-family unit at the premises known as 820 S. Maple in the R-3-5 single family zoning district. Historically, the property was built as a two-family residence. However, over the years, prior to the current owner's purchase of the property, the lower level was converted into a dwelling unit

It is clear by even a cursory investigation into the property's condition today that the property has been in economic decline due to deferred maintenance. The interior needs extensive repair, some of the windows need replacement and the interior improvements such as kitchens and bathrooms are not up to leasing standards. The Applicant will demonstrate that the property in its current condition will not be financially viable without the relief sought.

The relief sought, in the Applicant's view, is aligned with the Village's policy maker's stated intention of increasing the density of housing in strategic areas in the Village. This property is a perfect candidate for that strategic growth. It essentially, until recently been functioning as a three-unit property. Allowing the ADU to be zoning compliant as per this request, will not negatively impact neighbors or roadways in any meaningful way.

Therefore, the Applicant seeks relief from current zoning restrictions to allow the property to function as a three-unit development.



820 South Maple Avenue

December 12, 2024

### Section 14.3 Variation Standards

#### Approval Standards

1. The Zoning Board of Appeals decision must make findings to support each of the following:

- a. The strict application of the terms of this Ordinance will result in undue hardship unless the specific relief requested is granted.

Historically, the documents show that the home was converted into a three-unit multi-family building most likely because of certain historic economic challenges of that time. An additional unit was added in the lower level (basement) the then owner's economic hardship. Currently the structure houses three residential units – the basement unit is non-conforming.

More specifically, the property has experienced years of disinvestment because of the financial realities. These realities will be detailed for the Board of Appeals through testimony and other evidence.

If a strict application of the terms of this Ordinance are applied, and the subject property is forced to operate as a two-unit rental property, then it will not be financially feasible.

The applicant will testify and submit financial information that will demonstrate that the property, if the relief sought is not granted, will not provide a reasonable return on investment.

Simply, the applicant is seeking relief which will allow to the re-investment in the property and return the property as a worthy contributor to the neighboring area.

Now therefore, given the stated facts in and the facts to be submitted, if a strict application of the terms of this Ordinance are applied, it will result in undue hardship to the property.

b. The particular physical surroundings, shape or topographical conditions of the specific property impose a particular hardship upon the owner, as distinguished from a mere inconvenience, if the strict letter of the regulations were to be carried out.

The current building's size, specifically the amount of square footage, shape of the building's footprint and building height, underpin the hardship. The applicant will demonstrate through diagrams and testimony that the size and configuration of the existing units does not meet current market rental standards.

Now therefore, given the stated facts and the facts to be submitted, if a strict application of the terms of this Ordinance are applied, the result will result in undue hardship to the property.

c. The plight of the owner is due to unique circumstances inherent to the subject property and not from the personal situation of the owner and has not been created by any person presently having a proprietary interest in the property in question.

The plight of the owner and applicant related to this property are due to unique circumstances inherent to the subject property – specifically the property's location on a large lot that is over taxed for a two unit rental building, the building's footprint, unit sizes and configuration have not been created by any person presently having a proprietary interest in the property in question.



2. The Zoning Board of Appeals, in making its findings, may inquire into the following evidentiary issues, as well as any others deemed appropriate:

a. The granting of the variation will not be detrimental to the public health, safety, and welfare in the neighborhood in which the property is located.

The proposed property will be constructed in accordance with all applicable codes and ordinances adopted by the Village of Oak Park including the IRC building codes which govern construction type for the property. In following these codes and ordinances, the development's maintenance, and operation of the requested variation will not endanger the public health, safety, or welfare.

b. The proposed variation will not impair an adequate supply of light and air to adjacent property, substantially increase congestion in the public streets, increase the danger of fire, endanger the public safety, or impair property values within the neighborhood.

Similarly, the property, more specifically the basement unit, will be constructed in accordance with all applicable codes and ordinances adopted by the Village of Oak Park including the IRC building codes which govern construction type for the property.

In following these codes and ordinances, the property with the requested variation will not impair an adequate supply of light and air to adjacent property nor increase the danger of fire, endanger the public safety.

In terms of congestion, given the property's prior use as a three-unit rental property, the proposed use for a three-unit rental, the development will not increase congestion in the public streets.

Finally, the proposed development will, in the applicant's experience, help support adjacent and neighboring property values given the applicant's statements that the additional revenue will be used to reverse the disinvestment and physical deterioration.

c. The proposed variation is consistent with the spirit and intent of this Ordinance and the adopted land use policies.

The proposed use is compatible with the general land use of adjacent properties and other property with the immediate vicinity in that it generally complies with the zoning ordinance for this zone district since the property is currently a non-conforming multi-family property.

Further, the development generally complies with Envision Oak Park as it relates to providing unique ways to add residential uses throughout the Village and Oak Park's comprehensive plan for land uses in this zone district.

**END OF RESPONSES**

**General requirements**

- All construction shall be performed to comply with adopted by local municipality building & related codes, local amendments, regulations having jurisdiction and generally accepted industry standards. see A-1
- These drawings indicate the general scope of the project in terms of architectural design concept, major architectural elements, dimensions of the site and buildings. The drawings do not necessarily indicate all work required for full performance and completion of all requirements of the contract documents. Approach of design describe performance - based building method, engineering & detailing and assume suitable soil condition.
- This set of drawings does not include building material list. The owner/contractor is to provide products & assembly selection and coordinate installation.
- The term "Contractor" referred to as the General contractor, prime contractor for separate trade or contractor's authorized representative.
- Contractor are responsible to familiarize himself with local building codes, requirements for licenses, insurance, existing underground utilities, other facilities and current soil condition in the construction site.
- Contractors shall inspect the site, examine existing conditions, verify all dimensions of the proposed construction, protection of adjacent areas, trees, shrubs, etc. The nature and location of the work and all matters which may in any way affect the work or its performance.
- The Architect will review all notes, submittals given by the owner and incorporate them into the construction documents. The responsibility of the owner and contractor to verify all items on the drawings (sections, layout of walls, windows, features, etc.) Any discrepancy shall be resolved prior proceeding with construction.
- Contractor shall have full responsibility for the coordination with mechanical, electrical, plumbing drawings, other trades, various underground utilities on the site which shall remain intact, expedition and general supervision of all construction activity, fit and stability of all parts of the work. All trades are to coordinate their work with the size and location of all equipment prior to installation.
- The contractor shall be responsible to furnish all material required for the proper execution and completion of the work include any items which are not indicated on drawings but are implied and can be reasonable assumed.
- All labor, materials and installed shall meet the requirements of all adopted codes, ordinances, law regulations and safety orders and directives relating to the project. All work shall be performed in a good manner and to be complete and ready for use by the owner.
- Mechanical, electrical, plumbing works, as practically in industry, to be done by design - build entity. Design - build contractor for specific areas shall calculate and verify for all demand of required sources, size of selected equipment, devices, etc. for particular part of work.
- Do not scale drawings. Written dimensions always take precedence over scaled dimensions. Verify all dimensions in the field, on the event of any discrepancies notify the architect and owner before proceeding with construction.
- Drawing that represent existing plan conditions, if applicable, are shown diagrammatically. All dimensions shall be verified in the field and notified of any differences that will affect new work dimensions.
- All transitions of new work to existing walls, floor, ceiling parts shall be carefully executed. Existing construction shall be repaired as needed and patched to match finishes of adjacent surfaces.
- Before the start of any work the contractor shall notify utility companies (gas, water & sewer, electric, telephone etc.) for the location in the field of underground mains, cables or conduits.
- Contractor shall locate and do not disturb utility lines or disconnect same unless proper precautions are taken to provide the same utilities on a temporary or permanent basis without loss of continuity, arrange for temporary water supply and electrical service to the project.
- Contractor shall remove and dispose of all tools, equipment, surplus materials and rubbish pertaining to his work and cooperate with owner in final cleaning of the site.
- Contractor is responsible for scheduling and following up on all inspections.
- Contractor shall be responsible to carry sufficient insurance for the duration of the project. All work or corrective work shall be warranted for one year from the date of occupancy.

**Design criteria (psf, typical)**

Floor	-40 # LL 10# of typical all areas
Wall	-60 p.l.f. or actual load
Ceiling	-20 # LL 10# of limited attic storage
Cathedral	-30 # LL 15# of all slopes
Roof	-30 # LL 10# of roof slope over 3/12
Balcony	-40 # LL 10# of exterior
Deck	-40 # LL 10# of exterior
Rat roof deck	-40 # LL 10# of exterior
Stairwell	-40 # LL 20# of exterior
Wind load	-20 p.s.f.
Corners	-30 p.s.f.
Parapets	-40 p.s.f.
Snow load	-30 p.s.f.
Soil bearing capacity	-1500 psf.
Concrete compressive strength	-3500 psi.
Reinforcing steel	A.S.T.M. A615 - Grade 60
Structural steel	A992 - 50 ksi. for "W" Sections
F <sub>y</sub>	= 46 ksi. for Tube sections. A 36 for all other sections
Structural Framing Lumber:	
Grade #2 species SPF Canadian	Base Fb = 875
Grade #2 species SPF domestic	Base Fb = 875 treat.
Grade #1 species hem - fir	Base Fb = 1050
Manufacturer:	Truss joist McMillan, Microlam LVL size: 1 3/4" x Fb = 2,600 p.s.i. E = 1.9

**Typical indications**

	concrete foundation wall
	masonry wall
	existing partition
	new partition
	partition to be demolished
	tripple studs post
	beam/ header
	steel/ wood column
	load bearing partition

Floor finish materials: (per owner V.I.F.)  
 \* hardwood - in living & common areas  
 \* ceramic tiles - in bathrooms, laundry  
 \* hardwood or carpet - in bedrooms, closets, basement area

**Framing notes**

- All rough carpentry framing and materials shall comply with adopted codes on A-1.
- All framing shall be 16" o.c. unless noted otherwise. All un-dimensioned partition are 3 1/2" rough. All wall heights are assumed single 2x bottom plate and double 2x top plate. (u.n.o.) All interior non-load bearing walls to be 2x4 studs @ 16" o.c. (u.n.o.)
  - Walls are dimensioned to face of stud. All plumbing walls shall be 2" x 6" wood studs. All angled partitions to be 45 degrees (u.n.o.) Min. bearing of a wood joist on wood to be 1 1/2" min. Min. bearing of wood joist or girder on concrete or masonry to be 3" min.
  - Install proprietary connections in conformance with manufactures installation requirements. No stud to be notched - drilled only. Utilize structural stud shoe.
  - Provide anchorage of walls and columns to roof and foundation to resist uplift and sliding forces. Refer to the fastening schedule of adopted codes. Nailing not shown on drawings. Use fasteners of appropriate type and length. Space fasteners to comply with adopted codes and nailing schedule. Pre-drill members when necessary to avoid splitting wood.
  - Provide double joists under parallel partitions, kitchen granite counters and bath tubs above or blocking between floor trusses attached to upper cord and vertical web posts or diagonal braces in the area interrupted by pipes/ ducts. Split joists to allow for electric, plumbing and mechanical trades.
  - All exterior framing and framing in contact with concrete or masonry shall be pressure treated or decay resistant to exterior exposure. Provide hot dipped galvanized steel fasteners.
  - Provide a continuous 2x6 treated wood nailed on top of all steel beams except those used for supporting masonry. All framing corners to be triple studs. Provide horizontal blocking in wall over 10'-0" ht., ladder type vertical connections for interior to exterior walls. Provide 3-2x6 between mullied windows with 3 or more units & min. 3'-0" stud post under all bearing points unless otherwise noted.
  - Verify min. 6'-9" headroom before locating structural members above stair flight.
  - Provide blocking for kitchen & bath cabinets and applicable grab bars installation. Verify location.
  - Enclosed accessible space under stairs to be protected on the enclosed side with 5/8" type "x" drywall.
  - All beams and columns supporting fire rated wall/ceiling assembly shall be enclosed accordingly.
  - Fire stopping is to be provided at the following locations:
    - concealed spaces of studs walls and partitions, including turned spaces, at the ceiling and floor level.
    - at ten foot (10') intervals both vertical and horizontal.
    - all interconnections between concealed vertical and horizontal spaces, such as occurs at soffits, drop ceilings voce ceiling etc.
    - concealed spaces between stair stringers at the top and bottom of the run.
    - opening around vents, pipes, ducts, chimney and fireplaces at ceiling and floor level, without noncombustibles. Use 4 psf. mineral wool. Provide fire caulk as per code. Energy seal foam around all windows, doors, outlets, conduit and penetrations.
  - Provide draftstop material behind tubs and showers on outside walls, insulate walls, floor & ceiling surrounding bathroom for sound, undercut door or transfer grill for fresh air intake fan.
  - All materials at stairwells for interior wall & ceiling finish shall be class 1 f.s.r. (index 0-25 ). Both floor and walls with shower heads shall be with non-absorbent surface 6 ft. min. a.f.f.
  - Kitchen and bath design provided as a concept. Owner's selection of kitchen/ bath cabinets, fixtures & appliances, wall & floor finish materials, windows and doors to be coordinated by General contractor with shop drawings approved by Architect.
- \* see details for additional information \*

**Advanced Notice of the Developer - Architect agreement**

- The documents and work as set out in the attached Proposal are the intellectual property of the Architect and are to be used for the particular project listed in the Proposal only. The project is to be built by a lawfully licensed Contractor, who is knowledgeable in the building trades and has experience in this type of construction. The term "Contractor" refers to General Contractor, Prime Contractor for separate trades or Contractors, and/or authorized representative.
- The architect is not supervising the construction.
- The architect shall not have any control over, in charge of or responsibility for the construction means, methods, techniques, procedures or the safety precautions in connection with the construction process.
- Pursuant to the attached Proposal, the following areas are solely the Contractor's responsibility:
  - Each Contractor shall observe all local, state and federal rules and regulations regarding safety and shall provide all necessary equipment in order to safeguard or protect the health of all the workers on the construction site. The Contractor shall explain, instruct, and direct all workers under their control to follow all the necessary safety rules and regulations.
- The Developer and/or Contractor shall report to the Architect any structural, egress and fire protection system changes provided during construction. The Architect is not responsible for the Developer's directives, changes or substitutions, made without prior approval of the Architect.
- The Developer and/or Contractor shall promptly report to the Architect any errors, omissions, inconsistencies or nonconformity that are discovered during the construction process and/or as a result of a request for information. Failure to promptly notify of errors or omissions may result in liability for the Developer and/or Contractor for remediation costs.
- The Developer and/or Contractor shall submit to the Developer and copy to the Architect a Certificate of Commercial Liability insurance, which includes the Developer and Architect as additional insured for claims caused by the Contractor's negligent acts and/or omissions during the Contractor's completion of the operation of this project.
- The Developer and/or Contractor shall indemnify and hold harmless the Architect from any and all claims against arising out of the Contractor's failure of performing any of the work.
- The Developer and/or Contractor, to the fullest extent permitted by law, agrees to protect and defend, indemnify and hold harmless the Architect of this project. It is intended to apply to any liability or causes of actions and/or other expenses, arising out of or the direct result of the negligence of the Developer and/or Contractor or their failure to perform any of their work.
- It is the responsibility of the Owner/ Developer to instruct the General Contractor and/or separate Prime Contractors with the information, as stated above.


**Proposed work description:**

- Alteration - level 2**
- Basement floor:**  
 basement storage to living room conversion and laundry room separation, kitchen redesign, living room to bedroom conversion. New closets for bedrooms. Affected area - 338 sf (exist. basement floor - 1400 sf)
- 1st floor:**  
 kitchen redesign, living room to bedroom conversion, new laundry closet, master bath redesign, new closet for bedroom 2 and new mech closet. Affected area - 397 sf (exist. 1st floor - 1400 sf)
- 2nd floor:**  
 kitchen redesign, living room to bedroom conversion, new laundry closet, master bath redesign, new closet for bedroom 2. Affected area - 397 sf (exist. 1st floor - 1400 sf)  
 -New AC and furnaces, existing mechanical ductwork. Existing electrical system with changes for redesign areas. New electrical service.  
 -Existing plumbing, and water service with changes for washer/dryer connection and new mech and laundry closets floor drains. New plumbing fixtures.

**Building data:**

- \*Building height: exist.
- \*Basement: 1400 sf.
- \*First floor: 1400 sf.
- \*Second floor: 1400 sf.
- \* Total: 4,200 sf.

Occupancy Group Classification: R-2  
 Type of construction: Type IIIA

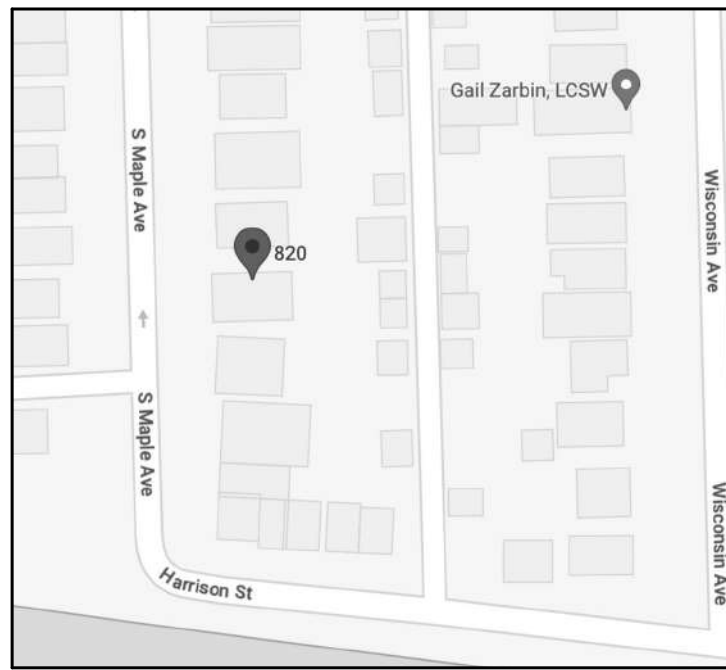

**Project location**


**ADOPTED CODES :**

- 2021 International Building Code w/ amendments
- 2021 International Existing Building Code
- 2021 International Energy Conservation Code w/ amendments
- 2020 National Electrical Code w/ amendments
- 2021 International Mechanical Code w/ amendments
- 2014 Illinois Plumbing Code
- 2021 International Fire Code w/ amendments
- 2021 International Fuel Gas Code

State & Federal agency requirements  
 Local AHJ ordinances

Approved full size copy of Construction Documents shall be on site for all inspections \*\*

**S. MAPLE AVENUE**

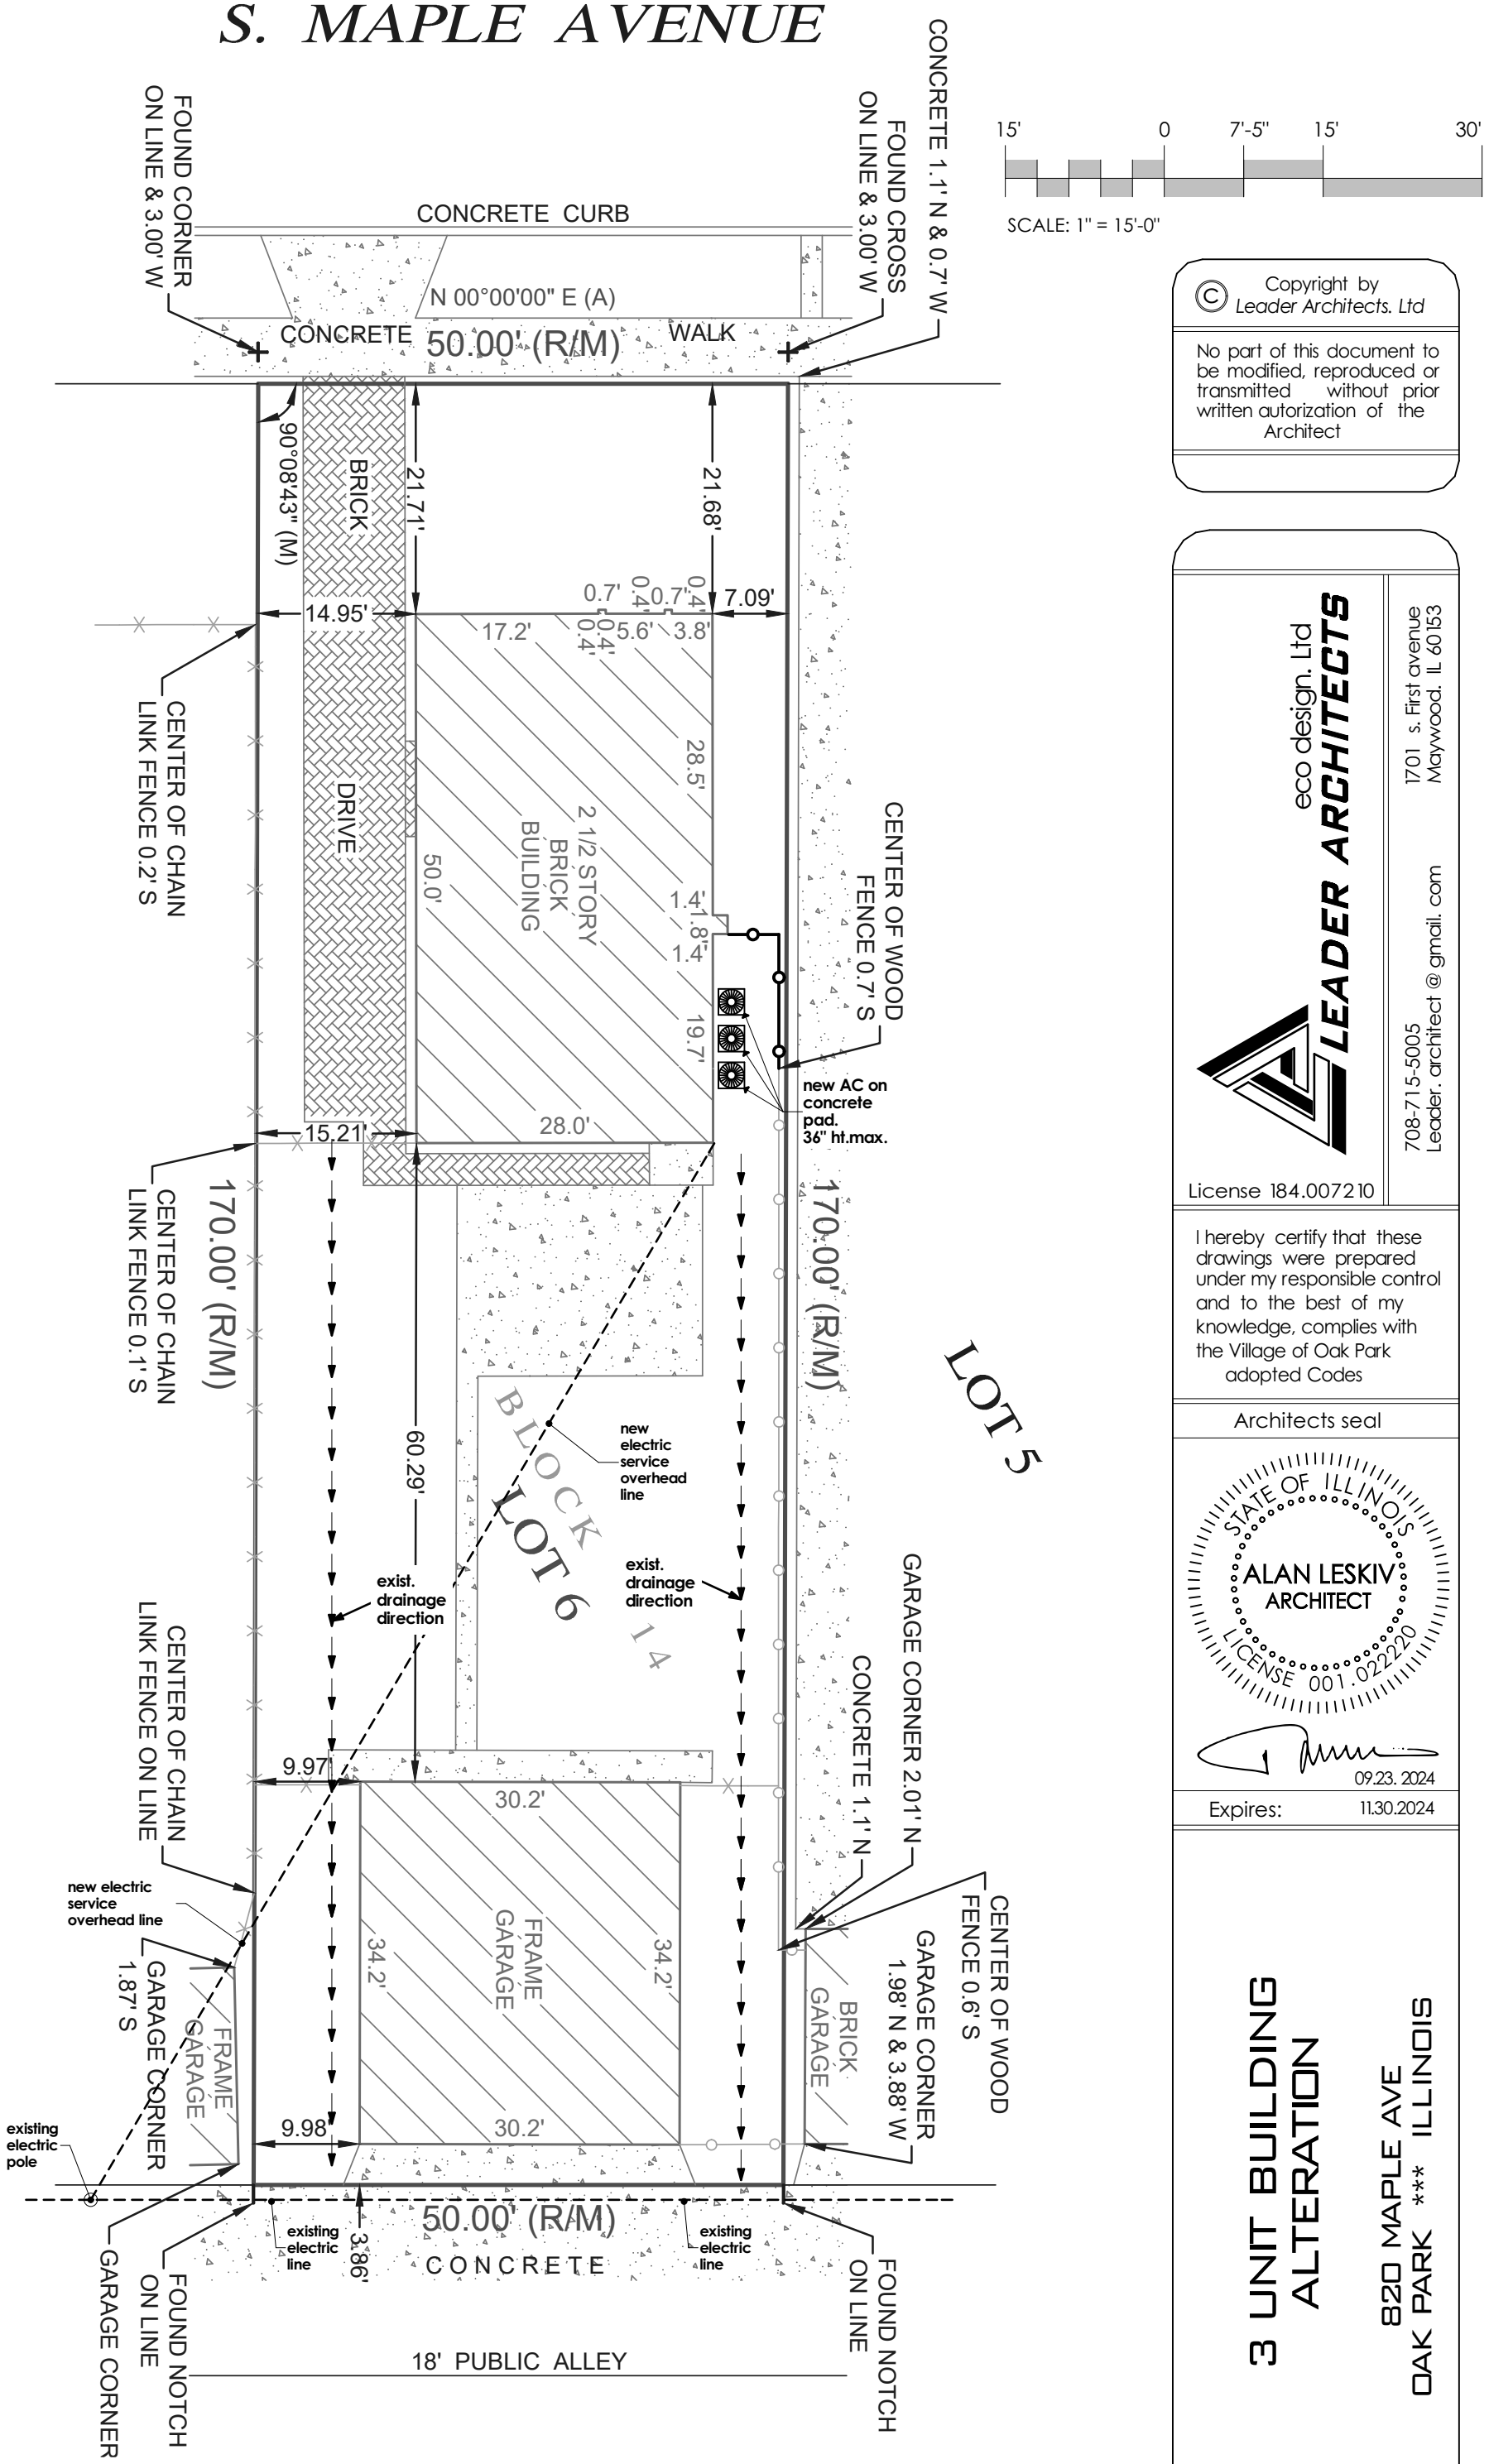

**Architectural Site Plan**

SCALE: 1" = 15'

Note:  
 - Provide a rapid entry lock box on front of building next to building entry door IFC 506.1

-No sprinkler system installed

Note:  
 If the electric service lines are within 10 feet of the proposed construction/excavation, or less than 3 feet above the roof ridge, or less than 8 feet above a flat roof, the service lines shall be moved or removed.

**sheet index:**

- A-1 Architectural site plan, Notes
- A-2 Demo floor plans
- A-3 Floor Plans
- A-4 Mechanical floor plans
- A-5 Mechanical roof plan, notes, schedules
- A-6 Electrical floor plans
- A-7 Electrical notes, Plumbing

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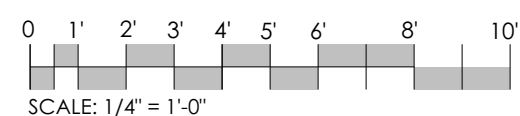
STATE OF ILLINOIS  
**ALAN LESKIV**  
 ARCHITECT  
 0923.2024  
 Expires: 11.30.2024

**3 UNIT BUILDING ALTERATION**  
 B20 MAPLE AVE  
 OAK PARK \*\*\* ILLINOIS

Project #	24-124
Date:	09.23.2024
Drawn by:	AL
Checked:	LA
Revision 1:	
Revision 2:	
Revision 3:	

Sheet #  
**A-1**  
 Scale: as shown





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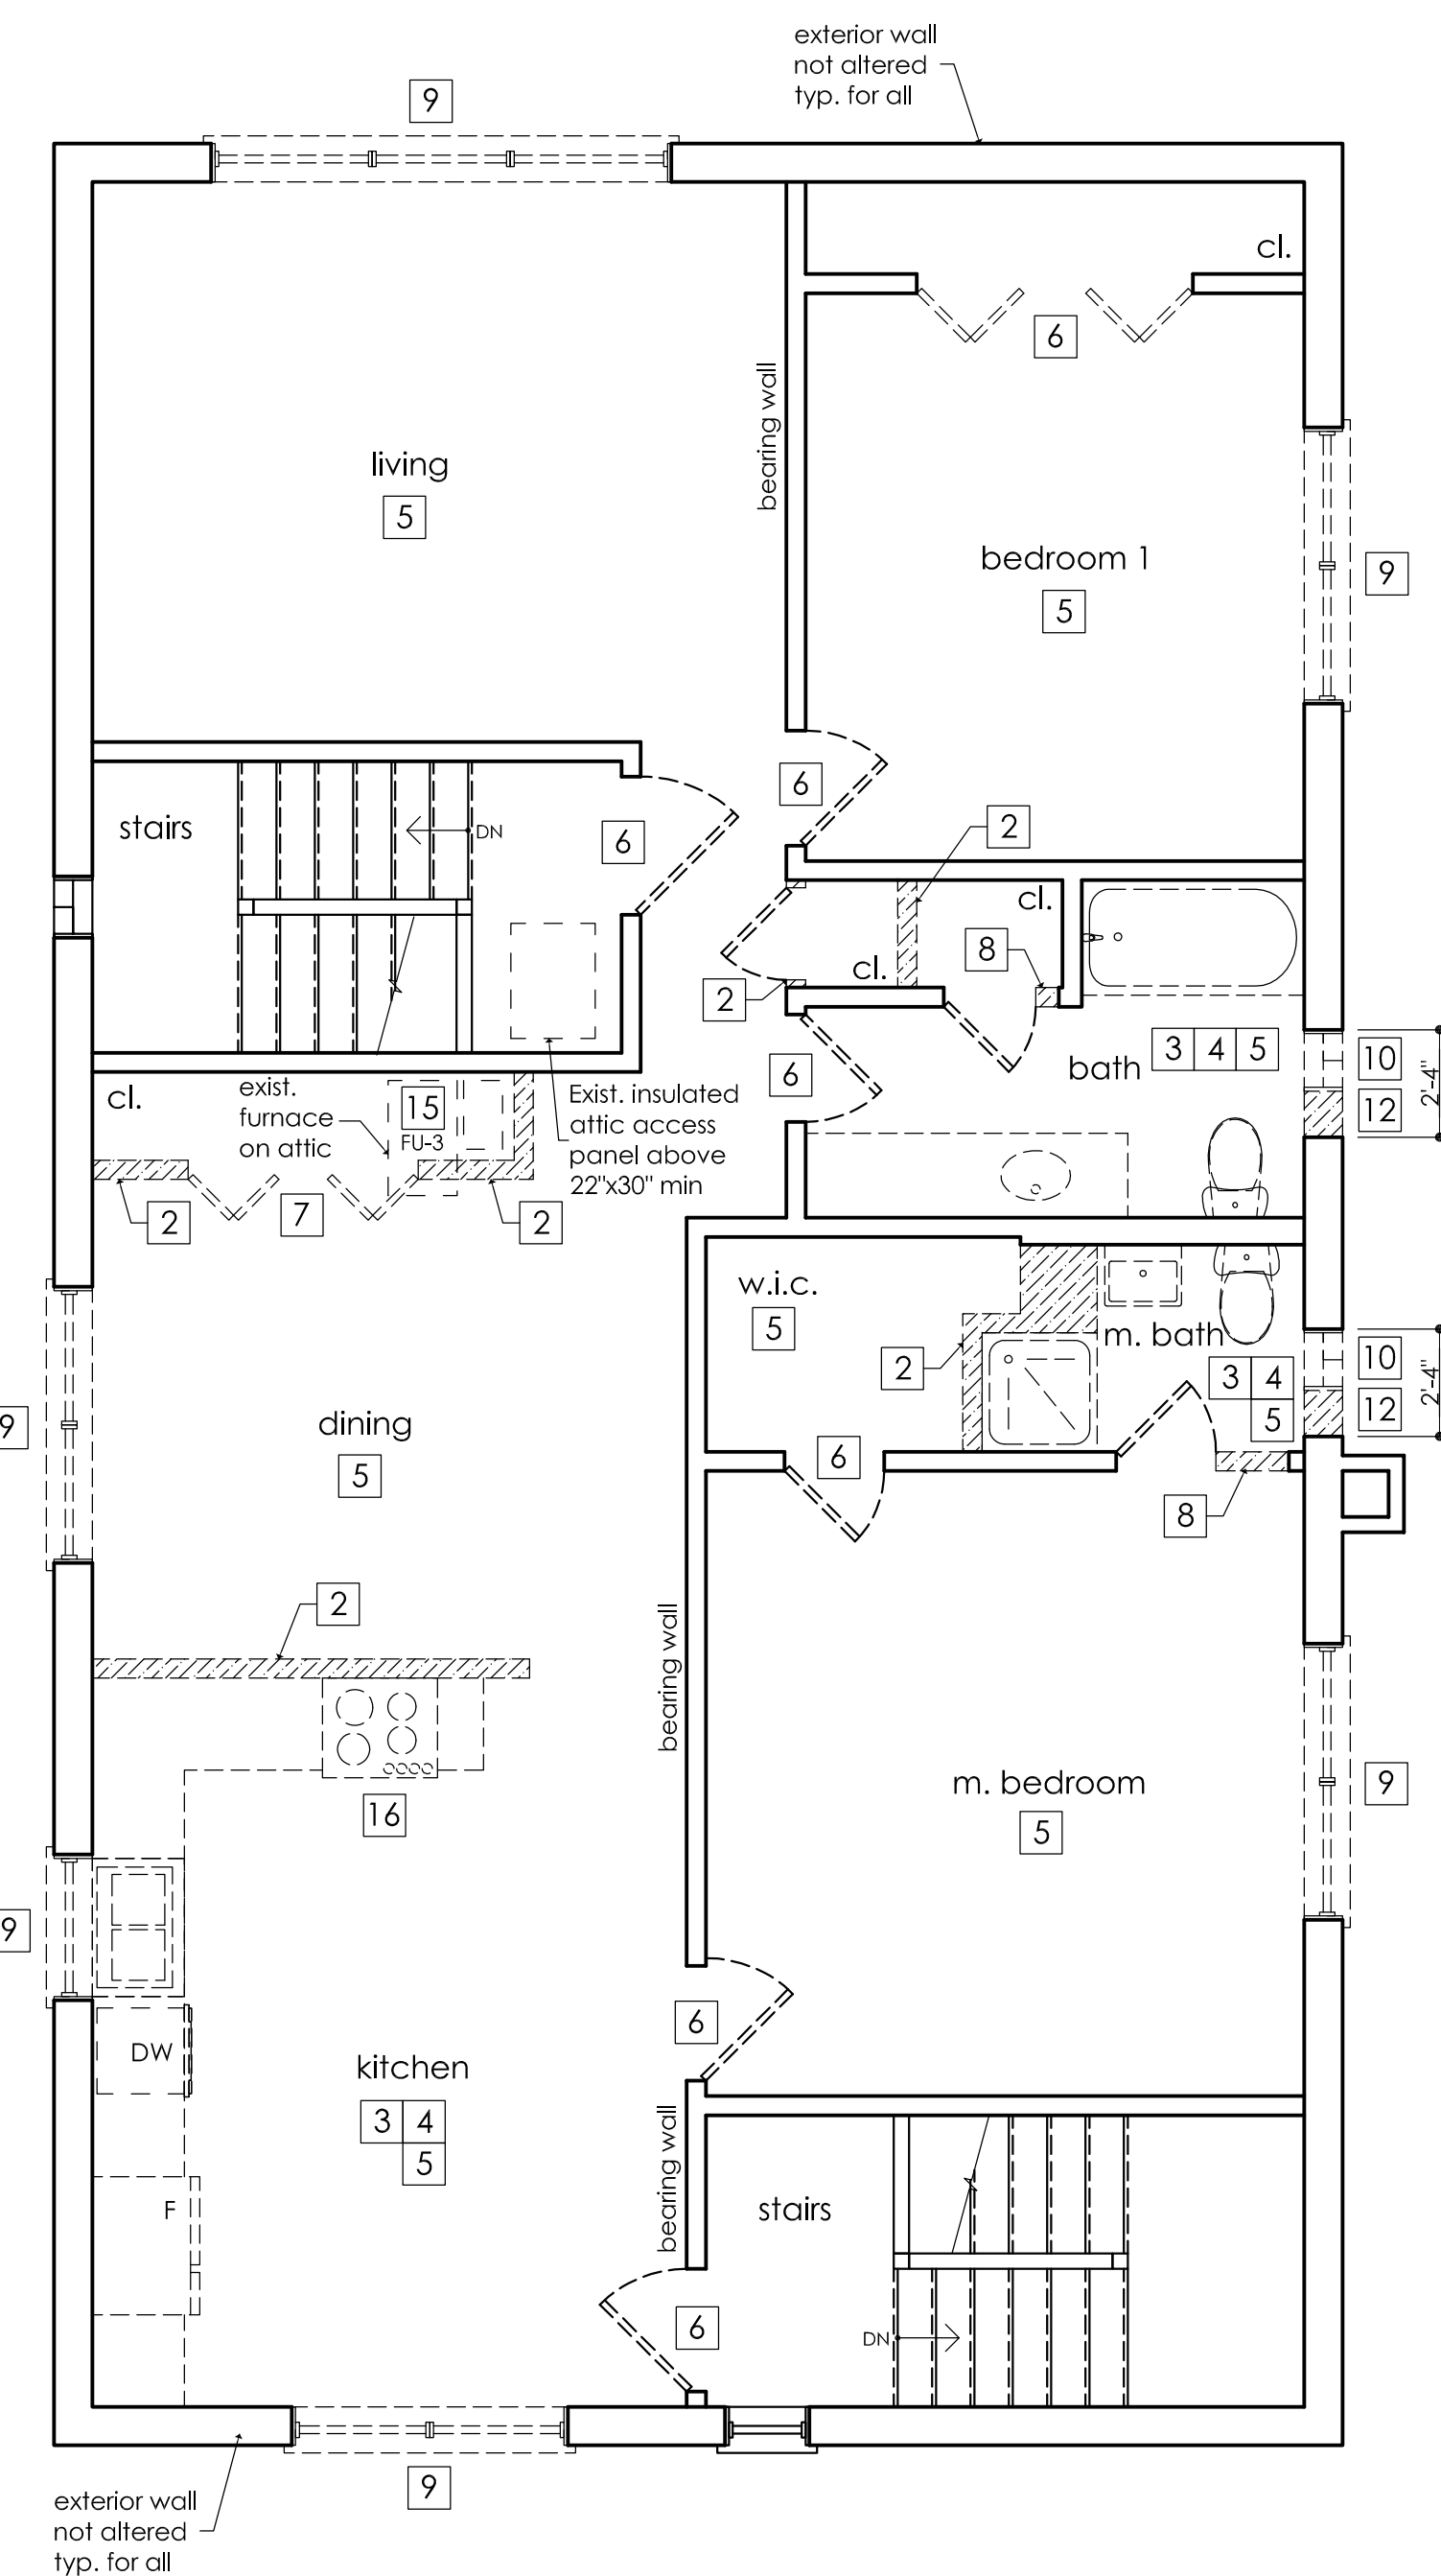
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**DEMOLITION KEYS**


- 1 Remove existing partition, prepare opening for new door
- 2 Remove existing partition top to bottom
- 3 Remove and replace existing plumbing fixtures and cabinets
- 4 Repair or replace existing piping: supply branch and riser, waste branch, stack and vent as necessary
- 5 Refinish existing flooring material, replace with new flooring as needed
- 6 Remove and replace existing door with same size and location
- 7 Remove existing door
- 8 Remove existing door, prepare opening for new door
- 9 Remove and replace existing window with same size and location
- 10 Remove existing window, prepare opening for new window
- 11 Remove existing door, infill partition to match existing
- 12 Remove existing partition, prepare opening for new window
- 13 Relocate existing electric panel
- 14 Relocate existing electric meter
- 15 Remove existing furnace, keep existing ductwork
- 16 Remove gas line back to source

**Safety & Demolition notes**


1. Contractor shall provide temporary safety fence around work area, debris dumpster and temporary toilet, before starting construction.
2. Provide all barricades or other temporary protection as may be required for general safety around all open pits or trenches in its vicinity.
3. Contractor shall erect and maintain all reasonable safeguards for safety and protection of the public including the posting of danger and other warning signs against hazards.
4. Contractor shall be responsible for adequately bracing to reach structural integrity and protecting all parts of work during construction against damage, breakage collapse, from weather due to frost, rain, wind, etc., and repair any portion of existing and newly added work. Must be braced - all masonry walls which being laid during one working day for 8 ft. in height, frame walls until is connected to structural frame elements, floor or roof.
5. Drawings represents existing plan conditions that to be removed, relocated or to remain are shown diagrammatically and shall be verified in field by contractor.
6. Demolition contractor shall comply with all laws, ordinances, standards and regulations for the safety of persons or property to protect them from damages, injury or loss.
7. Contractor shall notify utility companies to disconnect service and obtain written notification of it.
8. Contractor shall demolish all items noted and associated in scope of work and responsible for complete removal within demolished area.
9. Demolition shall be accomplished with appropriate tools and equipment so as not to create damage to areas intended to remain, adjacent properties, underground utilities.
10. Contractor are fully responsible for the condition of existing building once construction begins and any damage caused by demolition.
11. In the event of removal of any load bearing partition or structure, appropriate shoring shall be provided as required to support the adjacent loads of structure. Shoring shall be designed to support the full loads superimposed with the appropriate safety factors, comply with adopted local, state and federal codes & standards.
12. Notify Architect when structural members are to be cut or removed. Maintain necessary stability of the structure and remodeled work safe, inform the Architect if any cracks or other structural changes become visible or unstable after existing parts demolition.
13. All openings made in exterior walls during demolition are to be covered by safety barriers as required by code, and to be secured against forced entry through the period that openings are under construction.



**Demo 2nd Floor Plan**  
SCALE: 1/4" = 1'-0"

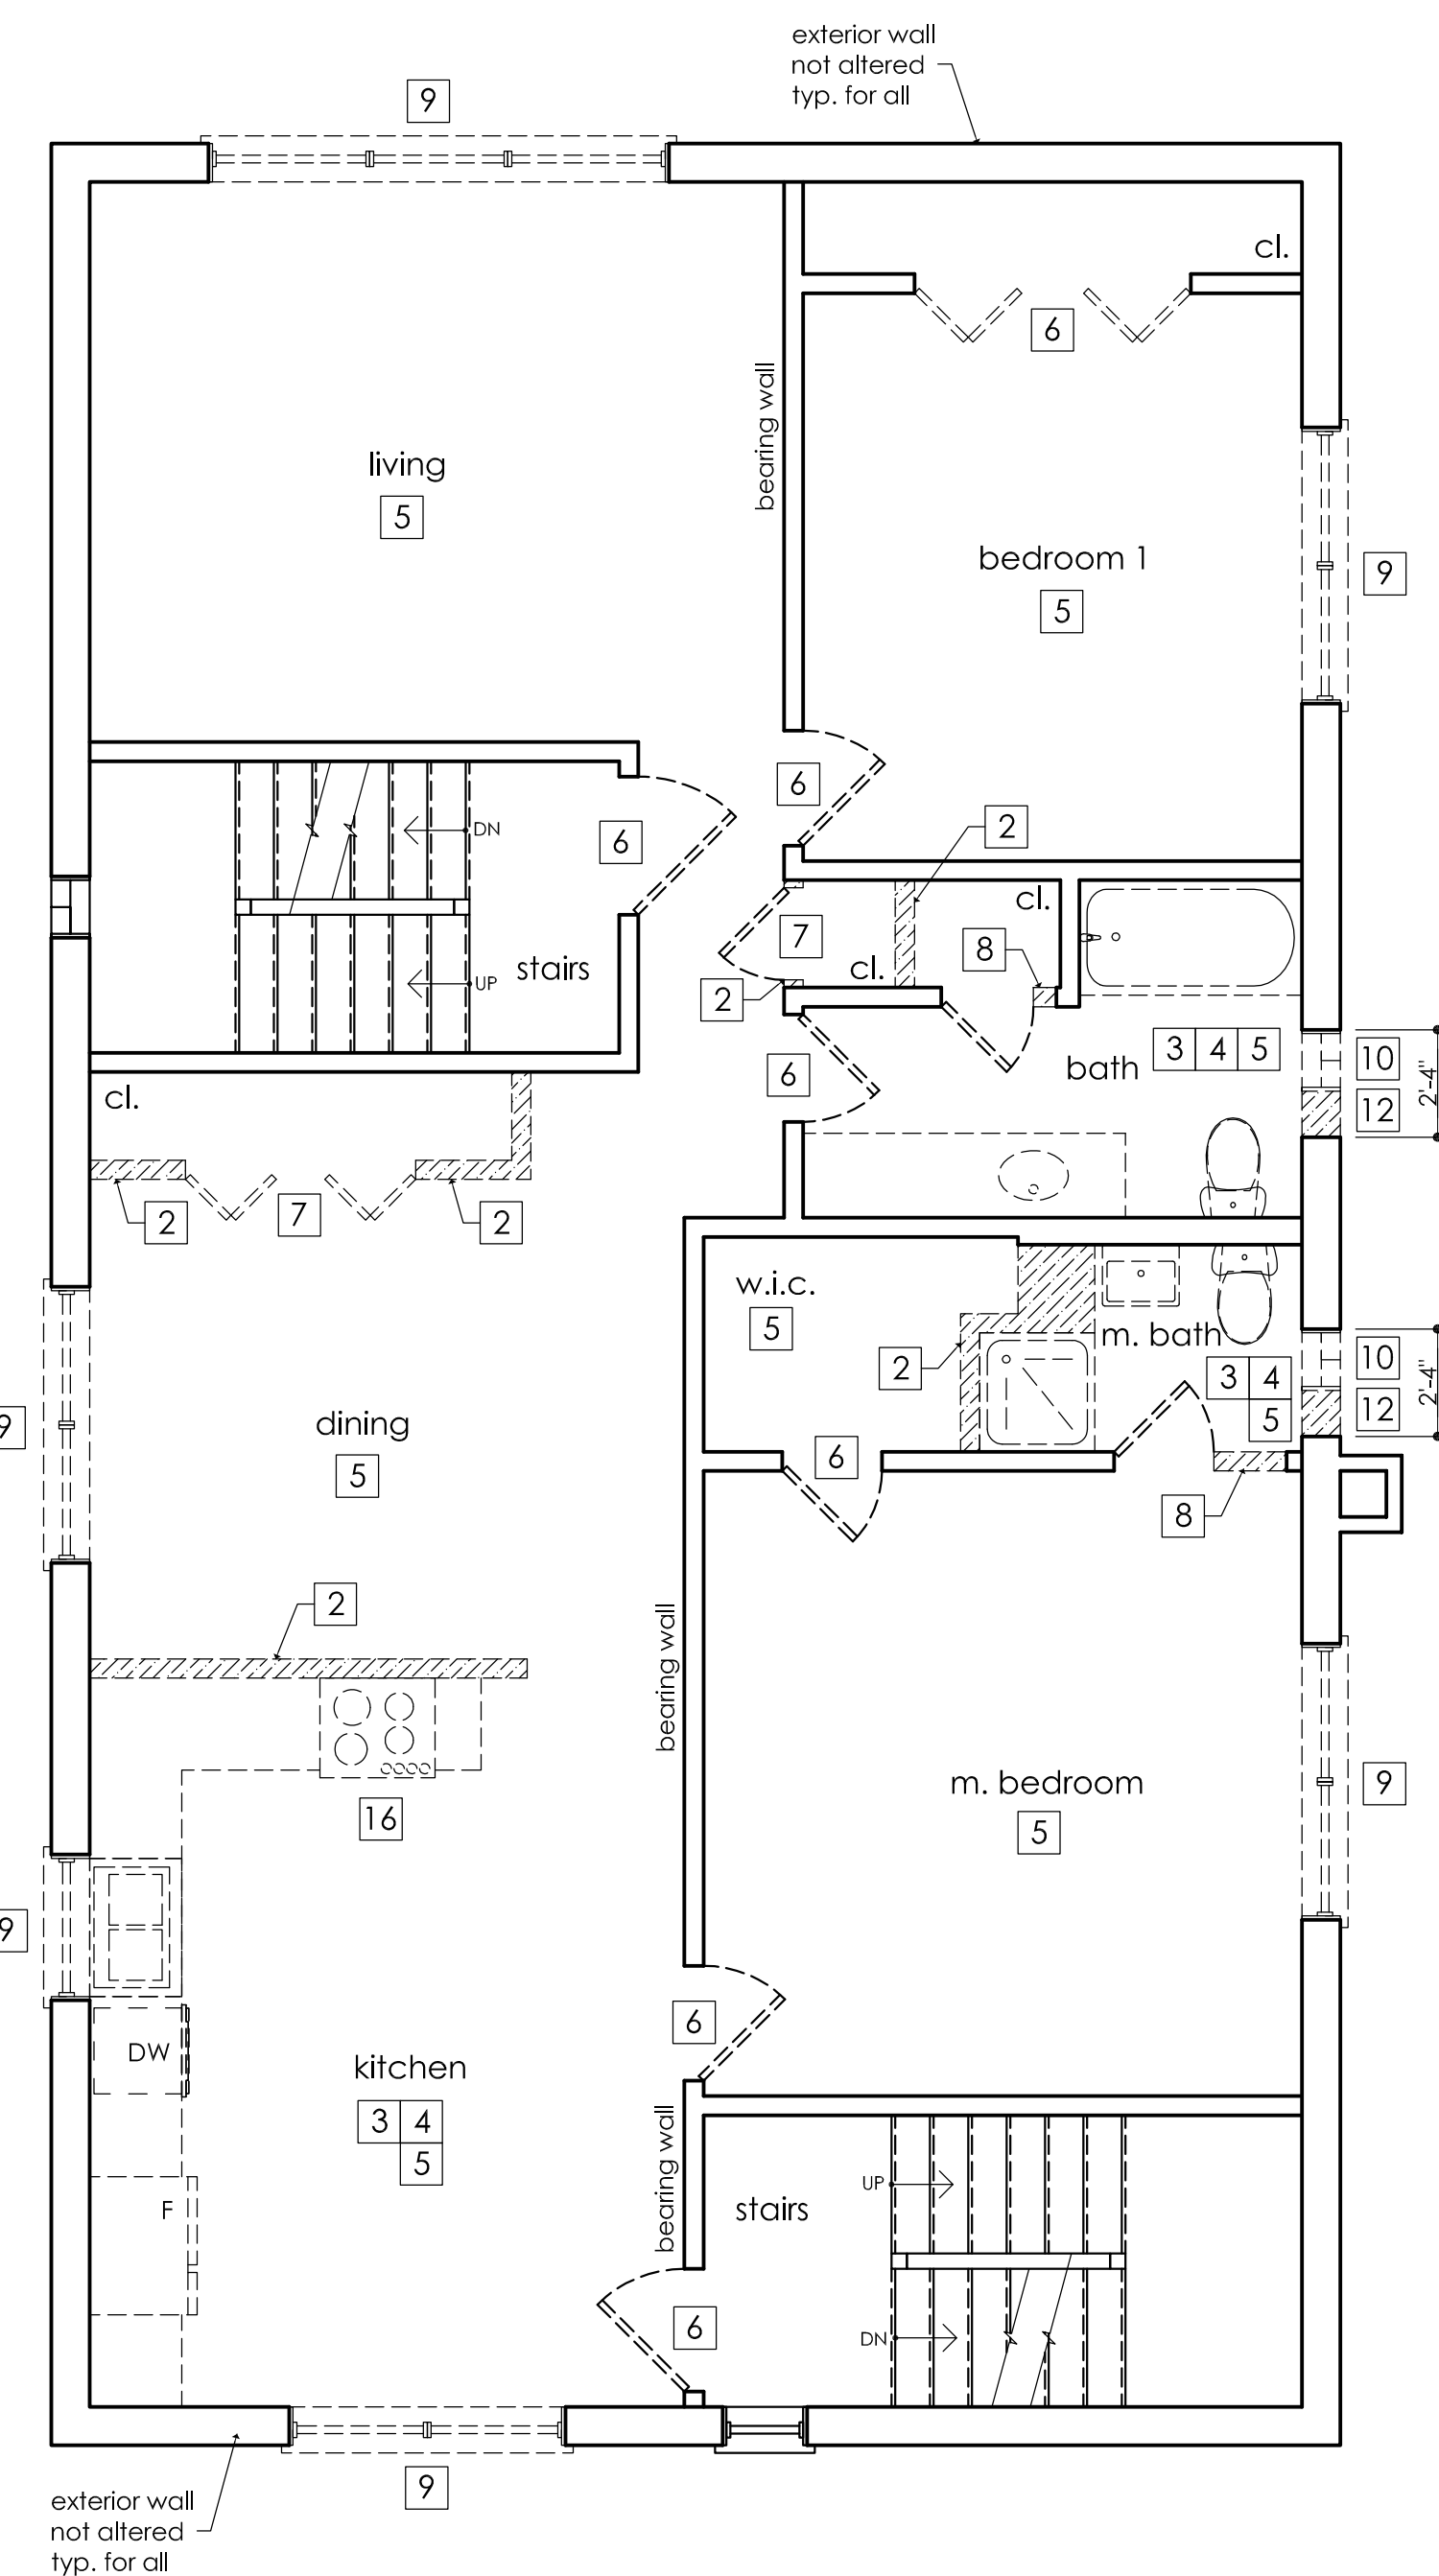

**Demo 1st Floor Plan**  
SCALE: 1/4" = 1'-0"

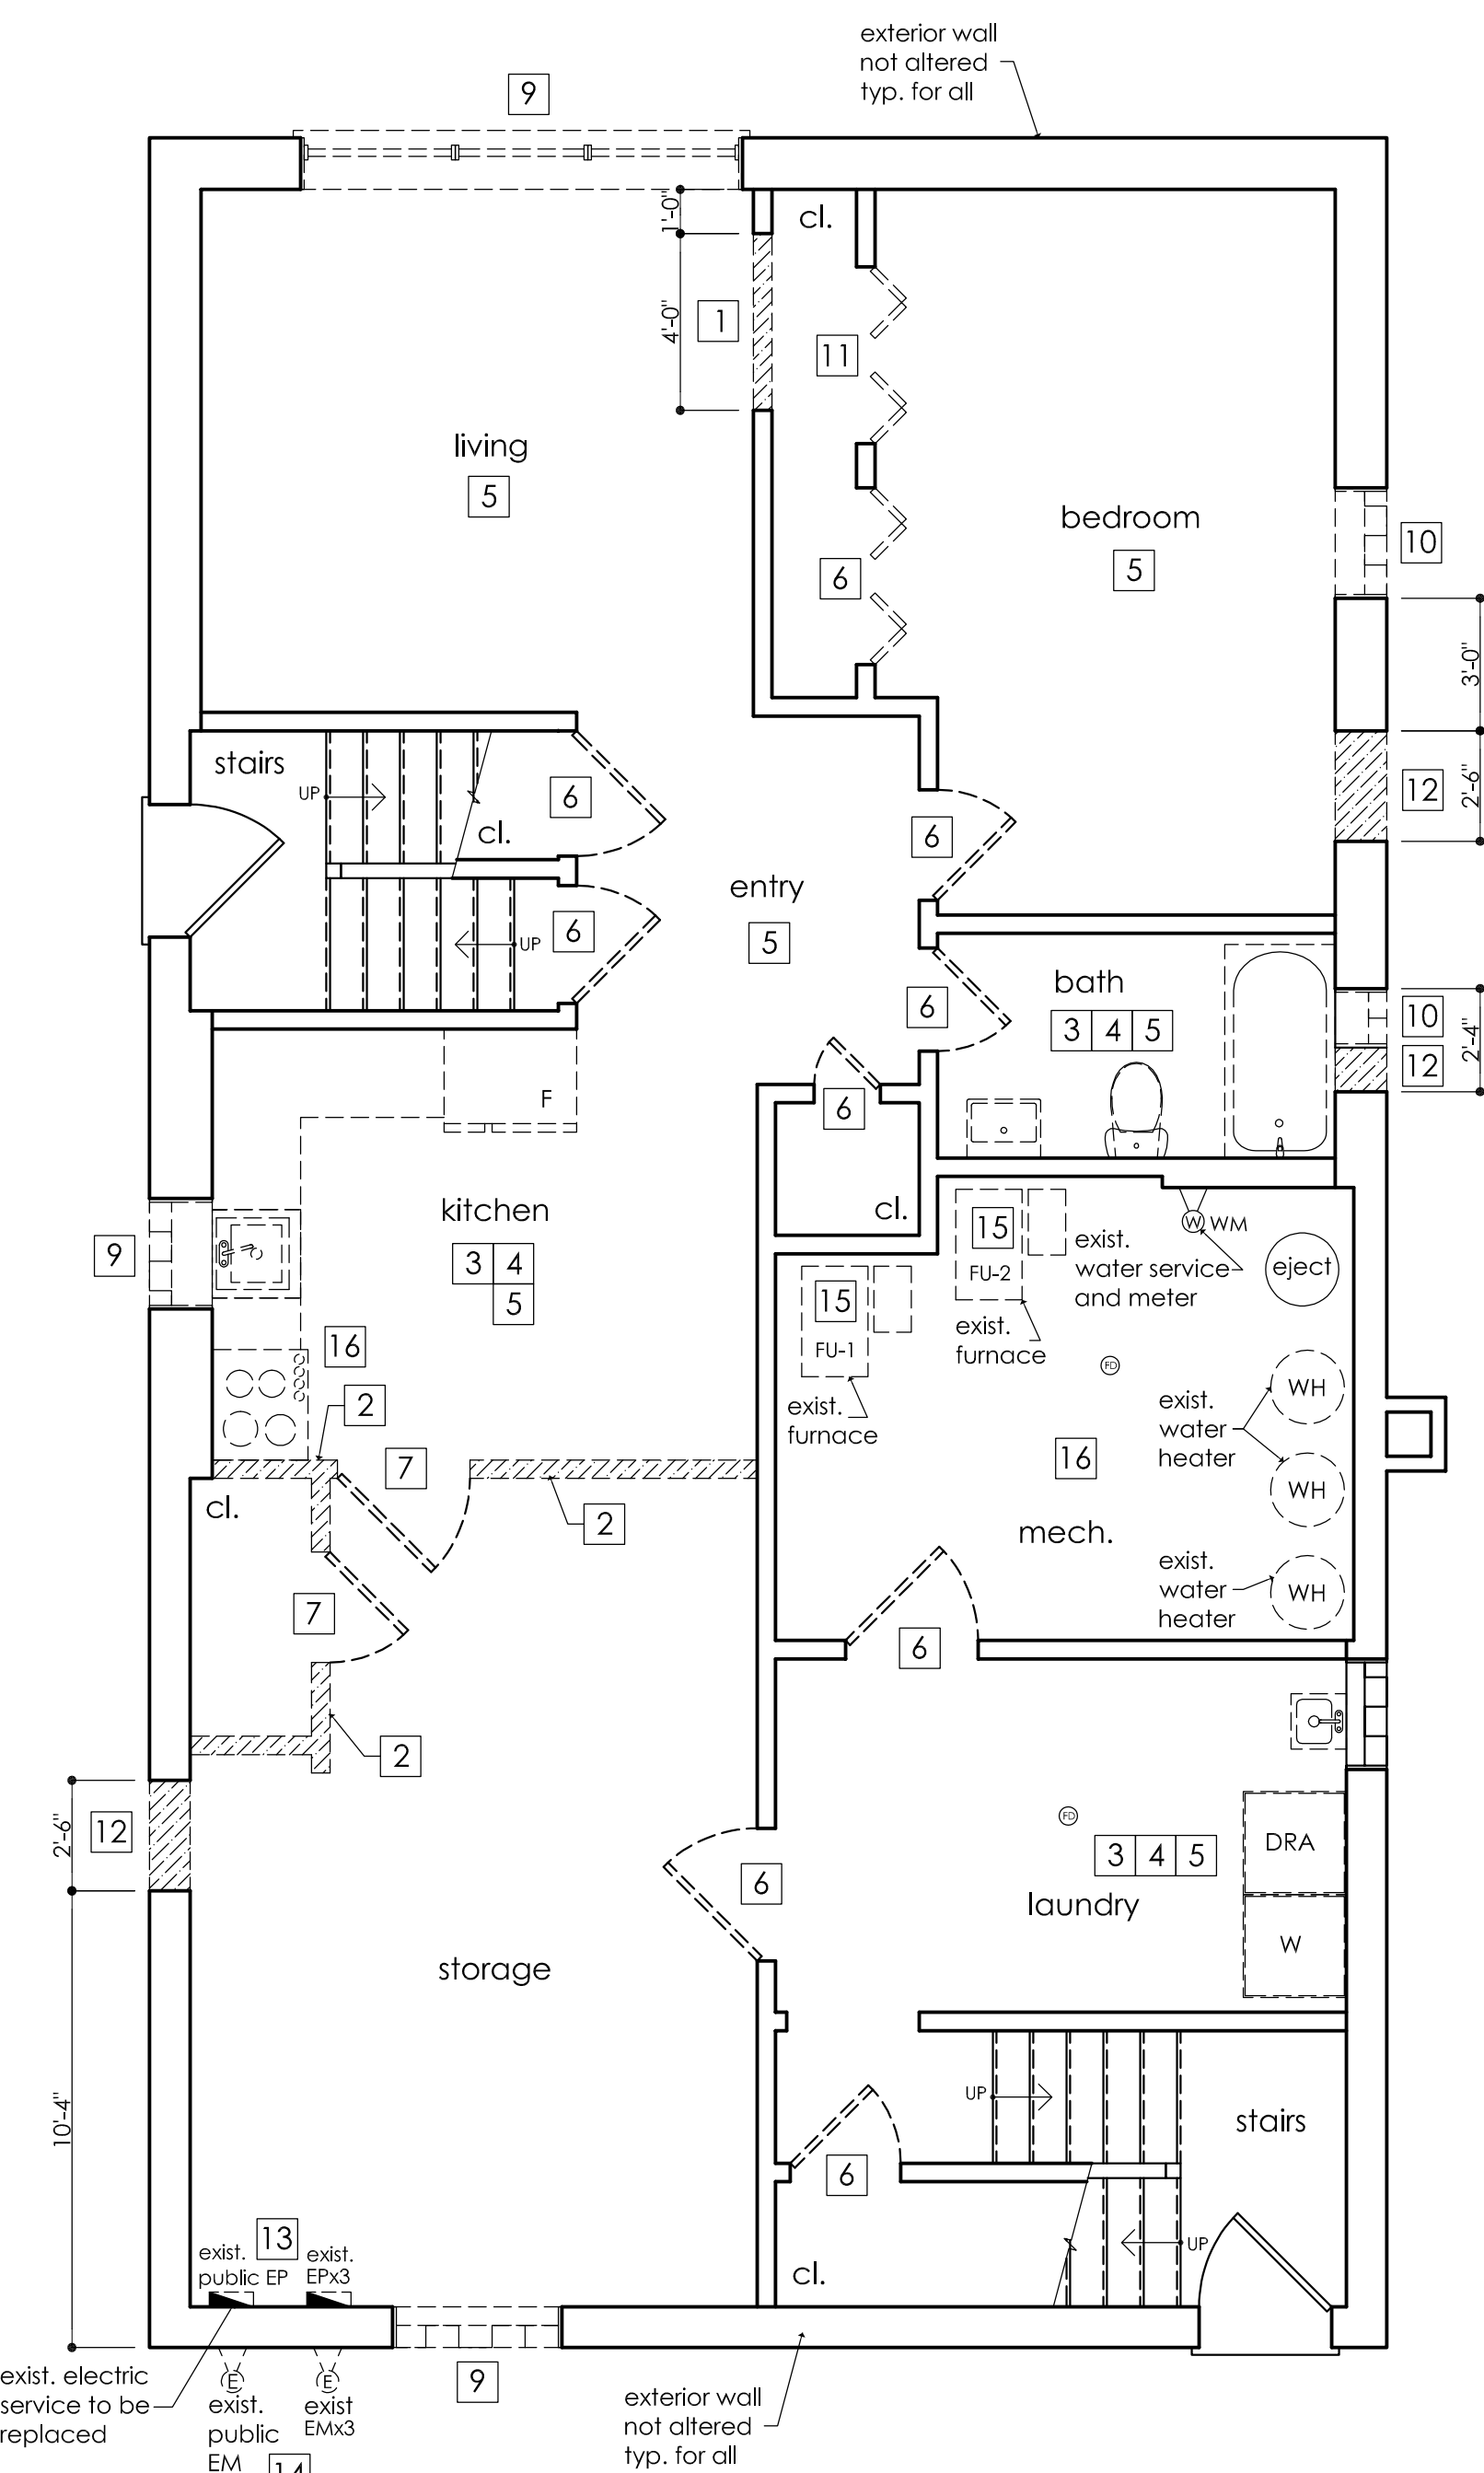

**Demo Basement Floor Plan**  
SCALE: 1/4" = 1'-0"



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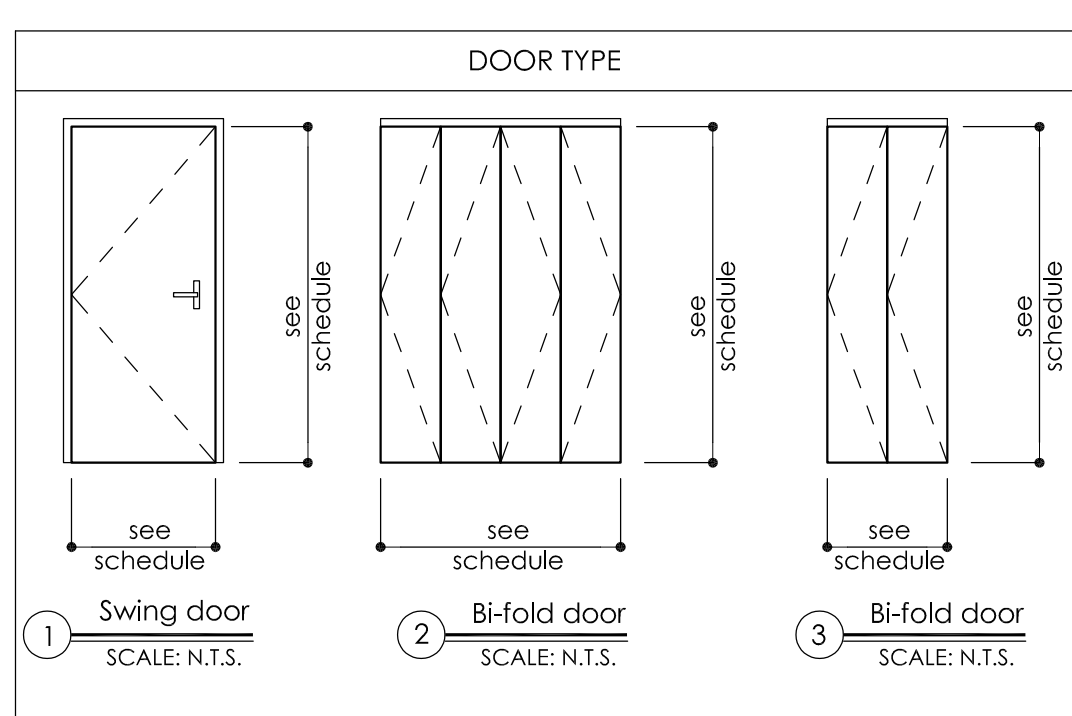
**3 UNIT BUILDING ALTERATION**  
B20 MAPLE AVE  
DAK PARK \*\*\* ILLINOIS

Project #	24-124
Date:	09/23/2024
Drawn by:	AL
Checked:	LA
Revision 1:	.
Revision 2:	.
Revision 3:	.

DOOR SCHEDULE										
DOOR TAG	TYPE	SIZE (WxHxTHK)	MAT'L	FINISH	FRAME MAT'L	FINISH	REMARKS LABEL RATING	LOCATION	TYPE	HARDWARE
BASEMENT										
001	SWING	34"x80"x1 1/2"	ML	PM	ML	PM	60 MINUTE	UNIT ENTRY	1	A,B
002	SWING	36"x80"x1 1/2"	ML	PM	ML	PM	60 MINUTE	MECH ROOM	1	A,B
003	SWING	30"x80"x1 1/2"	HC	PM	WD	PM	NOT REQUIRED	BEDROOM	1	D
004	SWING	28"x80"x1 1/2"	HC	PM	WD	PM	NOT REQUIRED	BATH	1	D
005	BH-FOLD	4x12"x80"x1 1/2"	HC	PM	WD	PM	NOT REQUIRED	CLOSET	2	E
006	SWING	34"x80"x1 1/2"	HC	PM	WD	PM	NOT REQUIRED	CLOSET	1	C
007	SWING	18"x80"x1 1/2"	HC	PM	WD	PM	NOT REQUIRED	CLOSET	1	C
008	SWING	34"x80"x1 1/2"	HC	PM	WD	PM	NOT REQUIRED	LAUNDRY	1	C
009	SWING	30"x80"x1 1/2"	HC	PM	WD	PM	NOT REQUIRED	CLOSET	1	C
FIRST FLOOR										
101	SWING	36"x80"x1 1/2"	ML	PM	ML	PM	60 MINUTE	UNIT ENTRY	1	A,B
102	SWING	32"x80"x1 1/2"	ML	PM	ML	PM	60 MINUTE	UNIT ENTRY	1	A,B
103	SWING	30"x80"x1 1/2"	HC	PM	WD	PM	NOT REQUIRED	BEDROOM	1	D
104	SWING	28"x80"x1 1/2"	HC	PM	WD	PM	NOT REQUIRED	BATH	1	D
105	BH-FOLD	4x12"x80"x1 1/2"	HC	PM	WD	PM	NOT REQUIRED	CLOSET	2	E
106	SWING	26"x80"x1 1/2"	HC	PM	WD	PM	NOT REQUIRED	CLOSET	1	C
107	SWING	24"x80"x1 1/2"	HC	PM	WD	PM	NOT REQUIRED	CLOSET	1	C
108	BH-FOLD	2x14"x80"x1 1/2"	HC	PM	WD	PM	NOT REQUIRED	LAUNDRY CL.	3	E
109	BH-FOLD	2x18"x80"x1 1/2"	SC	PM	WD	PM	NOT REQUIRED	MECH CL.	3	E
110	BH-FOLD	4x18"x80"x1 1/2"	HC	PM	WD	PM	NOT REQUIRED	CLOSET	2	E
SECOND FLOOR										
201	SWING	36"x80"x1 1/2"	ML	PM	ML	PM	60 MINUTE	UNIT ENTRY	1	A,B
202	SWING	32"x80"x1 1/2"	ML	PM	ML	PM	60 MINUTE	UNIT ENTRY	1	A,B
203	SWING	30"x80"x1 1/2"	HC	PM	WD	PM	NOT REQUIRED	BEDROOM	1	D
204	SWING	28"x80"x1 1/2"	HC	PM	WD	PM	NOT REQUIRED	BATH	1	D
205	BH-FOLD	4x12"x80"x1 1/2"	HC	PM	WD	PM	NOT REQUIRED	CLOSET	2	E
206	SWING	26"x80"x1 1/2"	HC	PM	WD	PM	NOT REQUIRED	CLOSET	1	C
207	SWING	24"x80"x1 1/2"	HC	PM	WD	PM	NOT REQUIRED	CLOSET	1	C
208	BH-FOLD	2x14"x80"x1 1/2"	HC	PM	WD	PM	NOT REQUIRED	LAUNDRY CL.	3	E
209	BH-FOLD	4x18"x80"x1 1/2"	HC	PM	WD	PM	NOT REQUIRED	CLOSET	2	E

HC - hollow core  
PM - primed  
VL - vinyl  
WD - wood  
GL - glass  
ML - metal  
AL - aluminum

DOOR HARDWARE SCHEDULE	
A	Keyed deadbolt
B	Door lever
C	Door lever with ball catch
D	Door lever with privacy lock
E	Bi-fold pulls and track hardware
F	Door pulls and sliding track hardware




NEW WINDOW SCHEDULE						
tag #	window type	rough opening width	rough opening height	quant.	light (sf)	vent (ft)
1	d. hung/casement	10'-0"	2'-10"	1	25.47	12.74
2	d. hung/casement	2'-6"	3'-0"	1	6.75	3.38
3	d. hung/casement	2'-6"	3'-0"	1	6.75	6.75
4	d. hung/casement	2'-4"	2'-6"	1	5.24	2.62
5	d. hung/casement	3'-10"	3'-0"	1	10.34	10.34
6	d. hung/casement	2'-6"	2'-6"	2	5.63	2.81
7	d. hung/casement	6'-0"	3'-2"	8	17.1	8.6
8	d. hung/casement	10'-0"	4'-2"	2	37.53	18.77
9	d. hung/casement	2'-4"	4'-0"	4	8.39	4.19
10	d. hung/casement	3'-2"	2'-8"	2	7.61	3.8

Note:  
-All glass in hazardous location to be safety glass  
-All new windows shall have a max. U-factor of 0.30


Note:  
-Provide 5/8" durock cement board at all new wet walls, and 5/8" type "X" gyp. board at new walls  
-Provide 5/8" type "X" gyp. board at ceiling in basement

Note for egress window:  
-Verify min. 5.7sf. clear open area w/ min. clear height of 24" & width of 20". The sill shall be max. of 44" above floor.


Attic notes:  
-Attic accesses are required to areas exceeding thirty square feet (30 sq.ft.) and which have a vertical height of thirty inches (30") or greater. (Section: R807)  
-Attic access required and shall be unobstructed twenty-two inches by thirty inches (22" x 30"). (Sections: R807)

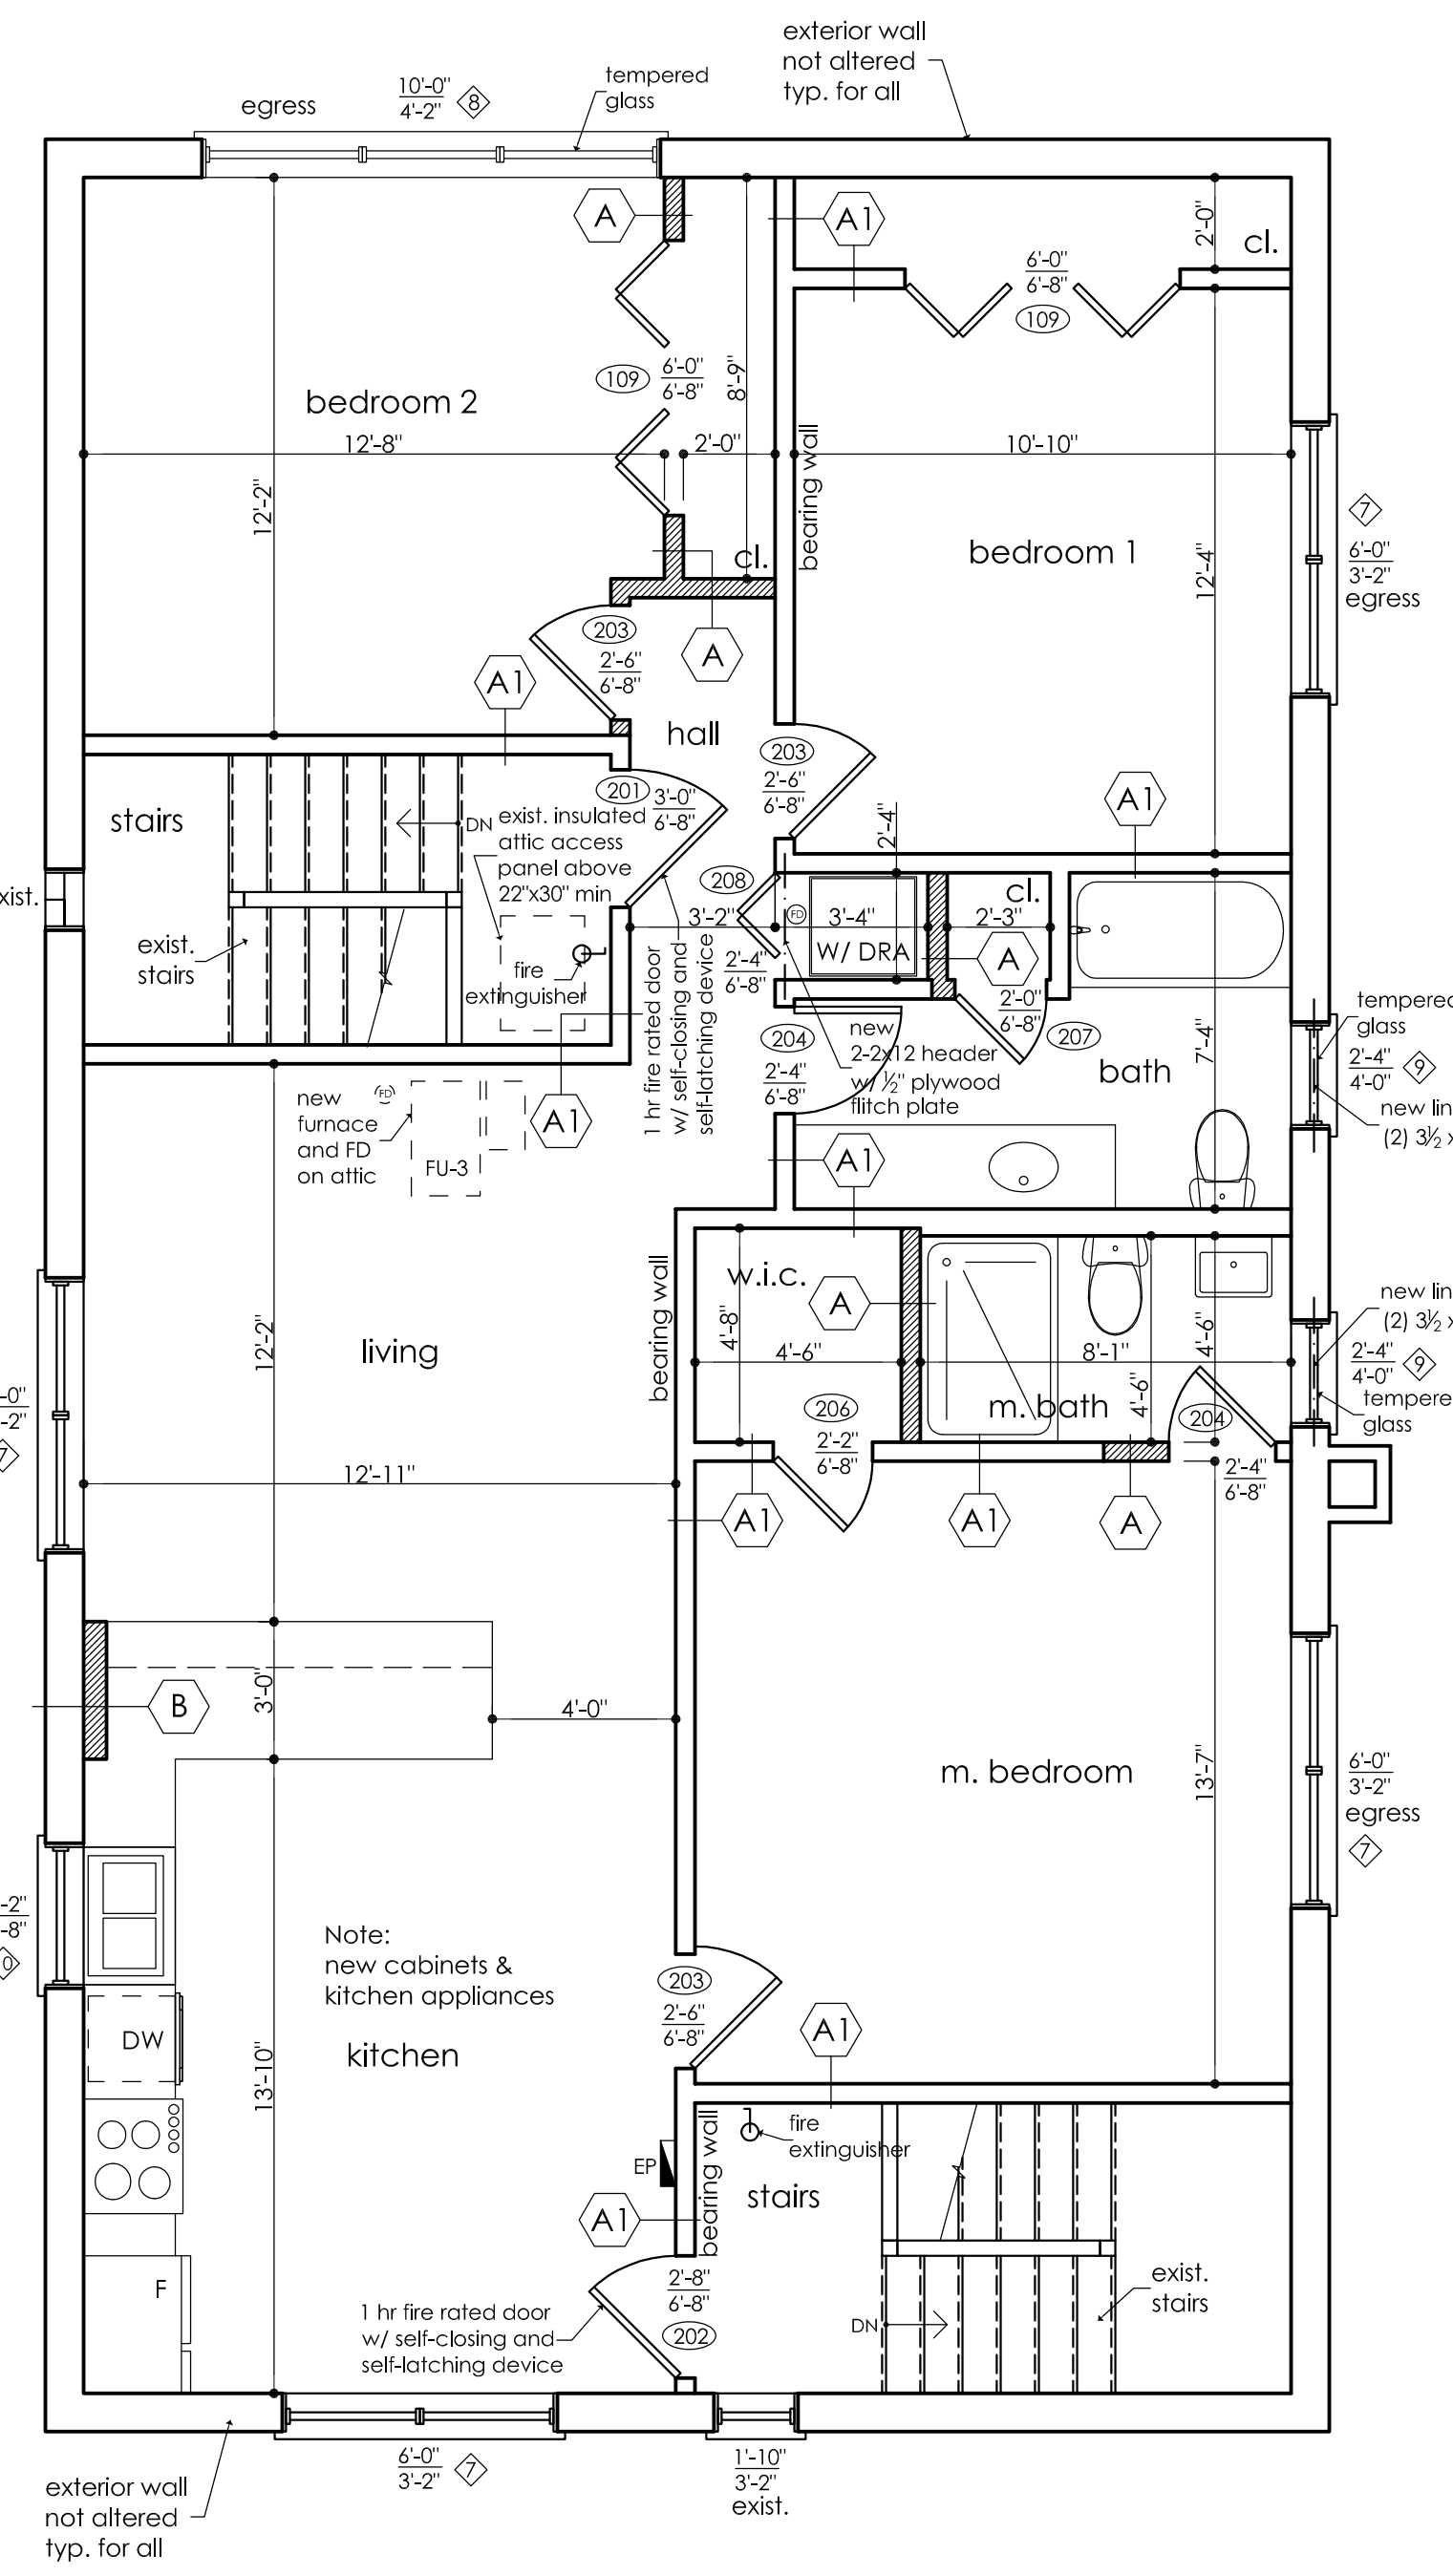



2nd Floor Plan  
SCALE: 1/4" = 1'-0"

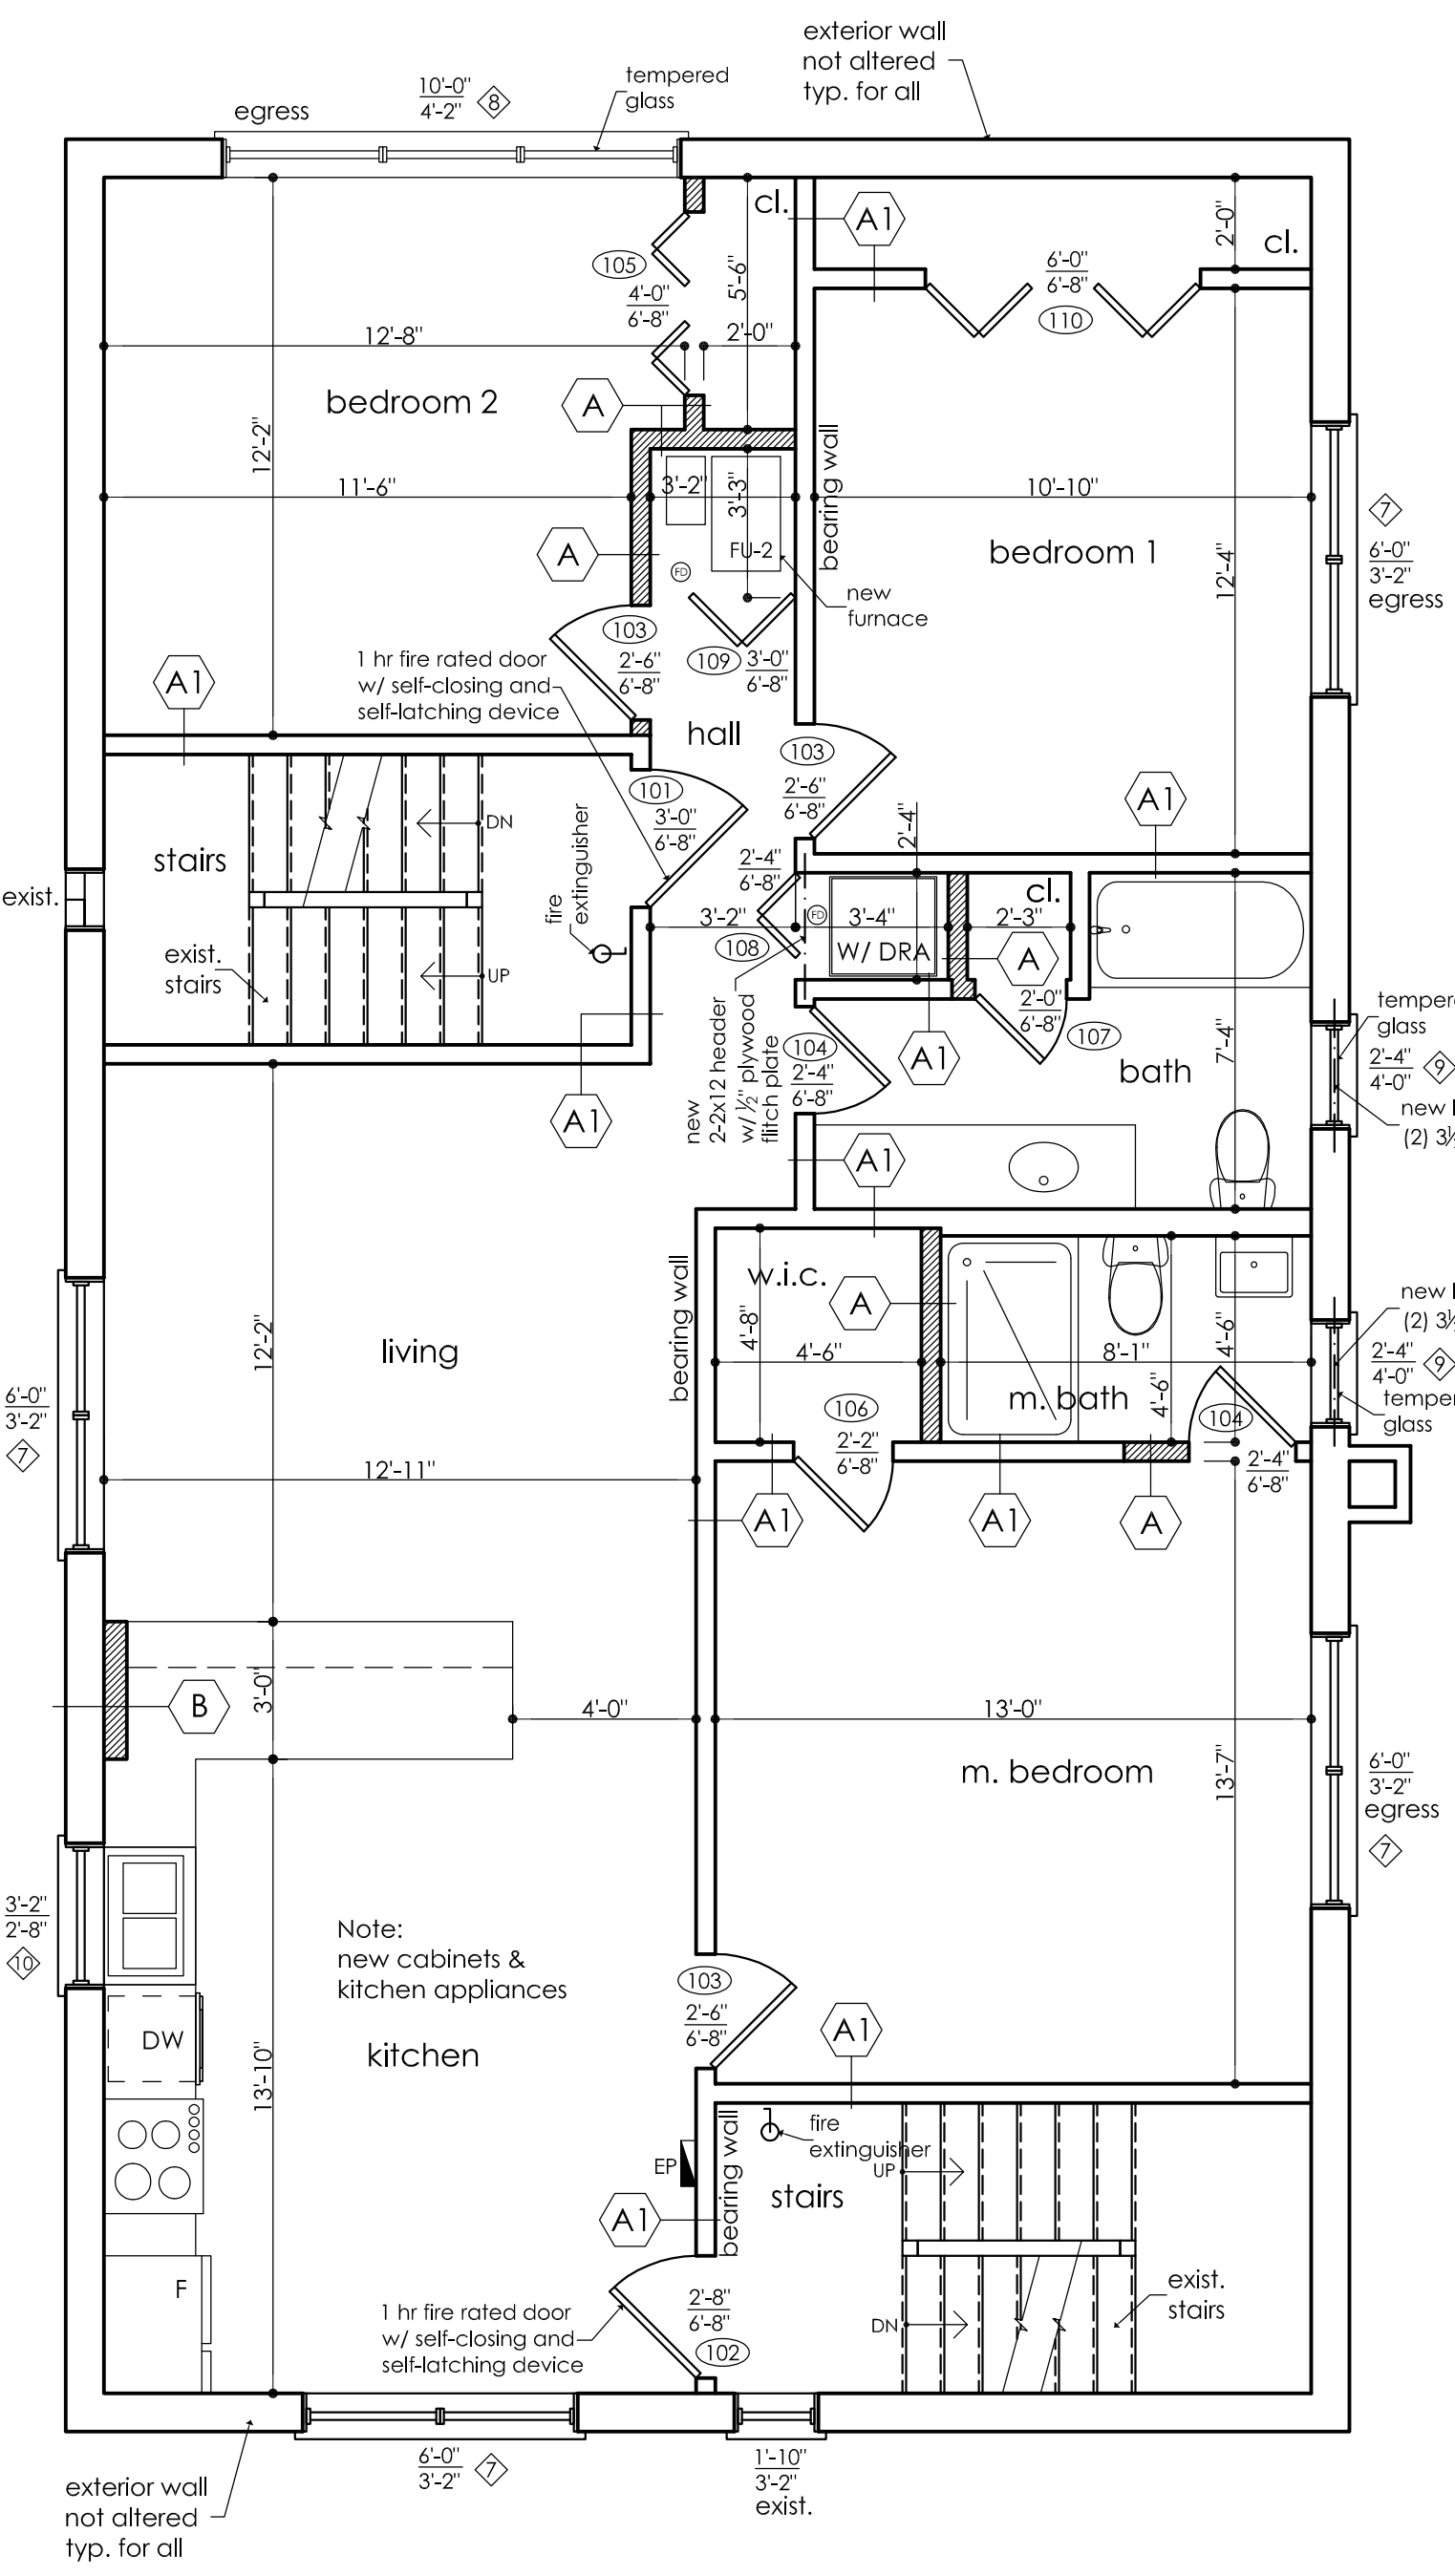

1st Floor Plan  
SCALE: 1/4" = 1'-0"

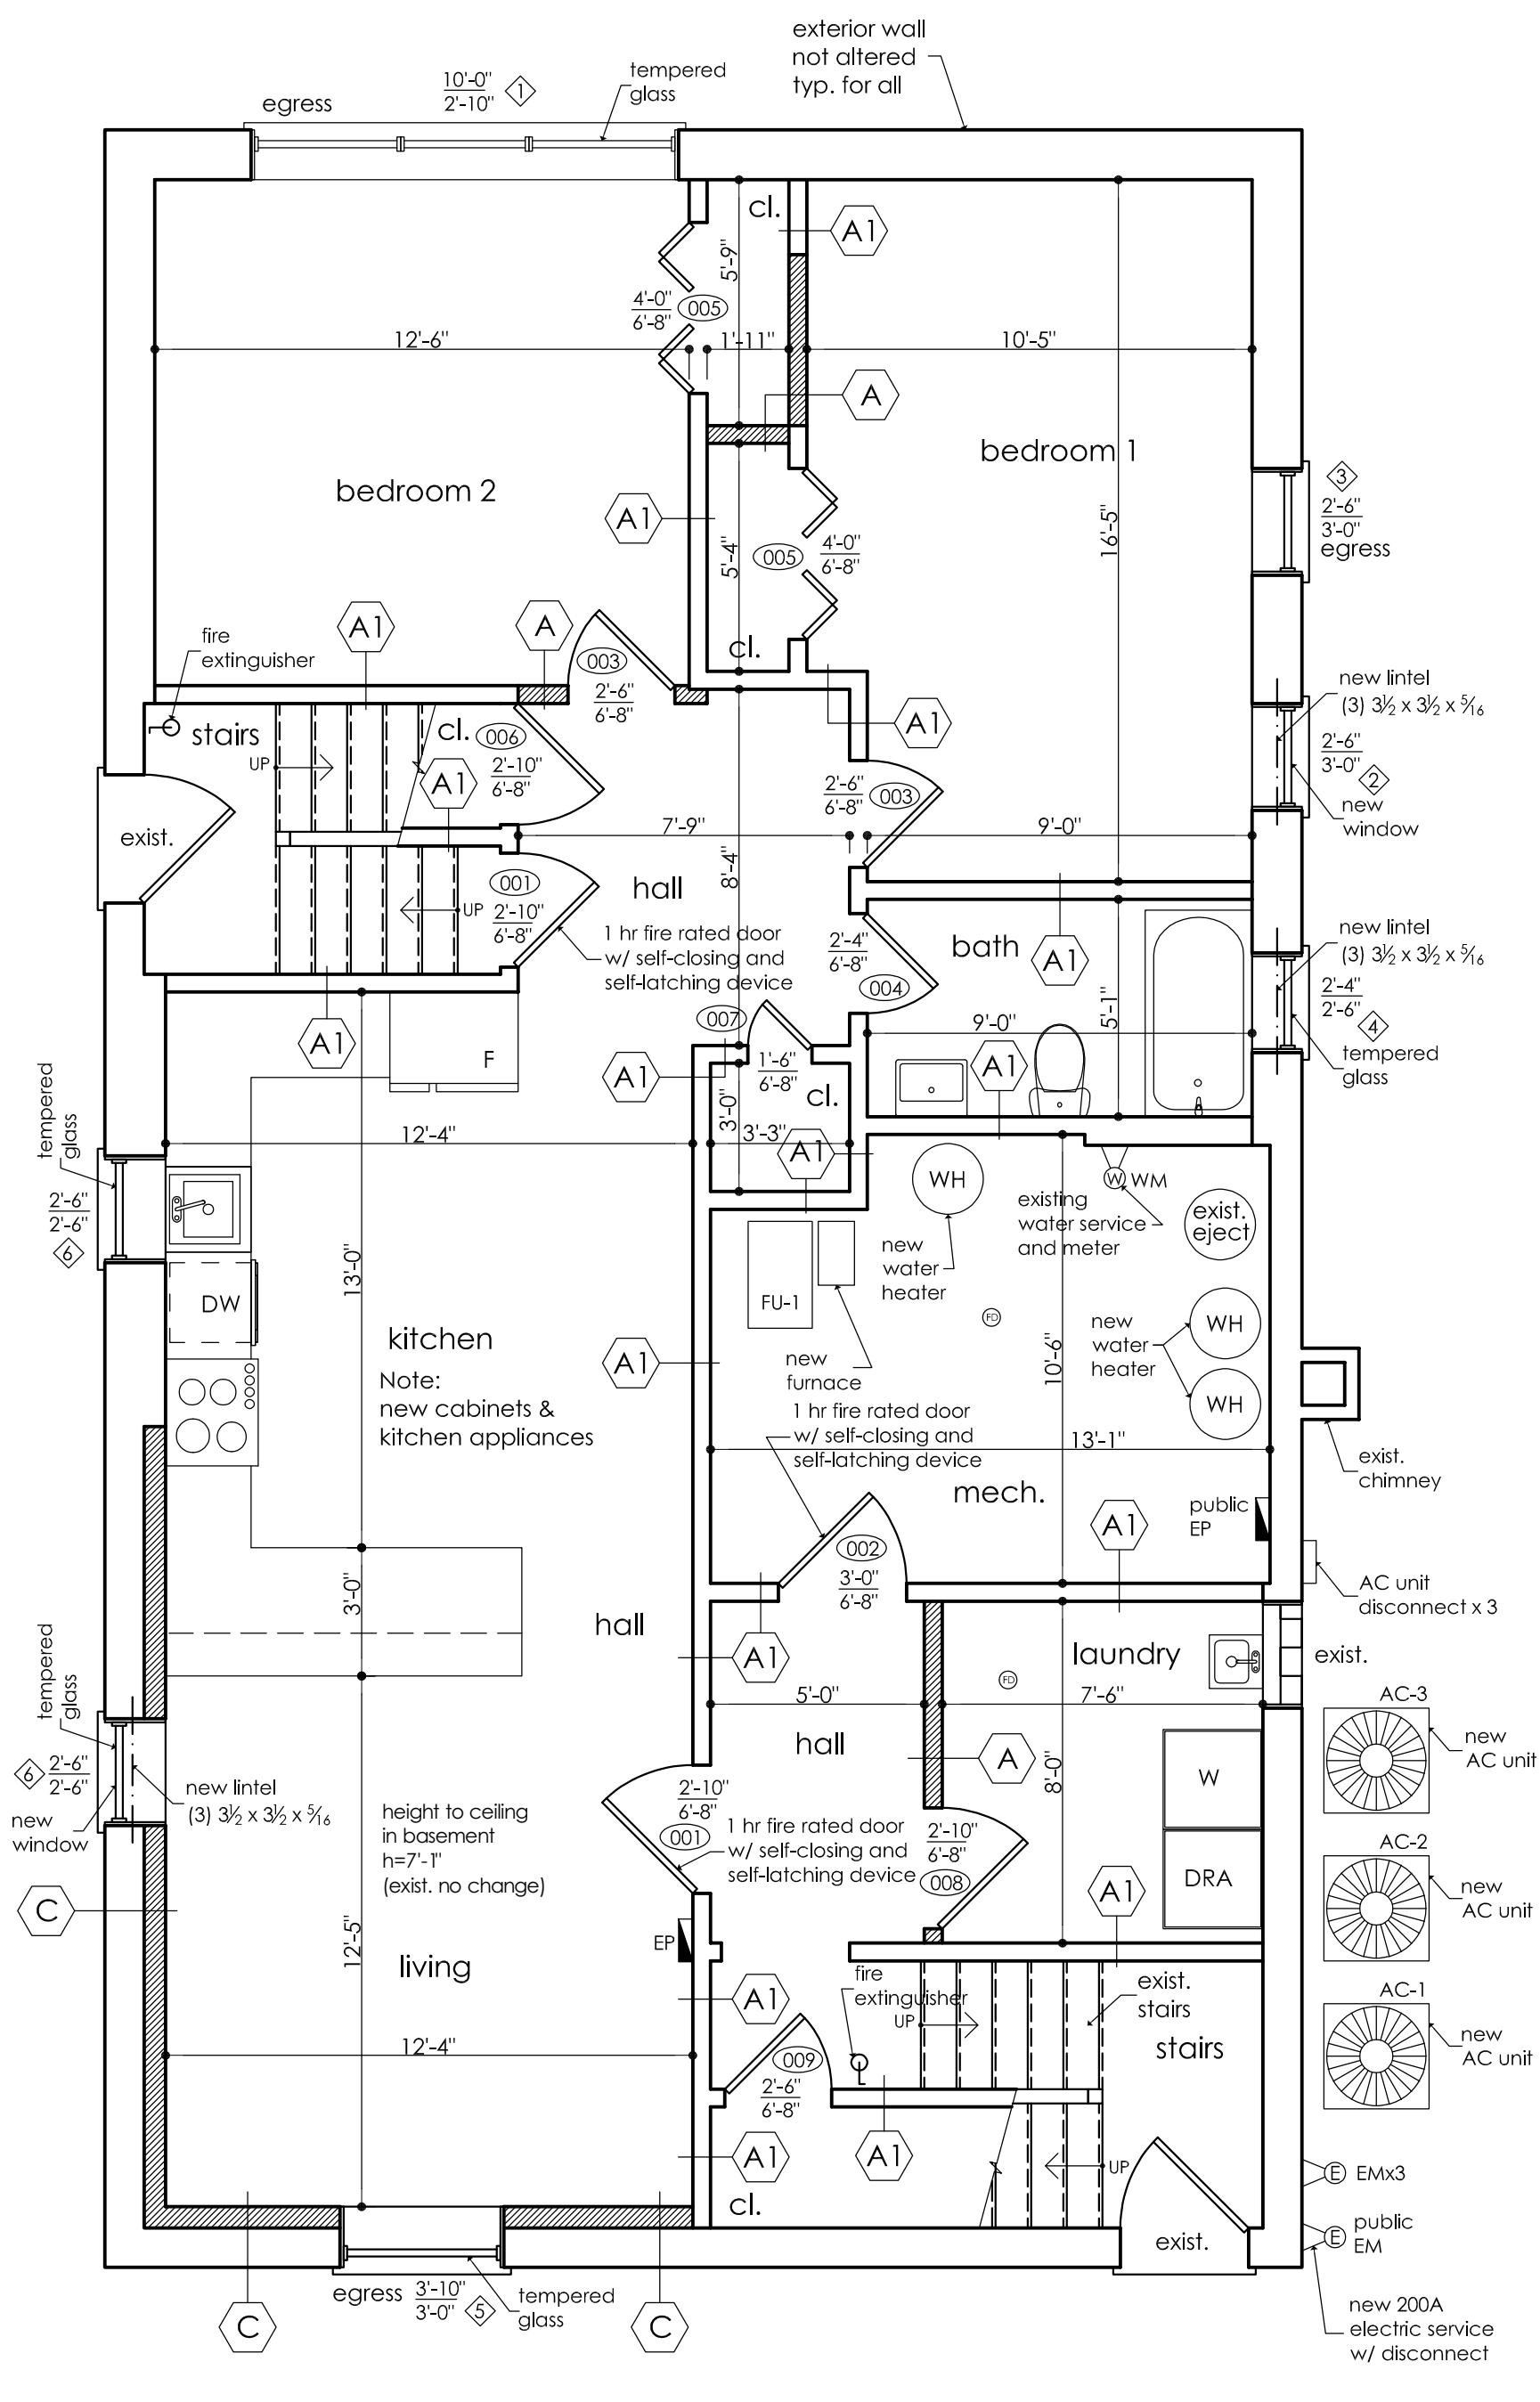

Basement Floor Plan  
SCALE: 1/4" = 1'-0"

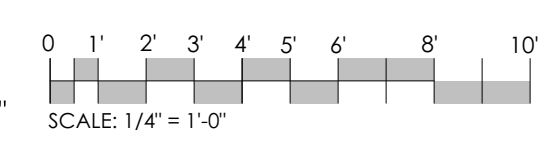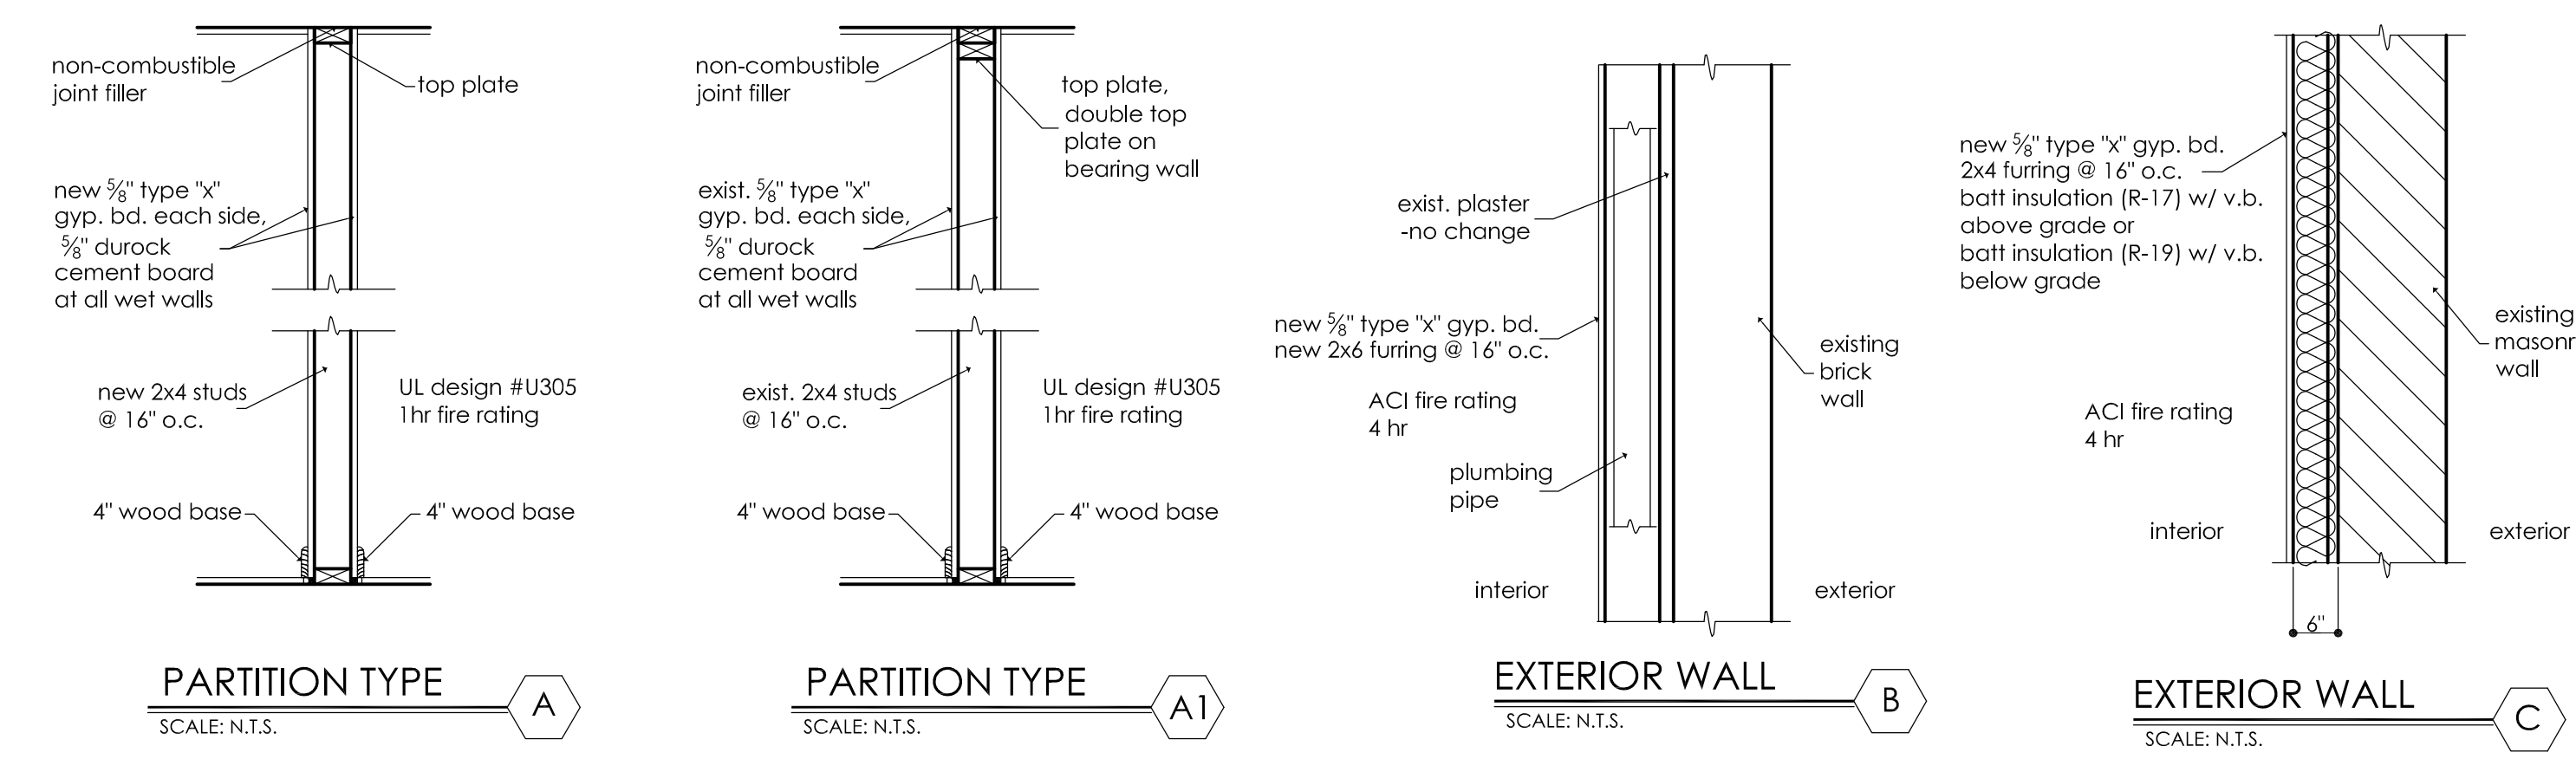

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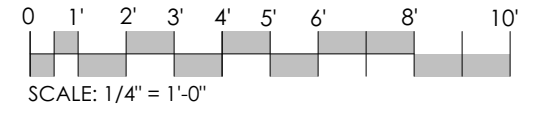
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ARCHITECT  
09.23.2024  
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**3 UNIT BUILDING ALTERATION**  
B20 MAPLE AVE  
DAK PARK \*\*\* ILLINOIS

Project # 24-124  
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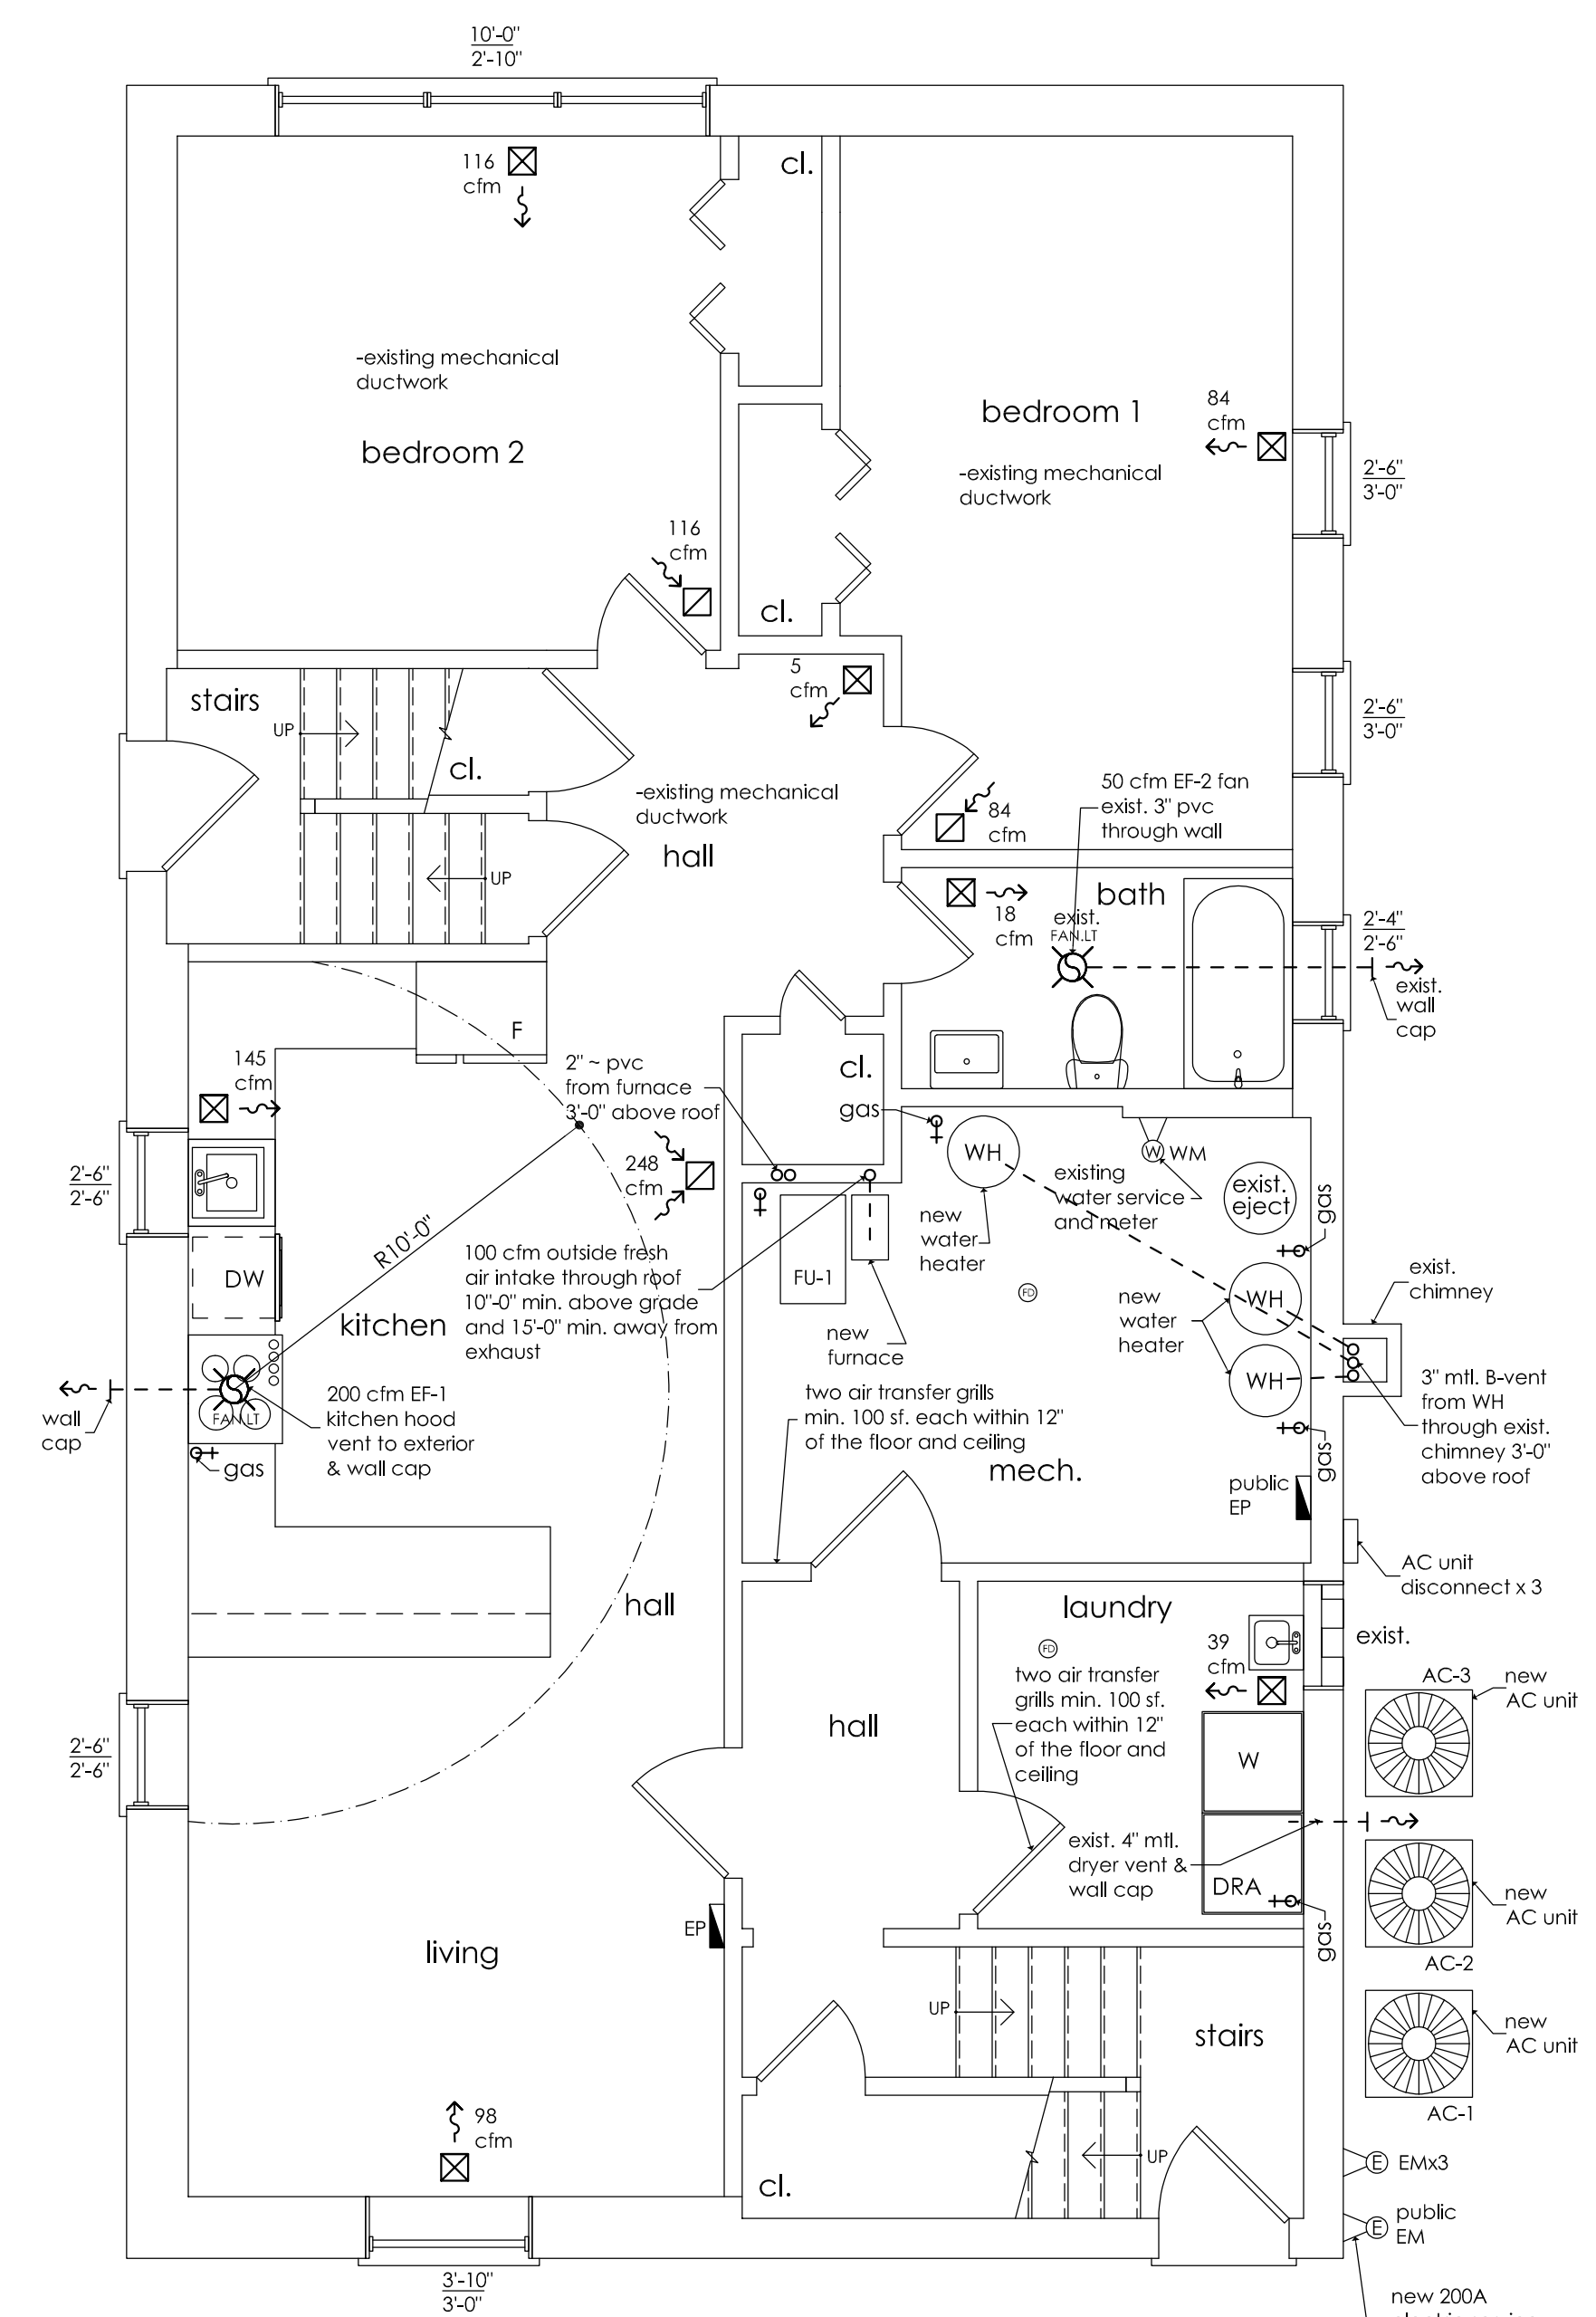
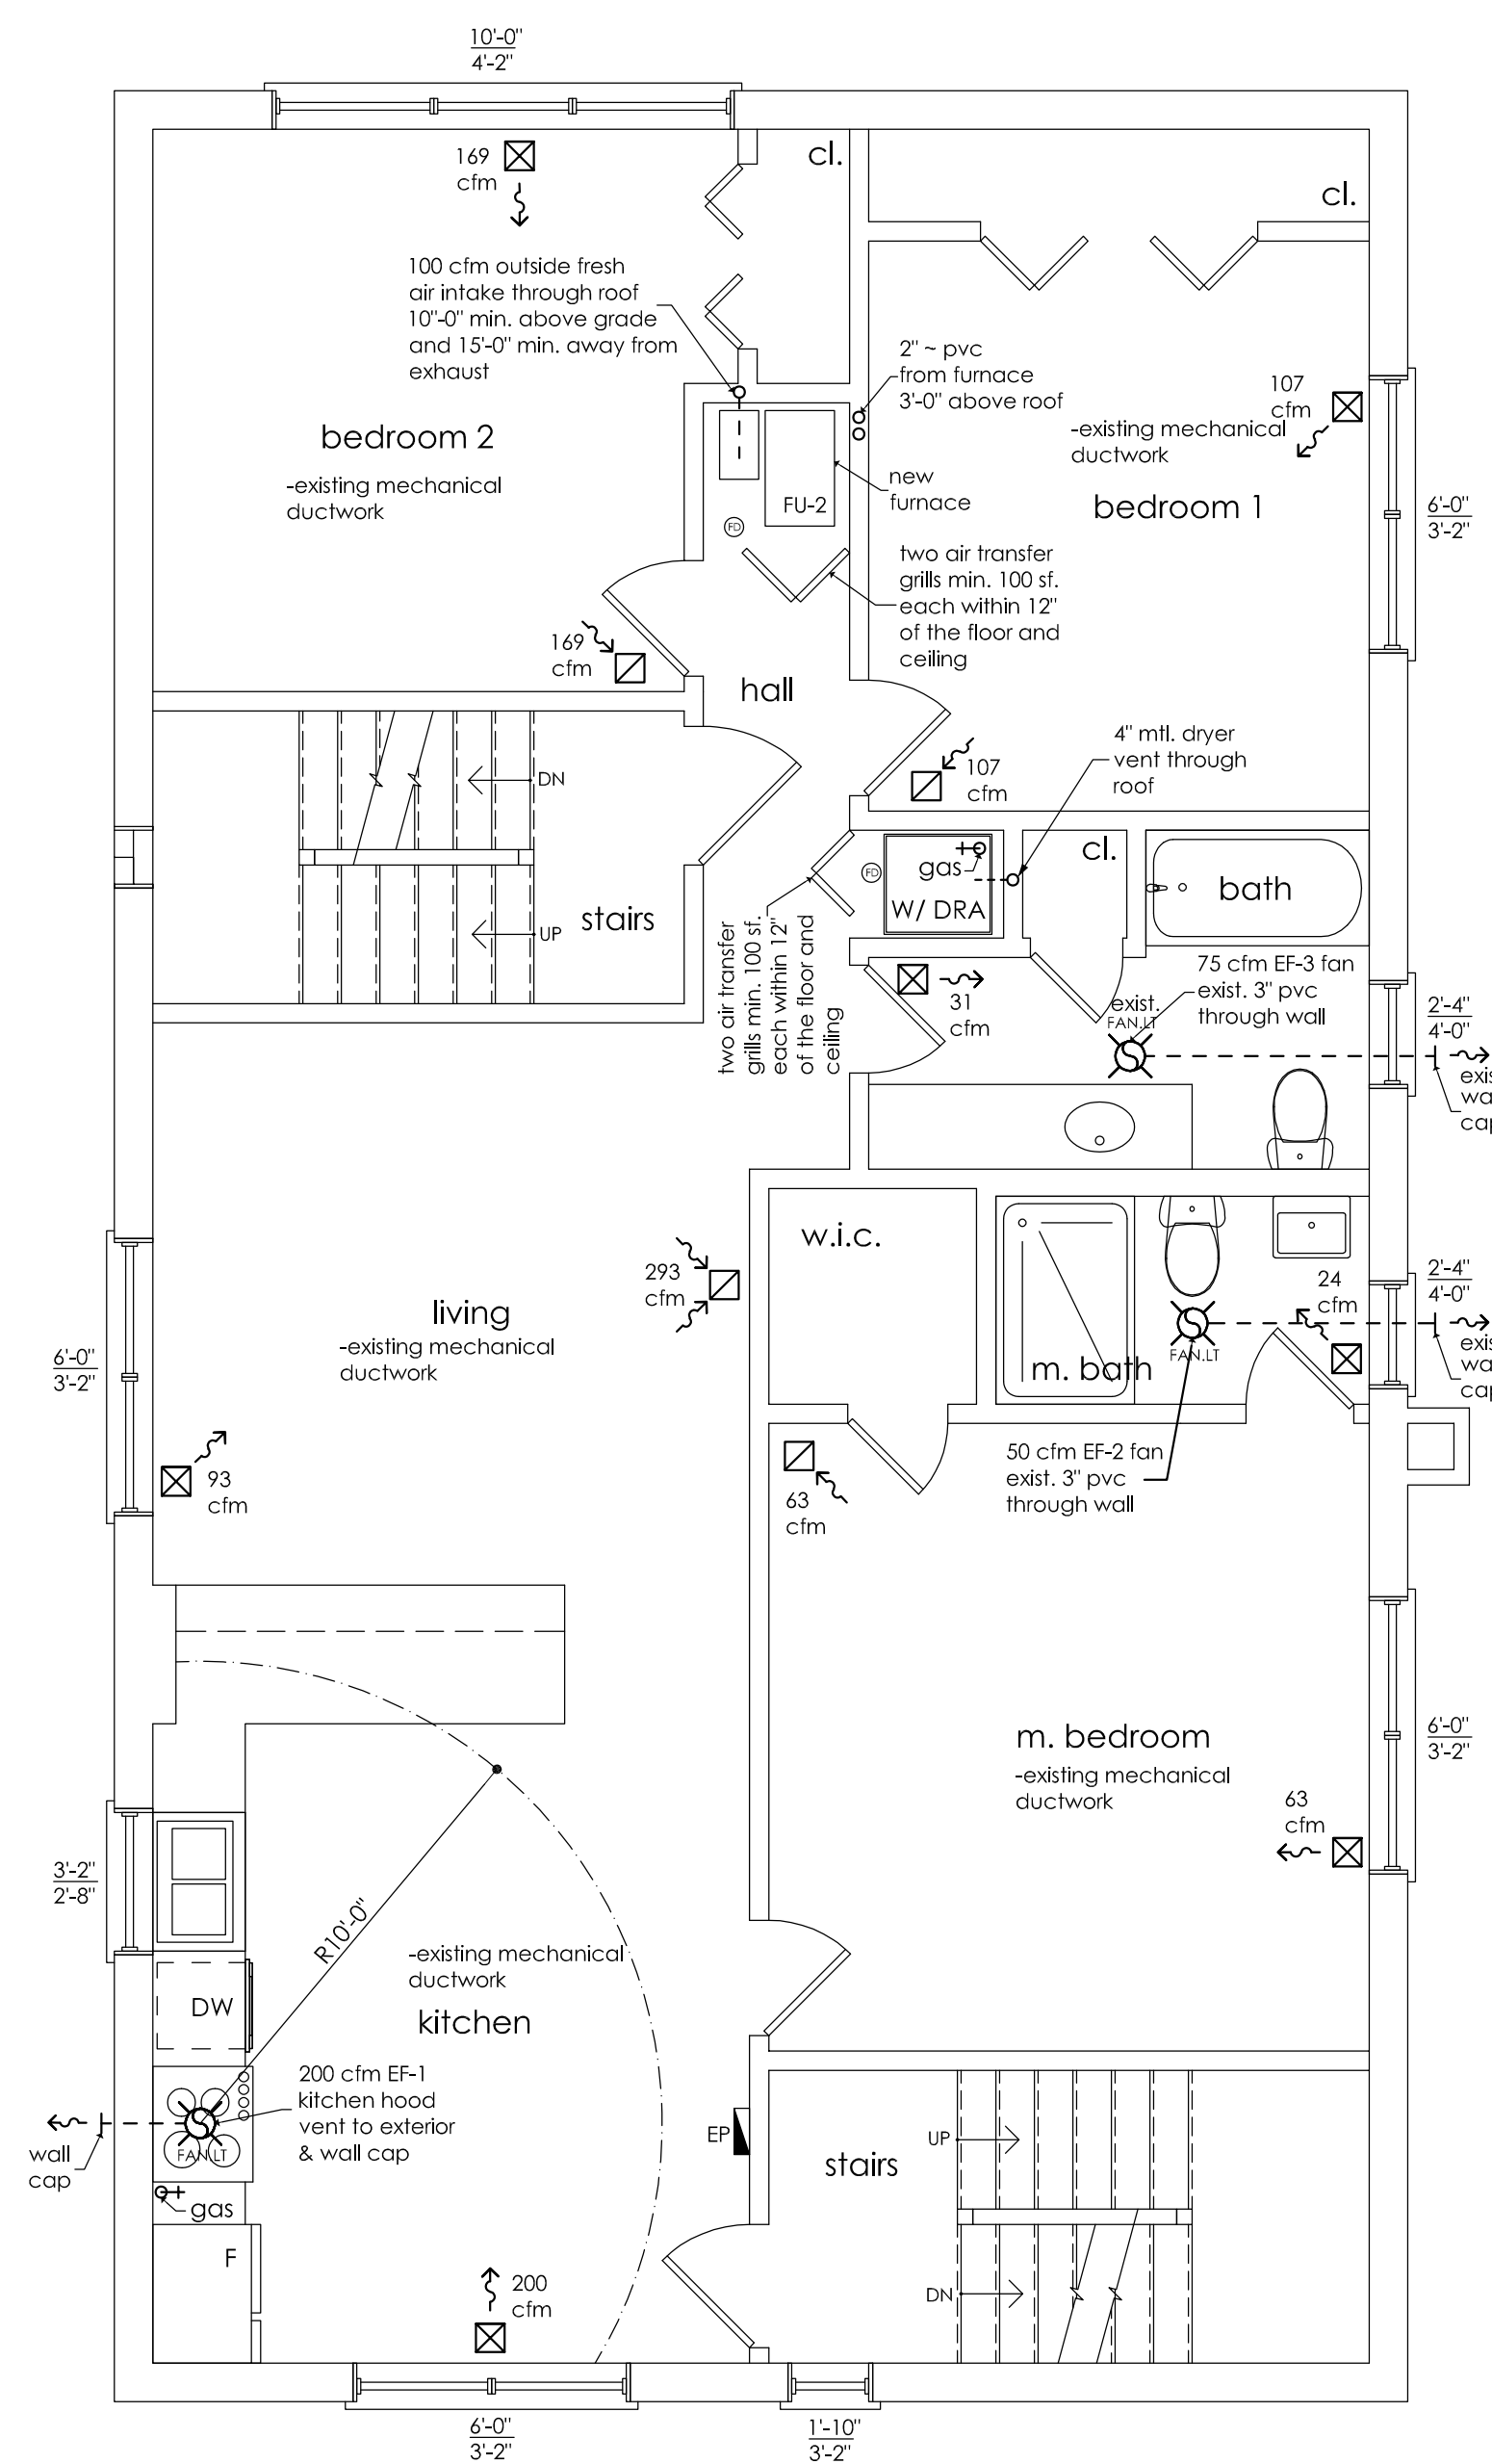
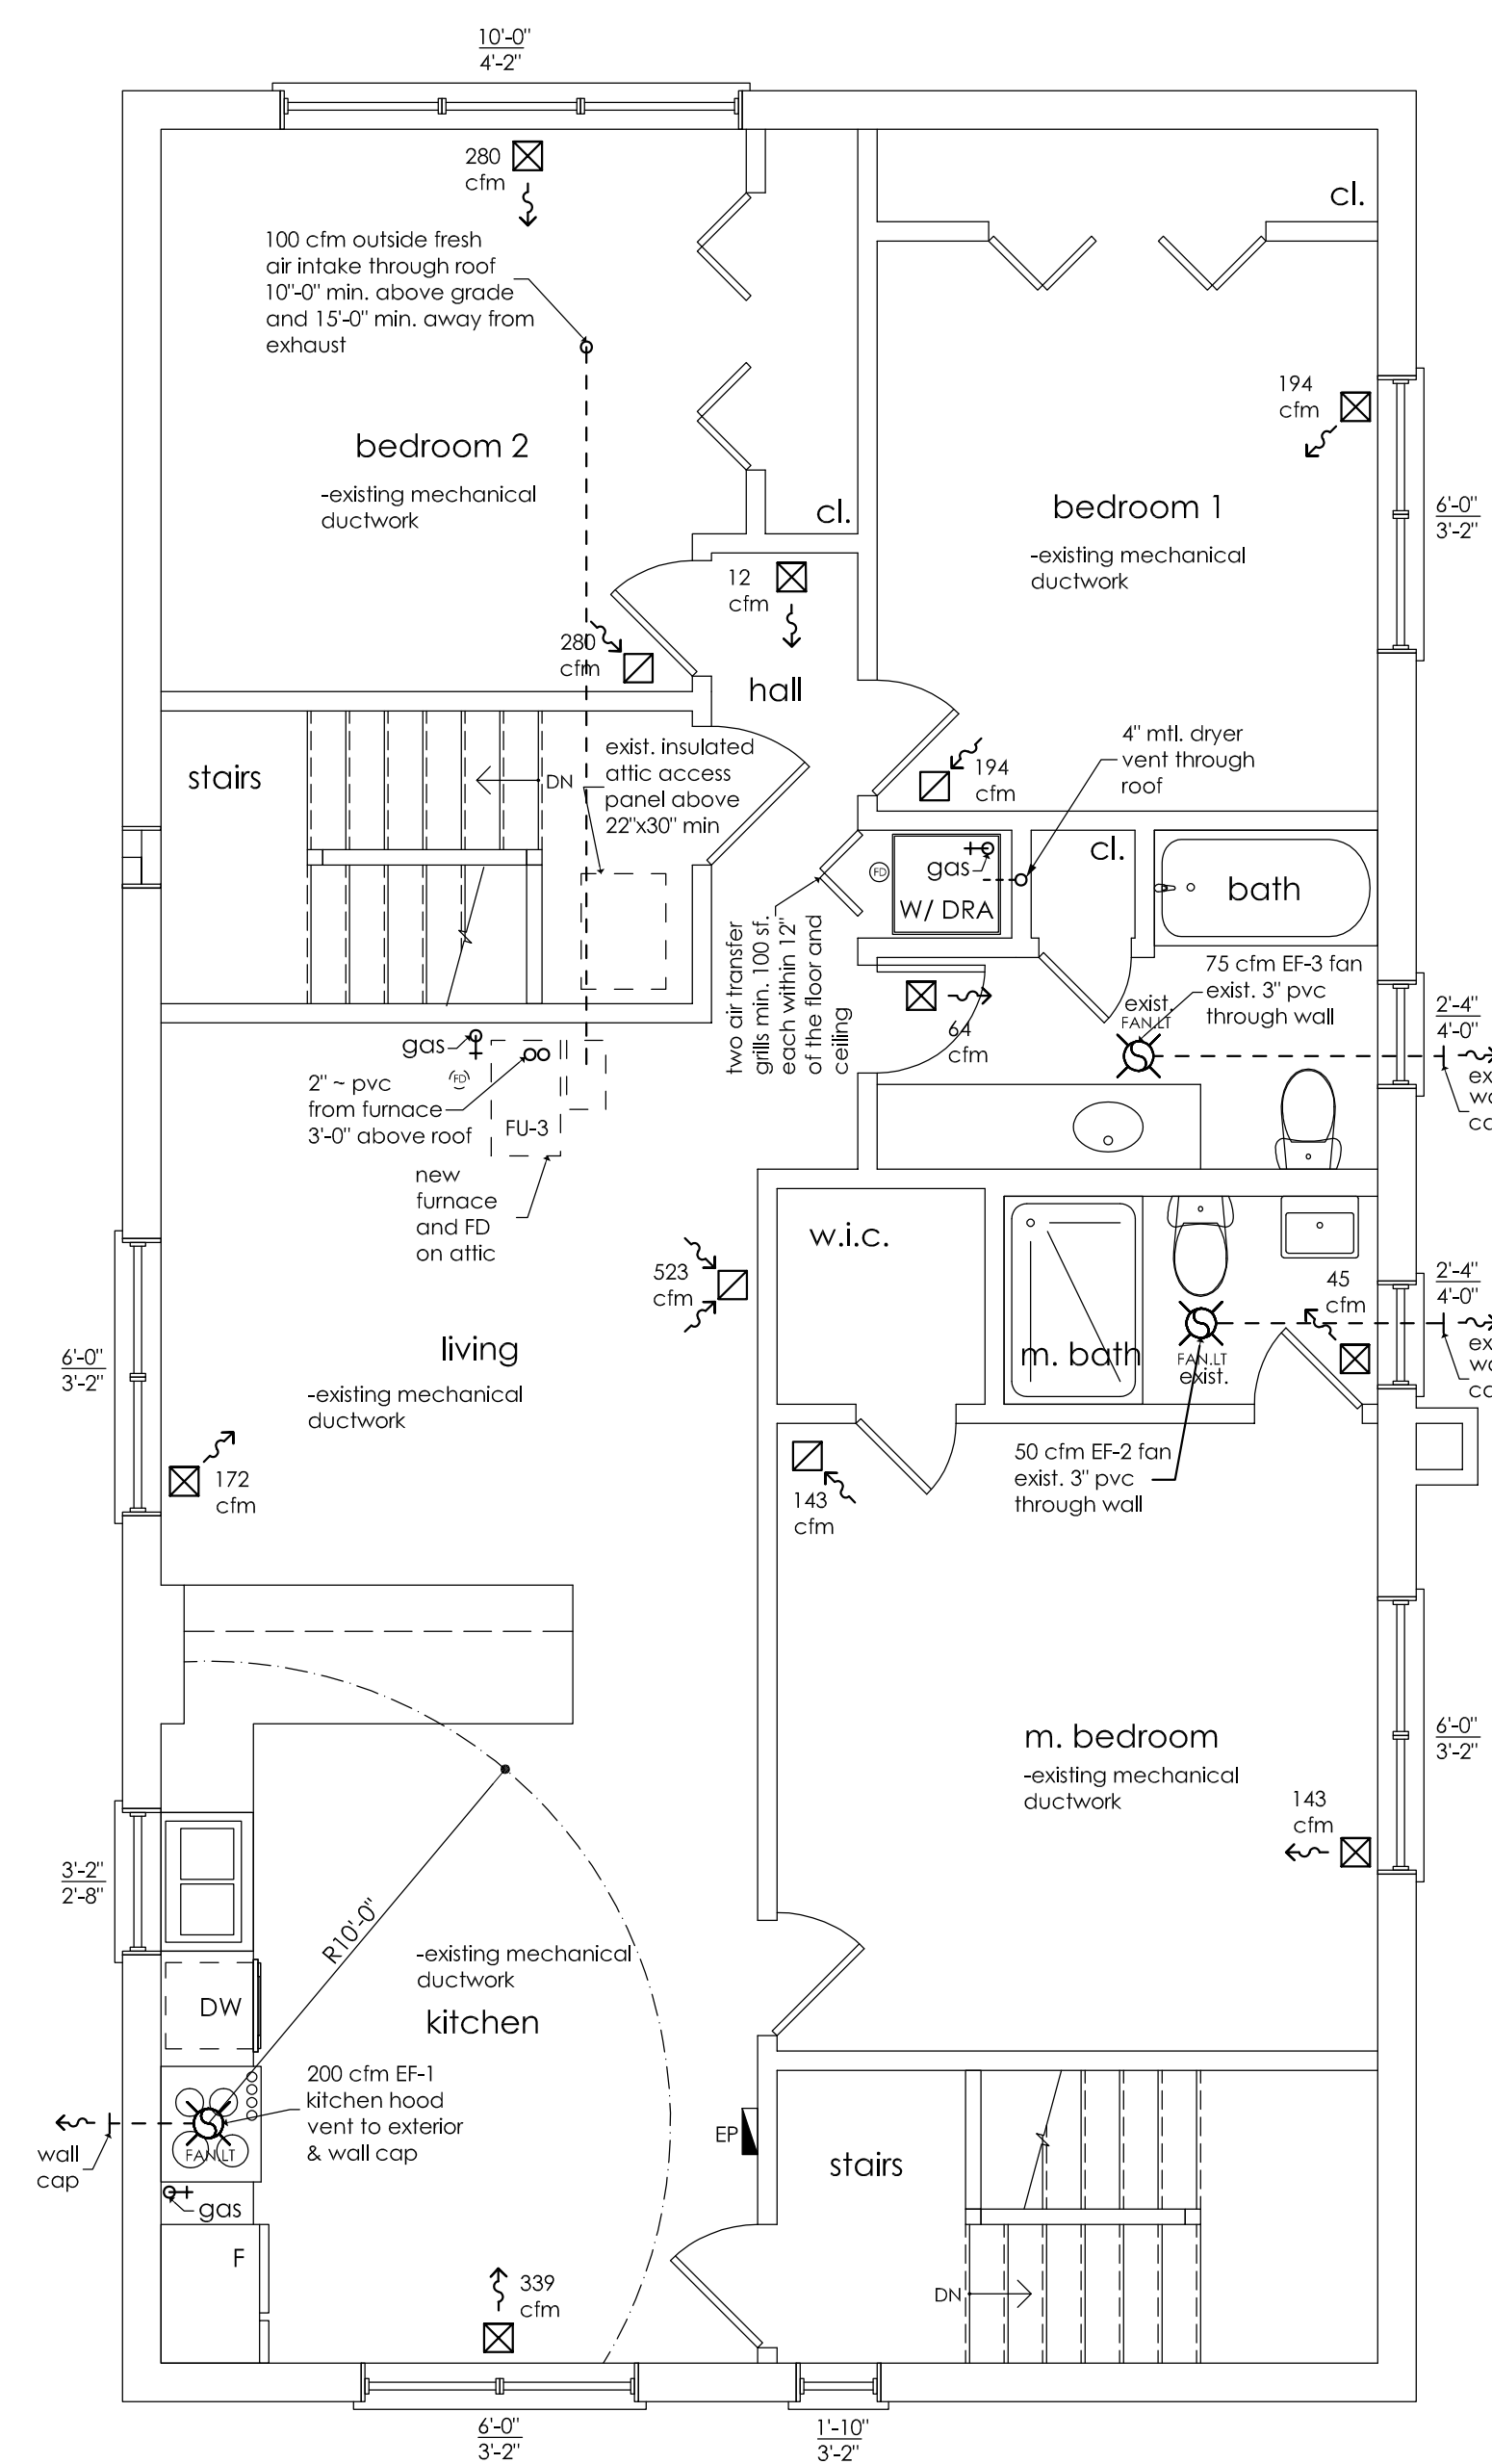


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**A-4**  
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**Mechanical 2nd Floor Plan**  
SCALE: 1/4" = 1'-0"

**Mechanical 1st Floor Plan**  
SCALE: 1/4" = 1'-0"

**Mechanical Basement Plan**  
SCALE: 1/4" = 1'-0"



VENTILATION SCHEDULE BASED ON ORDINANCE REQUIREMENTS									
	AREA (SF)	ORDINANCE REQ. SQ.FT.		ACTUAL SQ.FT.		ORDINANCE REQ. MECH. VENTILATION		ACTUAL MECHANICAL VENTILATION	
		NATURAL LIGHT	NATURAL VENT	NATURAL LIGHT	NATURAL VENT	SUPPLY	EXHAUST	SUPPLY	EXHAUST
1st, 2nd floor									
kitchen	205.0	16.40	8.20	41.86	20.93		100		200 CFM (EF-1)
living	170.0	13.60	6.80				N.R.		
bedroom 1	134.0	10.72	5.36	17.12	8.56		N.R.		
bedroom 2	150.0	12.00	6.00	37.53	18.77		N.R.		
m. bedroom	177.0	14.16	7.08	17.12	8.56	39.74	N.R.	100.00	
m.bath	36.0	N/R	N/R	8.39	4.20		50/20 cont.		50 CFM (EF-2)
bath	63.0	N/R	N/R	8.39	4.20		50/20 cont.		75 CFM (EF-3)
hall	39.0	N/R	N/R	0.00	0.00		N.R.		


VENTILATION SCHEDULE BASED ON ORDINANCE REQUIREMENTS									
	AREA (SF)	ORDINANCE REQ. SQ.FT.		ACTUAL SQ.FT.		ORDINANCE REQ. MECH. VENTILATION		ACTUAL MECHANICAL VENTILATION	
		NATURAL LIGHT	NATURAL VENT	NATURAL LIGHT	NATURAL VENT	SUPPLY	EXHAUST	SUPPLY	EXHAUST
basement									
kitchen	133.0	10.64	5.32	21.59	10.80		100		200 CFM (EF-1)
living	133.0	10.64	5.32				N.R.		
bedroom 1	164.0	13.12	6.56	13.50	6.75		N.R.		
bedroom 2	148.0	11.84	5.92	25.47	12.74		N.R.		
bath	46.0	N/R	N/R	5.24	2.62		50/20 cont.		50 CFM (EF-2)
hall	143.0	N/R	N/R	0.00	0.00		N.R.		

Refrigeration Schedule										
Item	Qty	Manuf.	#Comp.	Ref. type	Tons	H.P.	Weight	Unit serv.	Location	Remarks
AC-1	1	American Standard	1 ea.	R-410A	1.5	1.5	3.0	bs	Grade	Rem./ Air
AC-2	1	American Standard	1 ea.	R-410A	1.5	1.5	3.0	1st	Grade	Rem./ Air
AC-3	1	American Standard	1 ea.	R-410A	3.0	3.0	6.0	2nd	Grade	Rem./ Air

- Mechanical Notes**
- See Manual J and S calculations provided by HVAC contractor.
  - HVAC contractor upon completion of the project and before the final inspection, shall perform a complete testing and balancing of all equipment. Balance system to within +/-10% of air quantities and provide the owner and the building official with a complete, signed, and sealed balance report.
  - The maximum length of a 4" diameter clothes dryer exhaust vent shall not exceed 35'-0" from the dryer location to the wall or roof termination and shall terminate with a full opening exhaust hood. A reduction in maximum length of 2.5' for each 45-degree bend and 5' for each 90-degree bend shall apply. Installations, when this length is exceeded, shall be installed per the manufacturer's specifications.


- Note:**
- Down-flow units and other coils that do not have secondary drain or provisions to install a secondary or auxiliary drain pan, a water level monitor device shall be installed inside the primary drain pan.
  - Any HVAC testing performed, required or not, shall be submitted to the Village of Oak Park or inclusion into the permanent building file. (Section 106.3.1)
  - The termination points of exhaust outlets and ducts discharging to the outdoors shall be located a minimum 10-feet (10') from property lines; 10-feet (10') from operable openings into buildings; 3-feet (3') from exterior walls, windows, and roofs and a minimum of 10-feet (10') above adjoining grade. (Section 501.3.1(2))
  - Thermostat shall be programmable and shall have setback capabilities (Section: R403.1.1)

**Note:**  
The minimum efficiency level for split-system central air conditioners requires units to be at least 14 SEER (Seasonal Energy Efficiency Ratio)

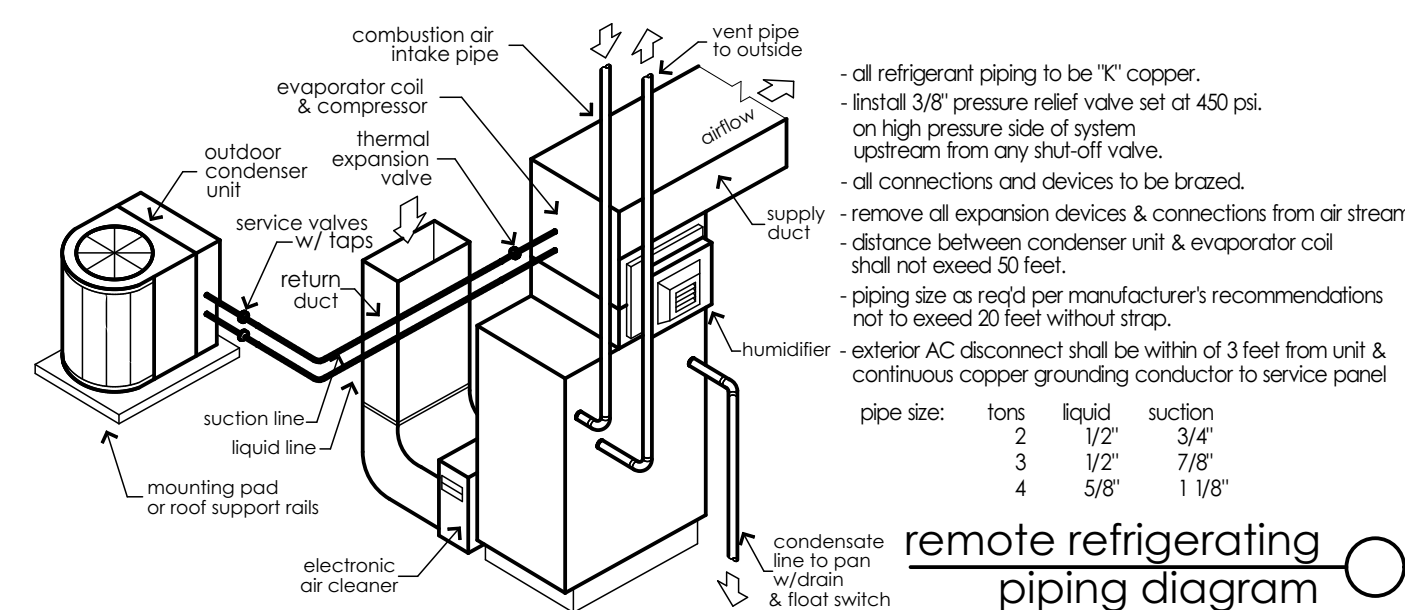


**Mechanical Equipment**

- EF-# \* Broan or equal exhaust fan, gravity damper, duct to roof or wall cap (cfm per light/vent schedule)
- FU-1 \*American Standard S9V2B04U3VS high efficiency gas fired furnace 40 Mbtu input, 39 Mbtu output w/ programmable thermostat, humidifier electronic air cleaner.
- FU-2 \*American Standard S9V2B04U3VS high efficiency gas fired furnace 40 Mbtu input, 39 Mbtu output w/ programmable thermostat, humidifier electronic air cleaner.
- FU-3 \*American Standard S9V2B04U4PS high efficiency gas fired furnace 60 Mbtu input, 58 Mbtu output w/ programmable thermostat, humidifier electronic air cleaner.
- AC-1 \* American Standard 4A7A3018H1 air cooled condensing unit w/ Puron R-410 A refrigerant, grade location
- AC-2 \* American Standard 4A7A3018H1 air cooled condensing unit w/ Puron R-410 A refrigerant, grade location
- AC-3 \* American Standard 4A7L5036N1 air cooled condensing unit w/ Puron R-410 A refrigerant, grade location
- WH \* Gas fired water heater 40 Mbtu input, 37 Mbtu output

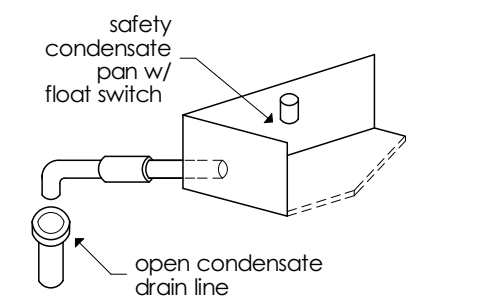

- Mechanical notes:**
- All work shall comply with 2021 International Mechanical Code w/ amendments
  - Contractor shall be required to furnish all labor, materials, equipment etc. necessary to make a complete mechanical system.
  - HVAC contractor shall check all calculated heating and cooling loads and verify that HVAC equipment, devices, ducts, registers are adequate.
  - All materials, devices, equipments and appliances shall be certified by an acceptable listing agency.
  - Fit all work into available space meet the requirement and coordinate with other trades and follow the structural elements of the building as closely as possible.
  - Contractor shall cut and patch as required for a complete installation of the HVAC system.
  - Structural members shall not be unnecessarily or carelessly weakened by cutting or notching. Structural members which are modified shall be repaired in an acceptable manner as to guarantee the structural integrity of the design.
  - Complete and test rough-in work before any finish work installed and make any required adjustments to assure a safe operating system.
  - All work shall be installed as recommended by "ASHRAE" & "SMACHA" and in accordance with the requirements of adopted codes, regulations and standards.
  - HVAC contractor is to confirm equipment location and advise if an alternate location is requested.
  - Pipes and shall be fire caulked when penetrate rated enclosure. Pipe that penetrate fire resistance rated floor, wall assembly shall have approved fire damper.
  - Mechanical contractor shall provide humidifier w/ drain & programmable thermostats as required and as specified with the equipment.
  - All bathroom exhaust fans to be UL approved 3" dia. PVC insulated (R-6) pipe discharge to exterior thru wall or roof.
  - Mechanical system piping capable of carrying fluids shall be insulated to a min. R-3. Heating contractor to run all condensate lines to floor drain or other drain provided.
  - Install pressure relief valve on high pressure side of system, upstream of any intervening valves, remove expansion valves, devices, & connections from air stream.
  - Refrigeration piping to be type "K" copper. All connections and devices to be brazed. Copper tube used for the refrigerant piping erected on the premises shall be seamless copper tube of type ACR
  - HVAC contractor is to provide a complete system and start up with setting and adjusting of all controls, adjust input, blower speed and dampers. Contractor is responsible for final control wiring hook up all equipment, scheduling and following up on.

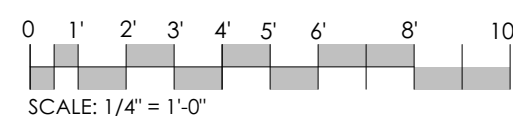

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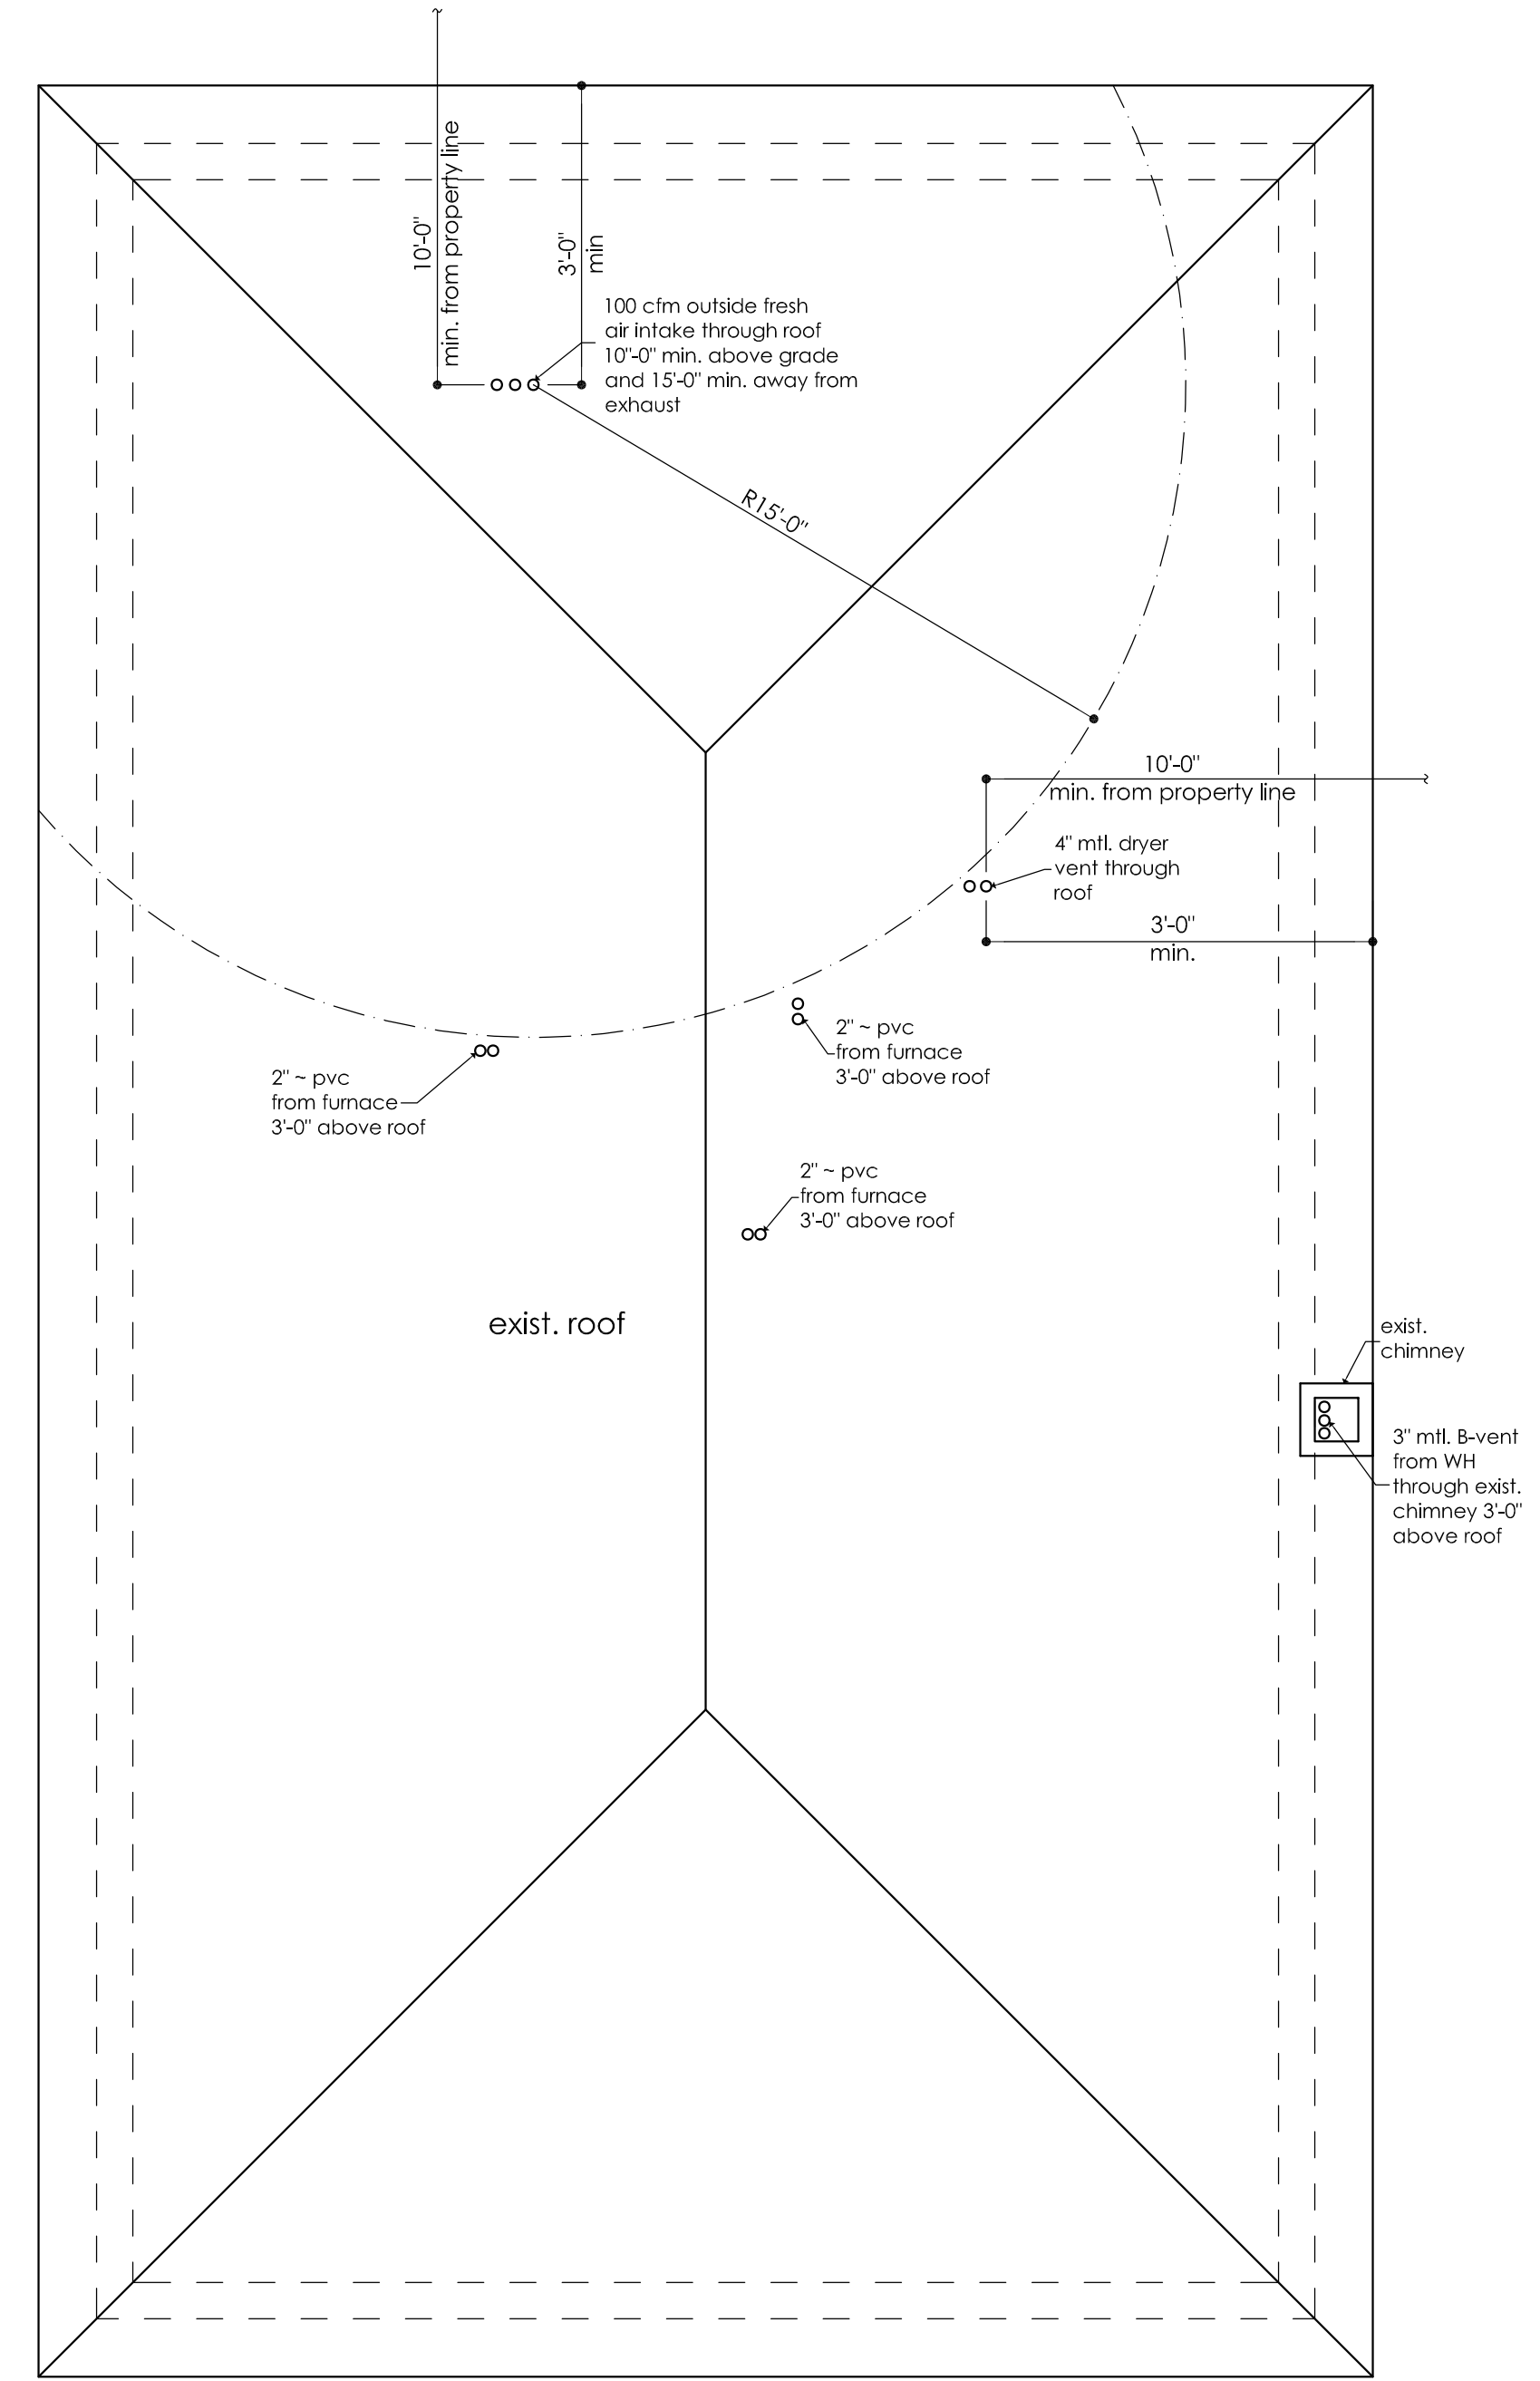
I hereby certify that these drawings were prepared under my responsible control and to the best of my knowledge, complies with the Village of Oak Park adopted Codes

Architects seal  
ALAN LESKIV ARCHITECT  
09/23/2024  
Expires: 11/30/2024


**3 UNIT BUILDING ALTERATION**  
B20 MAPLE AVE  
OAK PARK \*\*\* ILLINOIS

Project # 24-124  
Date: 09/23/2024  
Drawn by: AL  
Checked: LA  
Revision 1:  
Revision 2:  
Revision 3:

Sheet #  
**A-5**  
Scale: as shown




-The termination points of exhaust outlets and ducts discharging to the outdoors shall be located a minimum 10-feet (10') from property lines; 10-feet (10') from operable openings into buildings; 3-feet (3') from exterior walls, windows, and roofs and a minimum of 10-feet (10') above adjoining grade. (Section 501.3.1(2))

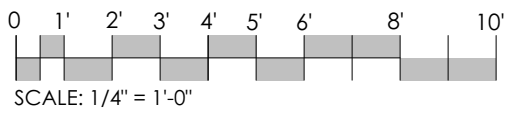


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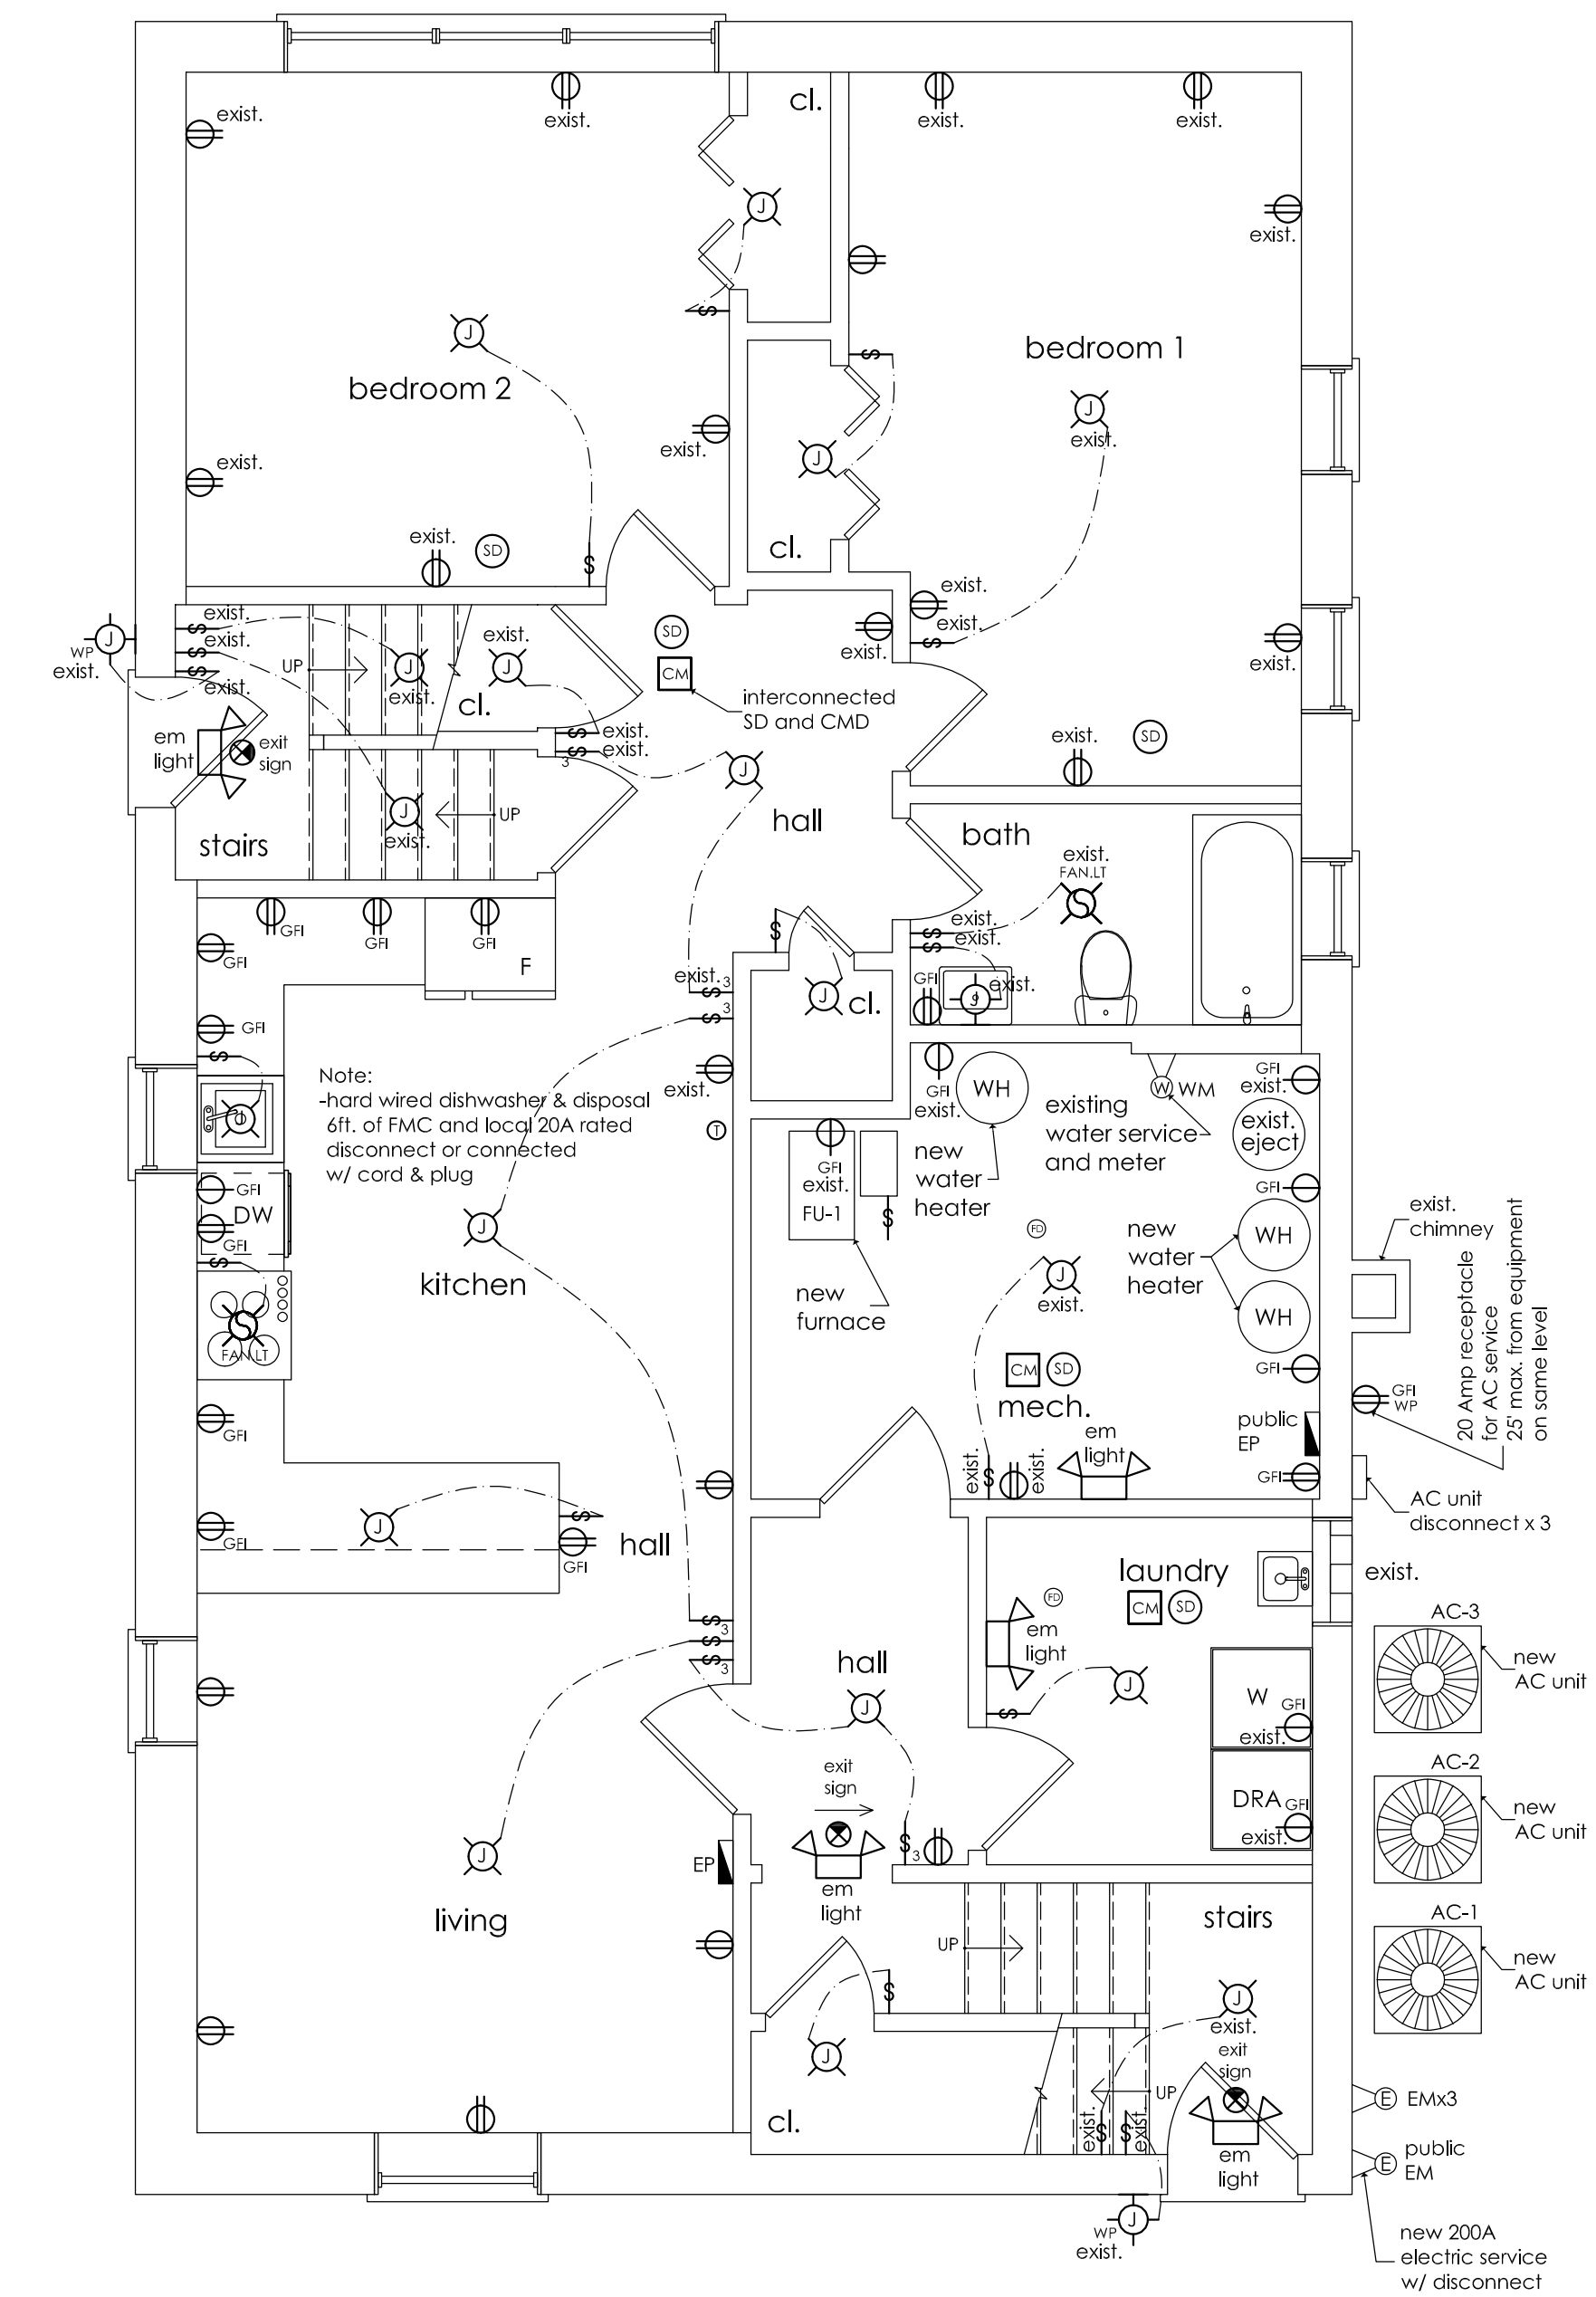
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Electrical 2nd Floor Plan  
SCALE: 1/4" = 1'-0"

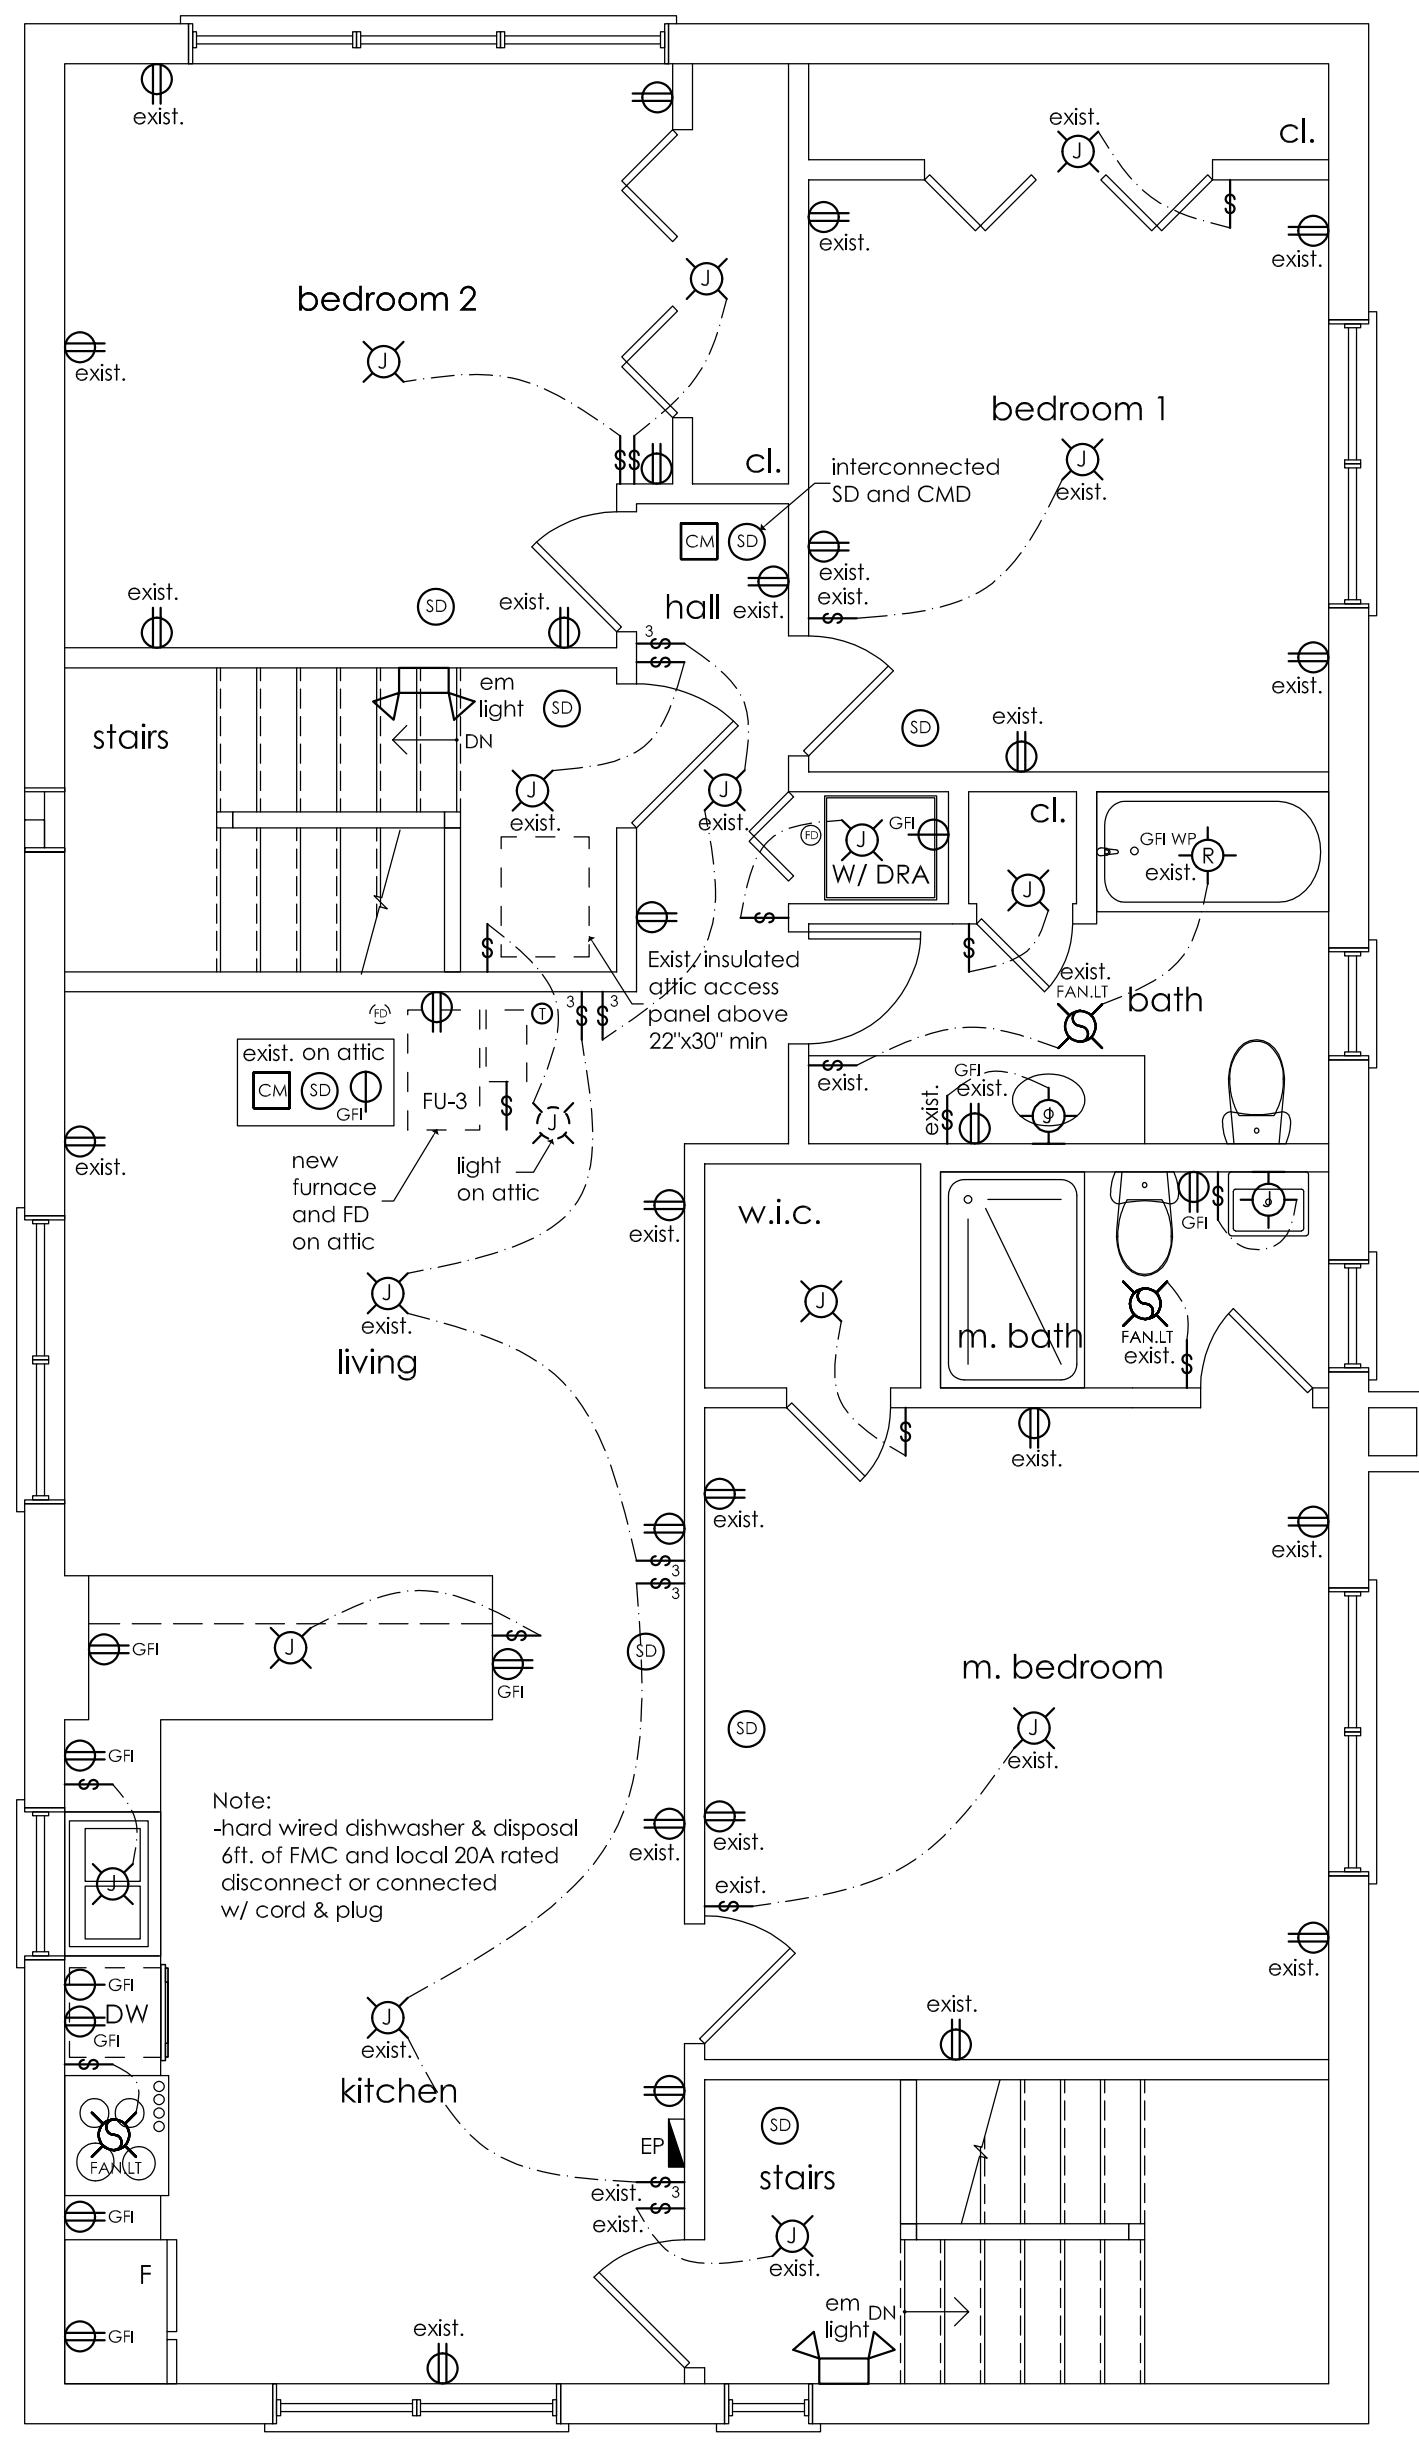

Electrical 1st Floor Plan  
SCALE: 1/4" = 1'-0"

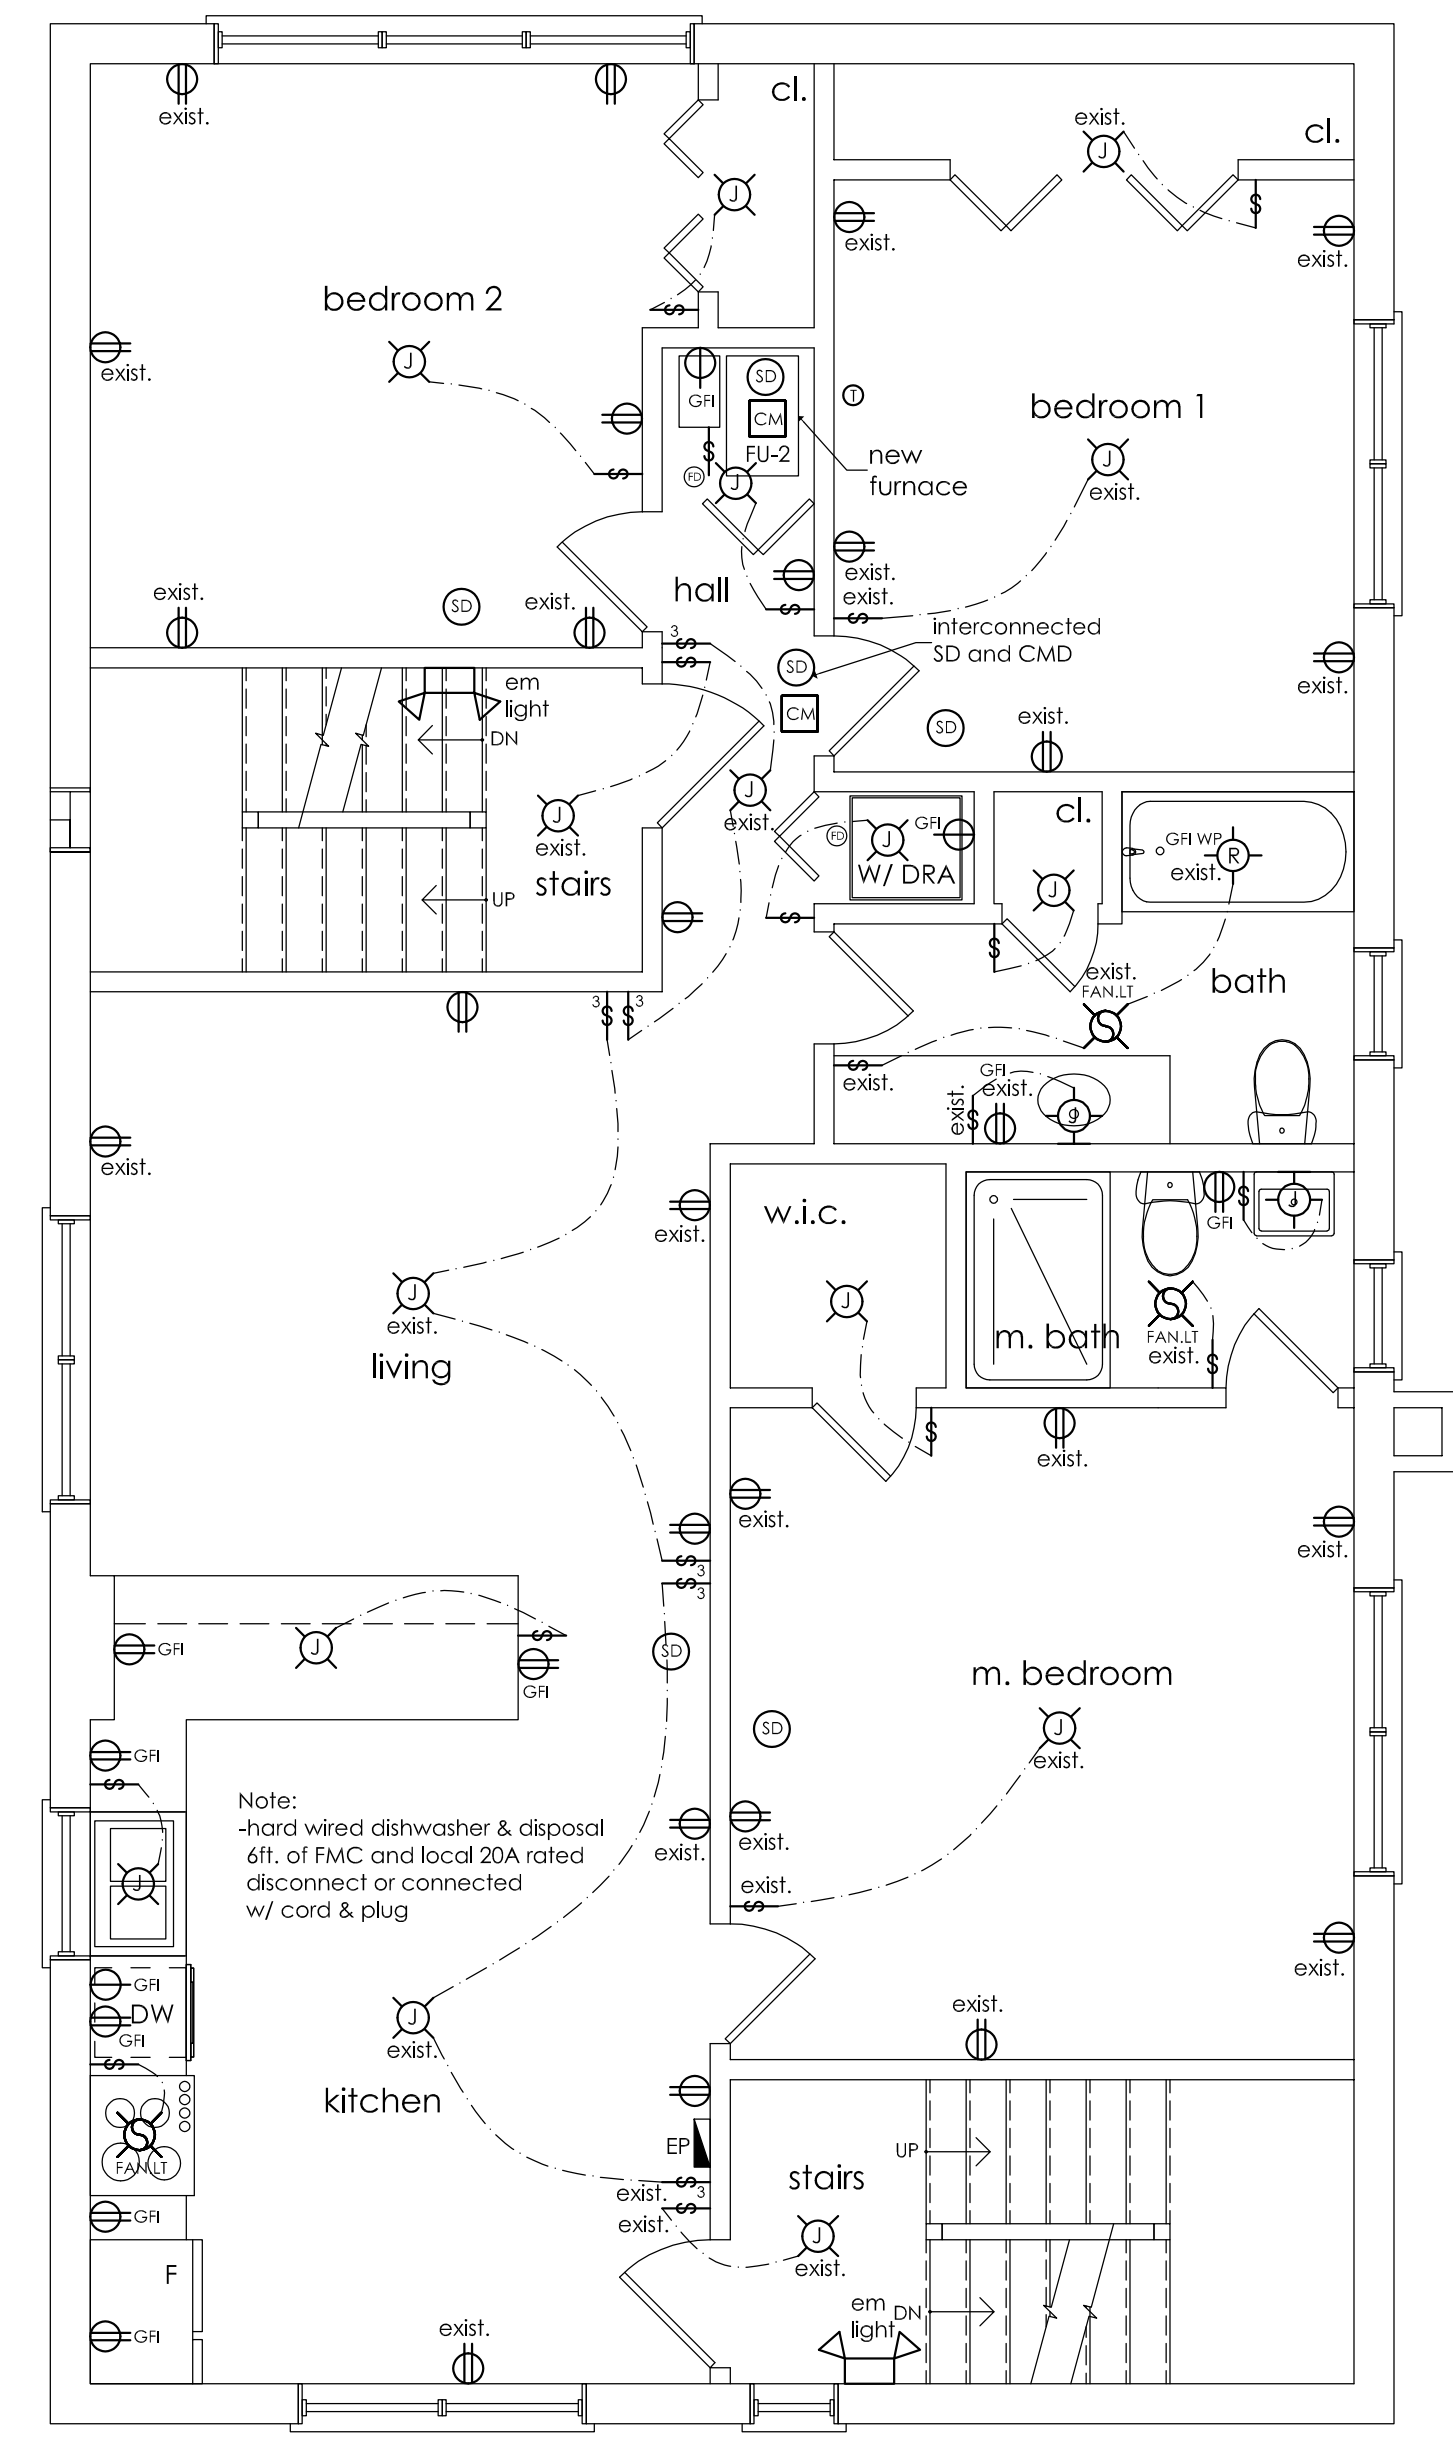

Electrical Basement Plan  
SCALE: 1/4" = 1'-0"

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STATE OF ILLINOIS  
**ALAN LESKIV**  
ARCHITECT  
09/23/2024  
Expires: 11/30/2024

**3 UNIT BUILDING ALTERATION**  
B20 MAPLE AVE  
DAK PARK \*\*\* ILLINOIS

Project # 24-124  
Date: 09/23/2024  
Drawn by: AL  
Checked: LA

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Revision 2:  
Revision 3:

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