GYP BD-(1)

GYP PL-(1)

HD WD-(1)

HVAC

INCL

INSUL

LT WT

LLH

LLV

LVR

MATL

MAX

MB (16)

MECH

MSB

MTL

NOM

NTS

OC

OD

OF

OPNG

OPP

PSF

PTN

PVMT

MECH CONTR

GYPSUM WALL BOARD (TYPE)

HEATING/VENTILATING/AIR CONDITIONING

INCLUDE/INCLUDING/INCLUDED

INSULATION/INSULATING/INSULATED

LAMINATE/LAMINATING/LAMINATED

MARKERBOARD (LENGTH IN FEET)

MECHANICAL CONTRACTOR

MINIMUM OR MINUTE(S)

MOP SERVICE BASIN (SINK)

OVERALL OR OUTSIDE AIR

OUTSIDE FACE OR OPPOSITE FACE

OPPOSITE OR OPPOSITE HAND

PRESSURE TREATED OR PAINT

POUNDS PER SQUARE FOOT

POUNDS PER SQUARE INCH

THE MATERIALS, ABBREVIATIONS, AND DRAFTING SYMBOLS LEGEND ARE EACH AN ALL INCLUSIVE MASTER LIST USED BY THIS FIRM. THE INCLUSION OF THESE LEGENDS INTO THESE DOCUMENTS DOES NOT IMPLY THAT ALL THE SYMBOLS OR MATERIALS INCLUDED IN THESE LEGENDS ARE INCORPORATED INTO THIS PROJECT. ABBREVIATIONS MAY APPEAR WITH PERIODS OR OTHER

PUNCTUATION SEPARATING CHARACTERS ON THE DRAWINGS: THE MEANING REMAINS THE SAME.

OUTSIDE DIAMETER

GYPSUM PLASTER (TYPE)

**HEAVY DUTY OR HARD** 

HARD WOOD (TYPE)

HARDENER

**HARDWARE** 

**HIGH POINT** 

**HORIZONTAL** 

HEATING

**HOLLOW METAL** 

INSIDE DIAMETER

KNOCK DOWN

LAVATORY

LEFT HAND

**LOW POINT** 

MASONRY

MATERIAL

MAXIMUM

**MECHANICAL** 

MOUNT(ED)

METAL

MANUFACTURER

NOT IN CONTRACT

NOT TO SCALE

ON CENTER

OPENING

PARTITION

PAVEMENT

LIGHTWEIGHT

LONG LEG HORIZONTAL

LONG LEG VERTICAL

MASONRY OPENING

METAL THRESHOLD

HEIGHT

AVERAGE

**BASEMENT** 

**BOTTOM OF** 

BETWEEN

BUILDING

**BITUMINOUS** 

**BENCH MARK** 

**BEARING** 

**BRACKET** 

BRICK

BRKT

CAB

COL

COMP

CONC

COND

CONT

**CONTR** 

CPT-(1)

CT-(1)

CTR SK

CTRS

CUH

CUV

DWGS

DWL'S

**ELEC** 

ELEV

**EMER** 

EQ

**EWC** 

EWH

**EMBED** 

**ELEC CONTR** 

CTR

CONC OPNG

BT STL P

CEM PL-(1

CT PAV-(1)

**BLOCKING (WOOD)** 

**BENT STEEL PLATE** 

**CAST-IN-PLACE** 

CEILING

CLEAN-OUT

COLUMN

COMBINATION

**CONCRETE OPENING** 

CERAMIC TILE (TYPE)

CABINET UNIT HEATER

CABINET UNIT VENTILATOR

CONCRETE

CONDITION

**CONTINUOUS** 

CONTRACT(OR)

CARPET (TYPE)

COUNTER SINK

COUNTER

CENTER(S)

DIAMETER

**DIMENSION** 

**DRAWINGS** 

DETAIL

DOWELS

ELEVATION

EMBEDMENT

**EMERGENCY** 

EPOXY

EQUAL

EACH WAY

EACH

DOOR OPENING

**EXPANSION JOINT** 

ELECTRIC/ELECTRICAL

ELECTRICAL CONTRACTOR

ELEVATOR OR ELEVATION

ELECTRIC WATER COOLER

ELECTRIC WATER HEATER

CLEAR

**CEMENT PLASTER (TYPE)** 

CERAMIC PAVER TILE (TYPE)

**CONCRETE MASONRY UNIT** 

COMPRESSIBLE OR COMPACTED

CONSTRUCTION OR CONTRACTION JOINT

BOARD

		l '	
	INTERIOR ELEVATION ELEVATION NUMBER — DRAWING NUMBER —	6 A916 5 3	G SYM
REQUIRED TO SEPARATE DISSIMILAR METALS, FILL  S ASSEMBLIES MEET OR WHERE OTHERWISE  HE IMMEDIATE ATTENTION OF THE  .	SECTION REFERENCE SECTION NUMBER — DRAWING NUMBER —	1 A605	SYMBOLS
SSEMBLIES THAT ARE SOILED, CUT OR DAMAGED IN PATCHING SUCH THAT EDGES BLEND INTO D COLOR OF ADJACENT SURFACES.	COLUMN NO.	<b>26</b> — - —	N
	REFERENCE LINE NO.	<b>26</b> —-—	
	LOCATION ELEVATION	T/1ST FLR.	AND MATERIALS
	ROOM NUMBER	204	RIALS
	DOOR NO. NEW DOOR NO. EXISTING	<b>203.2</b> 203.1X	
	NOMINAL THICKNESS — CONSTRUCTION TYPE — SPECIAL CONDITION —	M8b	GEND
	KEYNOTE IDENTIFICATION	7.531	
	WINDOW TYPE IDENTIFICATION	⊗	
	TOILET ACCESSORY  IDENTIFICATION	A	
	SPOT ELEVATION	+ 115.115 + 115.115	
PIECE	FIRE-R	<u>ATING</u>	
PLATE PLASTIC LAMINATE(D)		1-HOUR	
PLASTER PLUMBING PLUMBING CONTRACTOR		2-HOUR	
PLYWOOD PAINT PRECAST (CONCRETE) OPENING POLYVINYL CHLORIDE	A. A. A.	CONCRETE	
GYPSUM PLASTER (TYPE) RISER RADIUS		BRICK MASONRY IN PLAN	
ROOF DRAIN ROUGH OPENING RUBBER FLOORING (TYPE) RIGHT HAND		CONCRETE MASONRY IN PLAN (RUNNING BOND)	
REFERENCE REINFORCE/REINFORCING/REINFORCED REQ'D REQUIRED		CONCRETE MASONRY IN PLAN (STACK BOND)	
ROOM SQUARE FOOT SQUARE INCH SINK		STONE MASONRY IN PLAN	
STAINLESS STEEL SERVICE SINK SQUARE SCHEDULE		RAKED JOINT IN PLAN CTRL./EXP. JOINT IN PLAN	
SEALER/HARDENER SECTION SHEET		BRICK MASONRY IN SECTION DETAIL	
SIMILAR SLAB ON GRADE SPECIFICATION(S) SPACING		CONCRETE MASONRY IN SECTION DETAIL	
SPEAKER STANDARD STANDARD WEIGHT		STONE MASONRY IN SECTION DETAIL	
STEEL STRUCTURE OR STRUCTURAL SUSPEND(ED) SYMMETRICAL		STEEL IN SECTION DETAIL DISCONTINUOUS	
TREAD TONGUE AND GROOVE TOP OF TOP OF BEAM		ROUGH WOOD BLOCKING IN SECTION CONTINUOUS ROUGH	
TOP OF CURB TOP OF FOUNDATION TOP OF STEEL		WOOD FRAMING/BLOCKING IN SECTION	
TOP OF WALL TACKBOARD (LENGTH IN FEET) TOP OF MASONRY TYPICAL		FINISHED WOOD IN SECTION DETAIL	
(WINDOW) UNIT DIMENSION UNLESS NOTED OTHERWISE VINYL BASE COVED		RIGID BOARD INSULATION	
VINYL BASE STRAIGHT VINYL COMPOSITION TILE VENEER PLASTER (TYPE) VERTICAL		RIGID BOARD INSULATION (ROOFING)	
WIDE OR WIDTH WITH WITHOUT WALL CORNER GUARD		BATT INSULATION	
WOOD WINDOW WEIGHT		GYPSUM BOARD	
WATER PROOF WELDED WIRE FABRIC WALL SERVICE BASIN		ACOUSTICAL CEILING PANEL  BITUMINOUS	
		CONCRETE (ASPHALT) PAVING IN SECTION  AGGREGATE	
		BALLAST, FILL OR BACKFILL IN SECTION	

UNDISTURBED EARTH

EARTH BACKFILL

SCHED

SOG

SPK'R

STD WT

STRUCT

T/BEAM

T/FNDN

T/WALL

TB (4)

UD

VCT

W/O

WCG

VEN PL (1

T/C

STL

SEAL/HDNR

A1224 /

DETAIL NUMBER

DRAWING NUMBER -

ELEVATION NUMBER

DRAWING NUMBER —



**PROJECT** VILLAGE OF OAK PARK - PUBLIC

WORKS HVAC IMPROVEMENTS

201 S. BLVD. OAK PARK, IL 60302

VILLAGE OF OAK PARK OWNER 201 S. BLVD.

OAK PARK, IL 60302

**KLUBER ARCHITECTS + ENGINEERS** ARCHITECT/ **ENGINEER** 41 W BENTON STREET

> **AURORA, ILLINOIS 60506** TEL (630) 406-1213 FAX (630) 406-9472 www.kluberinc.com

REQUIRED CODE COMPLIANCE INFORMATION

REQUIRED PLAN COVER SHEET

UNDER 2021 INTERNATIONAL CODES

STATE OF ILLINOIS ACCESSIBILITY CODE, AND

THE STATE OF ILLINOIS PLUMBING CODE

**CODE REVIEW DATA** 

PROJECT CONSISTS OF INTERIOR HVAC IMPROVEMENTS CONSISTING OF UNIT HEATER REPLACEMENT, FIRE DAMPER REPLACEMENT AND DAMAGED DUCT WORK REPLACEMENT TO

AN EXISTING MULTI-STORY PUBLIC WORKS BUILDING. BUILDING COMPONENTS AND SYSTEMS MODIFIED OR REPLACED AS PART OF THE WORK OF THIS PROJECT HAVE BEEN

### MECHANICAL PLAN ME410 MECHANICAL SCHEDULES AND DETAILS

ME300 BASEMENT MECHANICAL PLAN AND DETAILS ME310 FIRST FLOOR MECHANICAL PLAN AND DETAILS ME320 SECOND FLOOR MECHANICAL PLAN & PARTIAL ROOF

**INDEX OF DRAWINGS** 

G100 COVER SHEET, GENERAL NOTES, SYMBOLS, & DRAWING

## **APPLICABLE CODES**

2021 INTERNATIONAL MECHANICAL CODE 2021 INTERNATIONAL FUEL GAS CODE 2018 INTERNATIONAL EXISTING BUILDING CODE 2021 INTERNATIONAL FIRE CODE 2021 NATIONAL ELECTRICAL CODE LOCAL AMENDMENTS TO THE ABOVE CODES

2021 INTERNATIONAL BUILDING CODE

2021 INTERNATIONAL ENERGY CONSERVATION CODE W/STATE AMENDMENTS)

2018 ILLINOIS ACCESSIBILITY CODE

### **SEALS & CERTIFICATIONS**

I HAVE PREPARED, OR CAUSED TO BE PREPARED UNDER MY DIRECT SUPERVISION, THE ATTACHED PLANS AND SPECIFICATIONS AND STATE THAT TO THE BEST OF MY KNOWLEDGE AND BELIEF, AND TO THE EXTENT OF MY CONTRACTUAL OBLIGATION, THEY ARE IN COMPLIANCE WITH IBC 2021 EDITION, THE ENVIRONMENTAL BARRIERS ACT AND THE ILLINOIS ACCESSIBILITY CODE.

GENERAL STATEMENT OF OVERALL PROJECT SCOPE AND INTENT:

A. USE AND OCCUPANCY GROUP(S) CLASSIFICATION: B, S-1, S-2.

TYPE OF CONSTRUCTION: IIB

ALLOWABLE SQUARE FOOTAGE:

FULLY SPRINKLERED; ALARMED

BROUGHT UP TO MEET THE REQUIREMENTS OF THE APPLICABLE CURRENT CODES.

C. SQUARE FOOTAGE OF BUILDING: SQUARE FOOTAGE IS APPROXIMATELY 72,338


D. OCCUPANT LOAD BASED ON INTERNATIONAL BUILDING CODE: NOT APPLICABLE, NO CHANGE.

OCCUPANT LOAD BASED ON ILLINOIS PLUMBING CODE: NOT APPLICABLE, NO CHANGE.


NOT APPLICABLE; NO CHANGE OF USE

G. THE DESIGN PROFESSIONALS IN RESPONSIBLE CHARGE ARE IDENTIFIED IN THE SEALS AND CERTIFICATES AREA, BELOW

KLUBER, INC. ILLINOIS PROFESSIONAL DESIGN FIRM LICENSE #184-001284

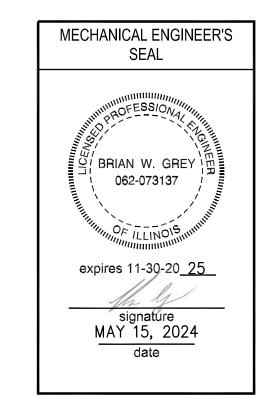

F. DESIGNED LIVE LOADS: NOT APPLICABLE; THIS IS AN EXISTING BUILDING, TO WHICH NO MODIFICATIONS ARE BEING MADE TO STRUCTURAL COMPONENTS.

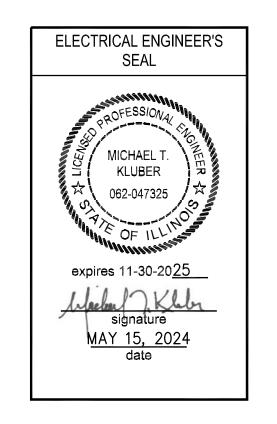

JOB NO. 24-475-1536 DRAWN CHECKED APPROVED SHEET TITLE COVER SHEET,

> SYMBOLS AND **DRAWING INDEX** SHEET NUMBER


**GENERAL NOTES,** 


26.301 DISCONNECT AND PROTECT EXISTING BRANCH CIRCUITRY TO ELECTRIC UNIT HEATER TO BE REPLACED. EXTEND BRANCH CIRCUITRY AND PROVIDE NEW ELECTRICAL CONNECTION TO ELECTRIC UNIT HEATER. DISCONNECT

26.302 DISCONNECT AND PROTECT EXISTING BRANCH CIRCUITRY TO ELECTRIC CABINET UNIT HEATER TO BE REPLACED. EXTEND BRANCH CIRCUITRY AND PROVIDE NEW ELECTRICAL CONNECTION TO ELECTRIC CABINET UNIT HEATER.


PROVIDED WITH UNIT. MATCH EXISTING.

DISCONNECT PROVIDED WITH UNIT. MATCH EXISTING.

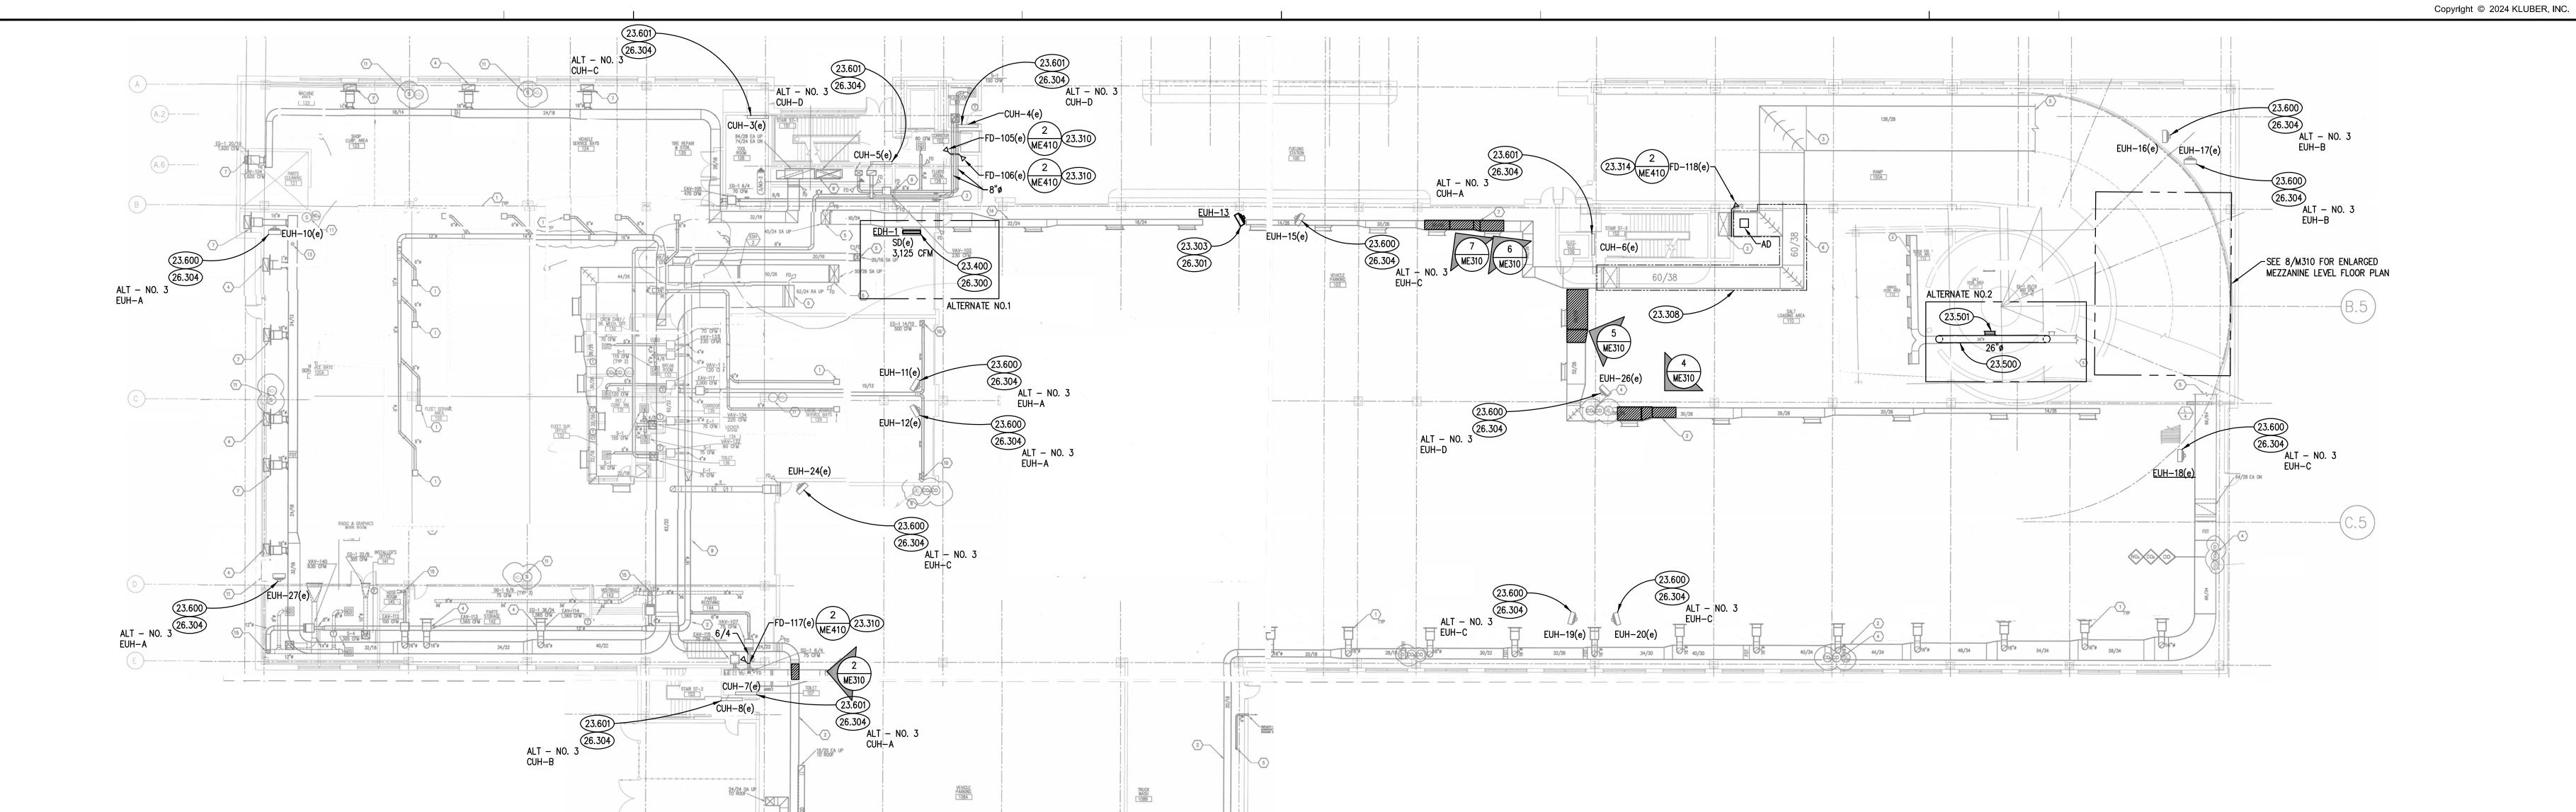


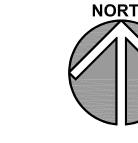



FIRST FLOOR MECHANICAL PLAN

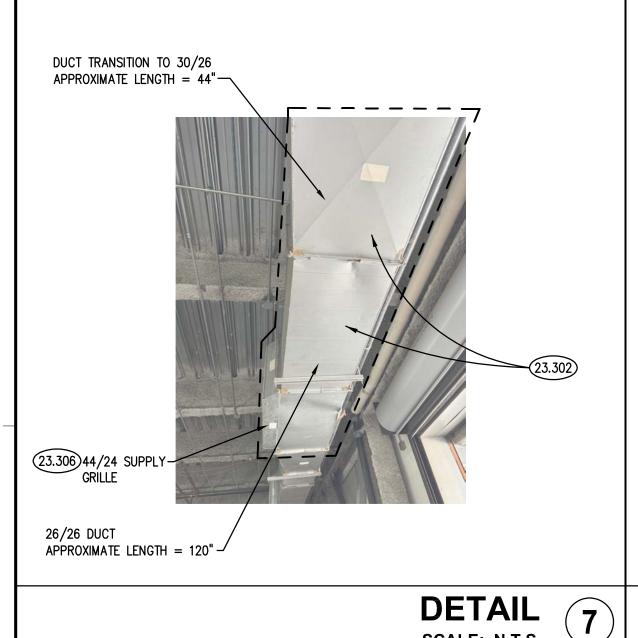



SCALE: N.T.S.

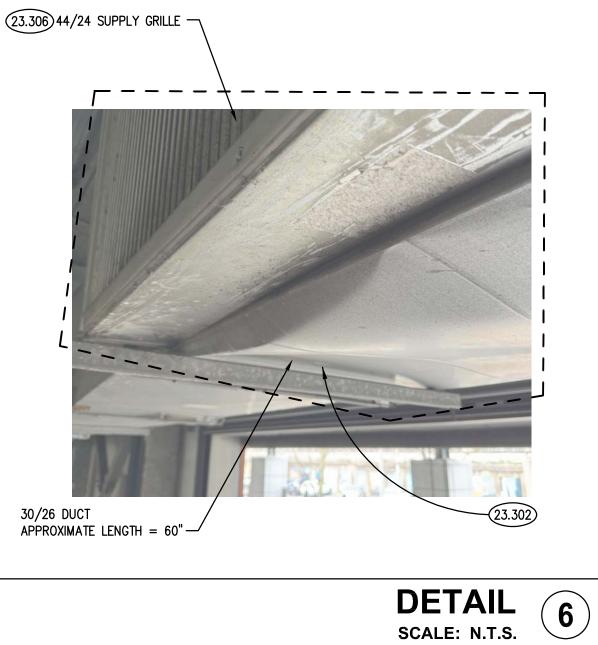

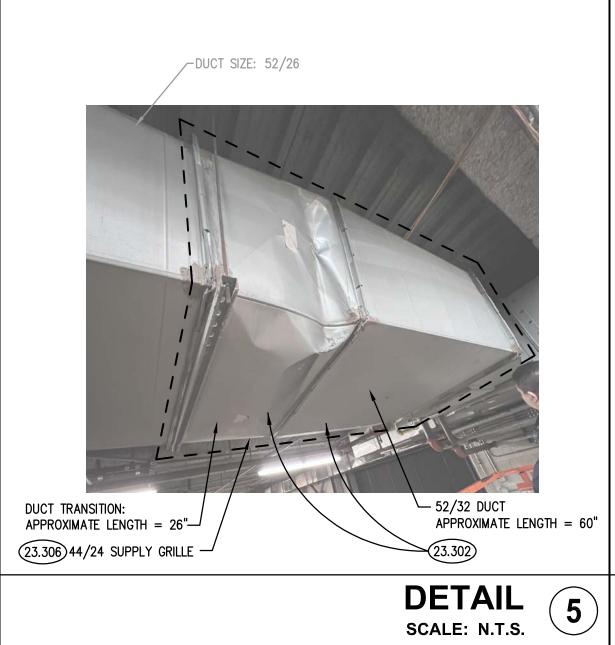

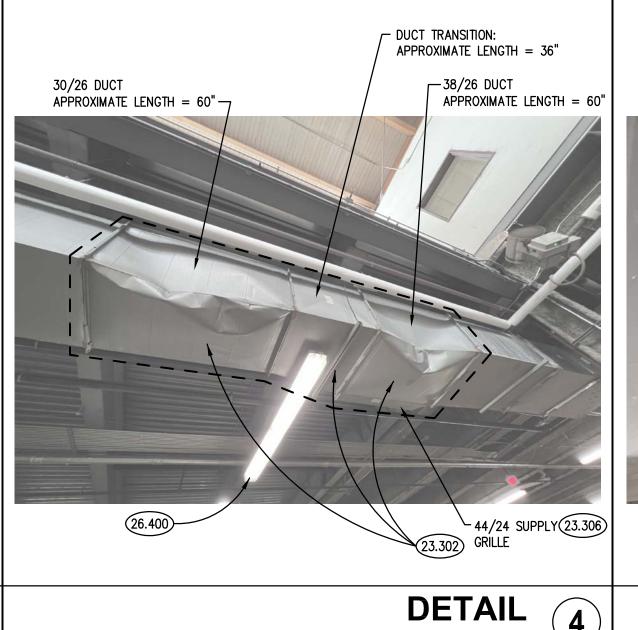

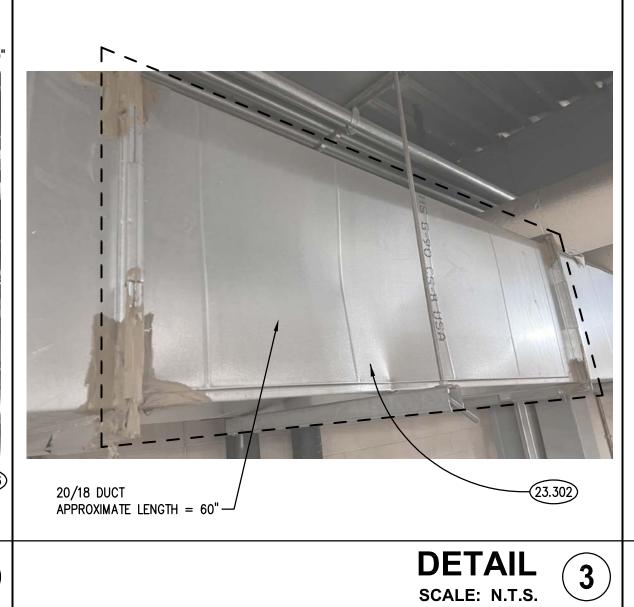

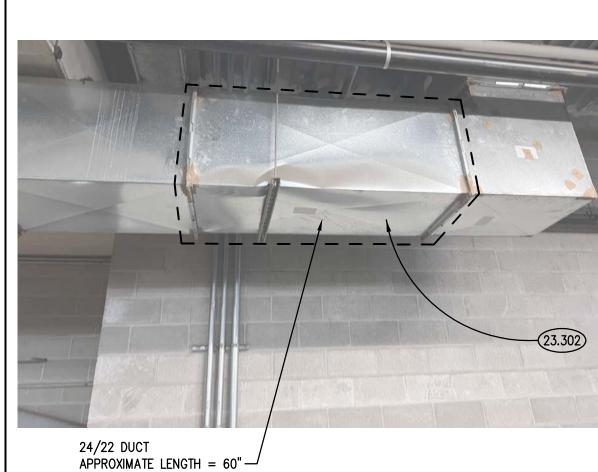

**DETAIL** SCALE: N.T.S.

FIRST FLOOR ENLARGED MEZZANINE LEVEL MECHANICAL PLAN 8

REFER TO DRAWING G100 FOR PROJECT GENERAL NOTES.

MECHANICAL GENERAL NOTES

ALL DUCTWORK ARE SHOWN DIAGRAMMATICALLY AND DO NOT SHOW ALL REQUIRED FITTINGS, OFFSETS, DROPS AND RISES. THE CONTRACTOR IS RESPONSIBLE TO PROVIDE ALL MATERIAL AND LABOR FOR A COMPLETE AND WORKING SYSTEM. COORDINATE WITH OTHER TRADES FOR SPACE AVAILABLE AND RELATIVE LOCATIONS OF EQUIPMENT, PIPING,

S. EXISTING DUCTWORK INDICATED ON THESE PLANS SHALL BE FIELD VERIFIED FOR EXACT LOCATIONS, QUANTITY AND

4. ALL TAPES AND MASTICS USED TO SEAL DUCTWORK LISTED AND LABELED IN ACCORDANCE WITH UL 181A SHALL BE

MARKED ACCORDINGLY. ALL TAPES AND MASTICS USED TO SEAL FLEXIBLE DUCTS AND AIR CONNECTORS SHALL COMPLY WITH UL 181B AND MARKED ACCORDINGLY.

5. SPACE ALLOCATION, COORDINATION WITH ELECTRICAL, ARCHITECTURAL & OTHER MECHANICAL COMPONENTS HAVE BEEN MADE WITH RESPECT TO ALL EQUIPMENT SCHEDULED ON THESE DRAWINGS AND IN THE SPECIFICATIONS OF THE FIRST NAMED MANUFACTURER ONLY. OTHER MANUFACTURERS ARE ACCEPTABLE PROVIDED THEY MEET PERFORMANCE REQUIREMENTS AND AFOREMENTIONED COORDINATION.

6. OBTAIN AND PAY ALL COSTS FOR PERMITS, LICENSES, CERTIFICATE FILING AND ALL INSPECTIONS BY AUTHORITIES

**KEYNOTES** 

SCALE: N.T.S.

23.302 REMOVE DAMAGED DUCTWORK TO BE REPLACED AND PROVIDE NEW GALVANIZED STEEL DUCTWORK MATCHING EXISTING THICKNESS. FIELD VERIFY DUCT DIMENSIONS PRIOR TO ORDERING. 23.303 REMOVE UNIT HEATER AND PROVIDE NEW UNIT HEATER. MAINTAIN ALL CLEARANCES AROUND UNIT HEATER FOR

SERVICING. PROVIDE NEW MOUNTING EQUIPMENT AS REQUIRED. INSTALL IN ACCORDANCE WITH MANUFACTURER'S

301RL-HD OR EQUAL. BALANCE TO 3,370 CFM.

23.308 EXISTING PVC DUCT WRAP SEAMS HAVE SEPARATED. PROVIDE ALL MATERIALS AND LABOR TO REPAIR AND RE-SEAL ALL JACKET SEAMS WITH WHITE VAPOR BARRIER TAPE. 23.310 REMOVE TWO FOOT SECTION OF DUCT. FIELD VERIFY DUCT DIMENSIONS. PROVIDE NEW TWO FOOT SECTION

OF REMOVABLE DUCT TO PERMIT MAINTENANCE AND TESTING OF EXISTING FIRE DAMPER. REMOVABLE SECTION OF DUCT SHALL BE LANGDON INC, SURE CLAMP ACCESS OR EQUAL, PROVIDE WITH NAMEPLATE IDENTIFYING FIRE DAMPER. INSTALL IN ACCORDANCE WITH MANUFACTURERS REQUIREMENTS.

23.314 PROVIDE NEW 24/24 ACCESS DOOR FOR FIRE DAMPER. 23.400 ALTERNATE NO. 1 - REMOVE ELECTRIC DUCT HEATER AND PROVIDE NEW ELECTRIC DUCT HEATER. FIELD

VERIFY LOCATION OF THERMOSTAT AND PROVIDE NEW THERMOSTAT. 23.500 ALTERNATE NO. 2 - REMOVE EXISTING DUCTWORK IN SALT STORAGE. PROVIDE NEW DUCTWORK FLUSH TO

SUPPORT STRUCTURE MOUNTED AS HIGH AS POSSIBLE. PROVIDE REQUIRED FITTINGS TO CONNECT TO EXISTING DUCTWORK. FIELD VERIFY EXACT DUCT SIZES. 23.501 ALTERNATE NO. 2 - REMOVE DUCT TAKEOFF AND SUPPLY GRILLE. PROVIDE NEW DUCT TAKE-OFF WITH BALANCING DAMPER AND SUPPLY GRILLE TO MATCH EXISTING. NEW GRILLE SHALL BE STEEL WITH DOUBLE DEFLECTION BLADES. TITUS 355RL-HD OR EQUAL. BALANCE TO 600 CFM.

23.600 ALTERNATE NO. 3 - EXISTING UNIT HEATER. PROVIDE UNIT PRICING TO REPLACE UNIT HEATER IN KIND. REFER TO ALTERNATE NO. 3 - ELECTRIC UNIT HEATER SCHEDULE ON DRAWING ME410 FOR ADDITIONAL

INFORMATION. 23.601 ALTERNATE NO. 3 - EXISTING CABINET UNIT HEATER. PROVIDE UNIT PRICING TO REPLACE CABINET UNIT HEATER IN KIND. REFER TO ALTERNATE NO. 3 - ELECTRIC UNIT HEATER SCHEDULE ON DRAWING ME410 FOR ADDITIONAL INFORMATION.

KEYNOTES ARE TYPICALLY NOT DUPLICATED WITHIN A GIVEN DETAIL. AN UN-KEYNOTED ITEM IN A DETAIL IS THE SAME AS A KEYNOTED ITEM HAVING THE SAME APPEARANCE WITHIN THE SAME DETAIL.

23.700 ALTERNATE NO. 4 - PROVIDE ALL MATERIALS AND LABOR TO INSPECT, TEST, AND CERTIFY OPERATION OF FIRE DAMPER IN ACCORDANCE WITH NFPA 80 REQUIREMENTS. PROVIDE WRITTEN REPORT AFTER TESTING

26.300 ALTERNATE NO. 1 - DISCONNECT AND PROTECT EXISTING BRANCH CIRCUITRY TO ELECTRIC DUCT HEATER TO BE REPLACED. EXTEND BRANCH CIRCUITRY AND PROVIDE NEW ELECTRICAL CONNECTION TO ELECTRIC DUCT HEATER. DISCONNECT PROVIDED WITH UNIT. MATCH EXISTING.


26.301 DISCONNECT AND PROTECT EXISTING BRANCH CIRCUITRY TO ELECTRIC UNIT HEATER TO BE REPLACED. EXTEND BRANCH CIRCUITRY AND PROVIDE NEW ELECTRICAL CONNECTION TO ELECTRIC UNIT HEATER. DISCONNECT

PROVIDED WITH UNIT. MATCH EXISTING. 26.304 ALTERNATE NO. 3 - PROVIDE UNIT PRICING TO DISCONNECT AND PROTECT EXISTING BRANCH CIRCUITRY TO UNIT HEATER TO BE REPLACED. EXTEND BRANCH CIRCUITRY TO NEW ELECTRIC UNIT HEATER TO ENSURE A

COMPLETE AND OPERATIONAL SYSTEM. 26.400 REMOVE EXISTING LUMINAIRE AND TEMPORARILY SUPPORT FOR REPLACEMENT OF DUCTWORK. REINSTALL

COMPLETE.


LUMINAIRE IN EXISTING LOCATION TO ENSURE A COMPLETE AND OPERATIONAL SYSTEM.

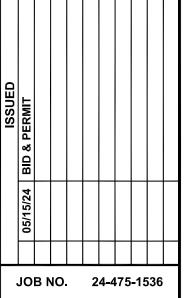


DRAWN KJD\ATR CHECKED BWG\MTK APPROVED BWG\MTK SHEET TITLE

FIRST FLOOR MECHANICAL PLAN AND DETAILS

SHEET NUMBER

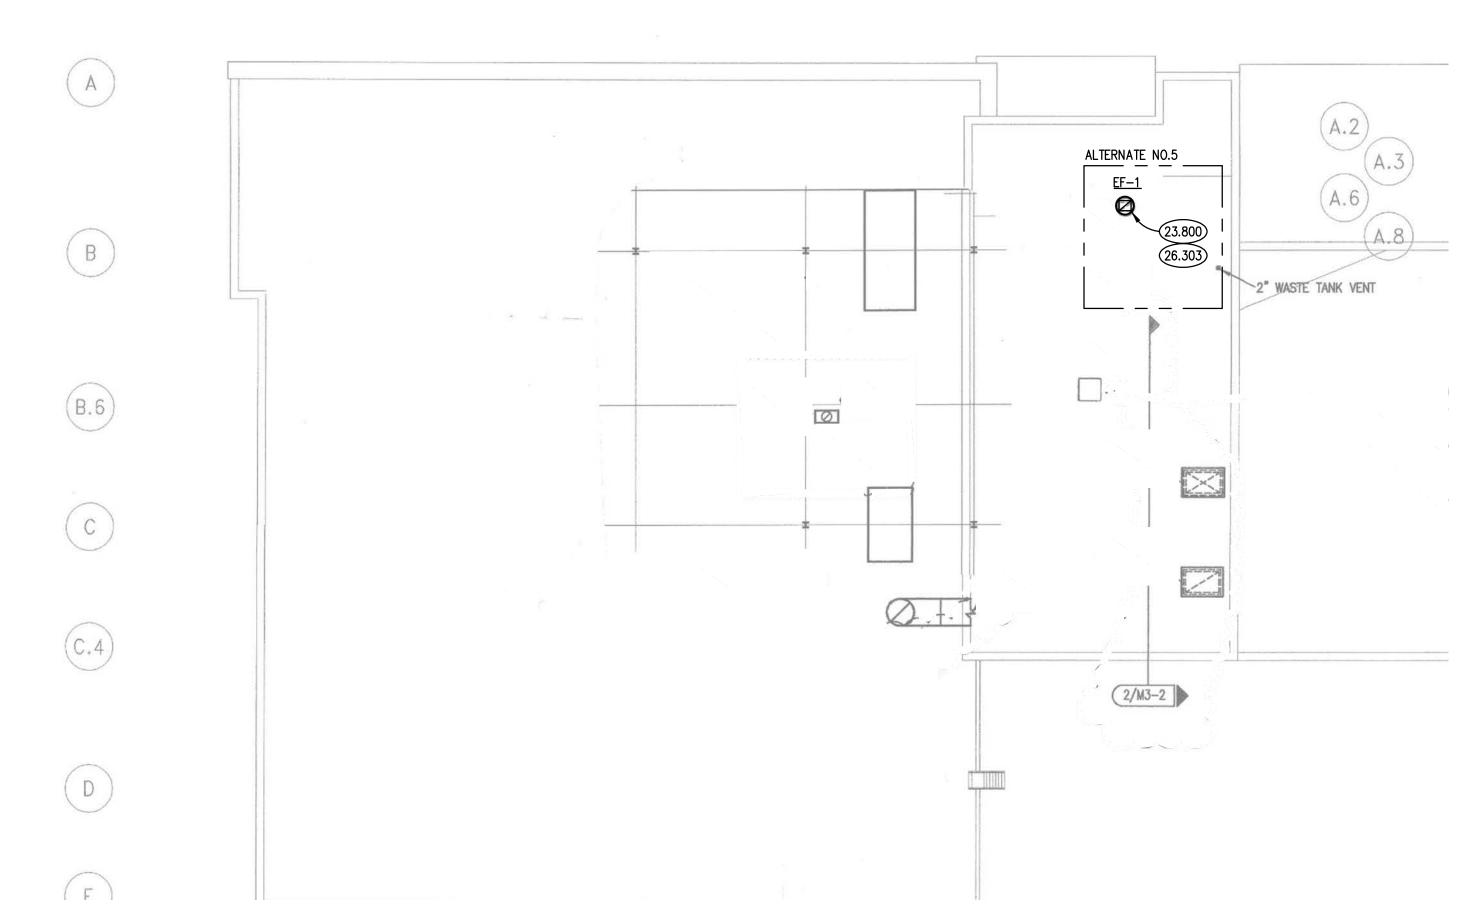

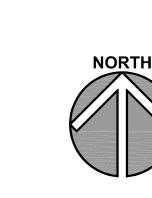

SCALE: 1/16" = 1'-0"

SECOND FLOOR HEATING PLAN SCALE: 1/16" = 1'-0"

**MECHANICAL GENERAL NOTES** 

1. REFER TO DRAWING G100 FOR PROJECT GENERAL NOTES.

COMPLY WITH UL 181B AND MARKED ACCORDINGLY.

ALL DUCTWORK ARE SHOWN DIAGRAMMATICALLY AND DO NOT SHOW ALL REQUIRED FITTINGS, OFFSETS, DROPS AND RISES. THE CONTRACTOR IS RESPONSIBLE TO PROVIDE ALL MATERIAL AND LABOR FOR A COMPLETE AND WORKING SYSTEM. COORDINATE WITH OTHER TRADES FOR SPACE AVAILABLE AND RELATIVE LOCATIONS OF EQUIPMENT, PIPING,

- EXISTING DUCTWORK INDICATED ON THESE PLANS SHALL BE FIELD VERIFIED FOR EXACT LOCATIONS, QUANTITY AND
- 4. ALL TAPES AND MASTICS USED TO SEAL DUCTWORK LISTED AND LABELED IN ACCORDANCE WITH UL 181A SHALL BE MARKED ACCORDINGLY. ALL TAPES AND MASTICS USED TO SEAL FLEXIBLE DUCTS AND AIR CONNECTORS SHALL
- 5. SPACE ALLOCATION, COORDINATION WITH ELECTRICAL, ARCHITECTURAL & OTHER MECHANICAL COMPONENTS HAVE BEEN MADE WITH RESPECT TO ALL EQUIPMENT SCHEDULED ON THESE DRAWINGS AND IN THE SPECIFICATIONS OF THE FIRST NAMED MANUFACTURER ONLY. OTHER MANUFACTURERS ARE ACCEPTABLE PROVIDED THEY MEET
- 6. OBTAIN AND PAY ALL COSTS FOR PERMITS, LICENSES, CERTIFICATE FILING AND ALL INSPECTIONS BY AUTHORITIES HAVING JURISDICTION.

PERFORMANCE REQUIREMENTS AND AFOREMENTIONED COORDINATION.

**KEYNOTES** 

KEYNOTES ARE TYPICALLY NOT DUPLICATED WITHIN A GIVEN DETAIL. AN UN-KEYNOTED ITEM IN A DETAIL IS THE SAME AS A KEYNOTED ITEM HAVING THE SAME APPEARANCE WITHIN THE SAME DETAIL.

23.303 REMOVE UNIT HEATER AND PROVIDE NEW UNIT HEATER. MAINTAIN ALL CLEARANCES AROUND UNIT HEATER FOR SERVICING. PROVIDE NEW MOUNTING EQUIPMENT AS REQUIRED. INSTALL IN ACCORDANCE WITH MANUFACTURER'S

PARTIAL ROOF MECHANICAL PLAN


23.700 ALTERNATE NO. 4 - PROVIDE ALL MATERIALS AND LABOR TO INSPECT, TEST, AND CERTIFY OPERATION OF FIRE DAMPER IN ACCORDANCE WITH NFPA 80 REQUIREMENTS. PROVIDE WRITTEN REPORT AFTER TESTING

23.800 ALTERNATE NO. 5 - REMOVE EXISTING EXHAUST FAN AND PROVIDE NEW EXHAUST FAN. PROVIDE ANY MODIFICATIONS TO CURB AS REQUIRED TO INSTALL EXHAUST FAN ON EXISTING CURB. PROVIDE ALL MATERIALS AND LABOR TO INSTALL NEW MOTORIZED BACKDRAFT DAMPER IN EXISTING CURB.

26.301 DISCONNECT AND PROTECT EXISTING BRANCH CIRCUITRY TO ELECTRIC UNIT HEATER TO BE REPLACED. EXTEND BRANCH CIRCUITRY AND PROVIDE NEW ELECTRICAL CONNECTION TO ELECTRIC UNIT HEATER. DISCONNECT

PROVIDED WITH UNIT. MATCH EXISTING. 26.303 ALTERNATE NO. 5 - DISCONNECT AND PROTECT EXISTING BRANCH CIRCUITRY TO EXHAUST FAN TO BE REPLACED. EXTEND BRANCH CIRCUITRY AND PROVIDE NEW ELECTRICAL CONNECTION TO EXHAUST FAN. DISCONNECT

PROVIDED WITH UNIT. MATCH EXISTING.

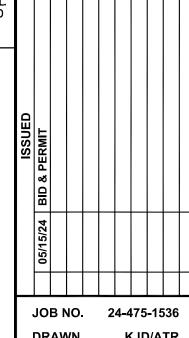

DRAWN KJD/ATR CHECKED BWG/MTK APPROVED BWG/MTK SHEET TITLE

SECOND FLOOR MECHANICAL PLAN & PARTIAL ROOF **MECHANICAL PLAN** 

SHEET NUMBER

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JOB NO. 24-475-1536

SHEET TITLE

**MECHANICAL** SCHEDULES AND

**DETAILS** 

SHEET NUMBER

DRAWN

CHECKED APPROVED

BASE BID - ELECTRIC UNIT HEATER SCHEDULE												
MARK	AIR FLOW RATE (CFM)	MIN CAPACITY (KW)	AIR TEMP RISE (° F)	SUPPLY FAN (HP)	ELECTRICAL (V/PH/HZ)	FULL LOAD AMPS	MODEL	AREA SERVED	NOTES			
EUH-7	350	5	45	1/100	277/1/60	18	HUHAA527	RM 022	1, 2, 3, 5			
EUH-9	2100 / 1800	25	38 / 44	1/4	480/3/60	30	HUHAA2548	RM 001	1, 2, 3, 5			
EUH-13	2100 / 1800	25	38 / 44	1/4	480/3/60	30	HUHAA2548	RM 103	1, 2, 3, 4			
EUH-14	700	7.5	34	1/4	480/3/60	9	BWD07432	RM 109	1, 2, 3, 5			
EUH-22	650	7.5	37	1/30	480/3/60	9	HUHAA748	RM 251	1, 2, 3, 4			
EUH-23	350	5	45	1/100	480/3/60	6	HUHAA548	RM 106	1, 2, 3, 5			
CUH-1	250	2	25	1/8	480/3/60	3	CUH935	RM 0S2	1, 2, 3, 4, 6			
CUH-2	250	2	25	1/8	480/3/60	3	CUH935	RM OS1	1, 2, 3, 4, 6			
NOTES  1. MODEL BASED ON BERKO. 2. PROVIDE POWER DISCONNECT SWTICH. 3. PROVIDE INTERNAL THERMOSTAT. 4. PROVIDE CEILING MOUNTING BRACKETS. 5. PROVIDE WALL SWIVEL MOUNTING BRACKETS. 6. COLOR TO BE SELECTED BY THE ARCHITECT.												
A	ALTERNATE NO. 3 - ELECTRIC UNIT HEATER SCHEDULE											

MARK	AIR FLOW RATE (CFM)	MIN CAPACITY (KW)	AIR TEMP RISE (° F)	SUPPLY FAN (HP)	ELECTRICAL (V/PH/HZ)	FULL LOAD AMPS	MODEL	AREA SERVED	NOTES
:UH-1	2100 / 1800	25	38 / 44	1/4	480/3/60	30	HUHAA2548	RM 001	1, 2
:UH-2	2100 / 1800	25	38 / 44	1/4	480/3/60	30	HUHAA2548	RM 001	1, 2
:UH-3	2100 / 1800	25	38 / 44	1/4	480/3/60	30	HUHAA2548	RM 001	1, 2
:UH-4	2100 / 1800	25	38 / 44	1/4	480/3/60	30	HUHAA2548	RM 001	1, 2
:UH-5	2100 / 1800	25	38 / 44	1/4	480/3/60	30	HUHAA2548	RM 005	1, 2
:UH-6	2100 / 1800	25	38 / 44	1/4	480/3/60	30	HUHAA2548	RM 001	1, 2
:UH-7	350	5	45	1/100	277/1/60	18	HUHAA527	RM 022	1, 2
:UH-8	2100 / 1800	25	38 / 44	1/4	480/3/60	30	HUHAA2548	RM 004	1, 2
:UH-9	2100 / 1800	25	38 / 44	1/4	480/3/60	30	HUHAA2548	RM 001	1, 2
:UH-10	350	5	45	1/100	277/1/60	18	HUHAA527	RM 120	1, 2
:UH-11	350	5	45	1/100	277/1/60	18	HUHAA527	RM 129	1, 2
:UH-12	350	5	45	1/100	277/1/60	18	HUHAA527	RM 129	1, 2
:UH-13	2100 / 1800	25	38 / 44	1/4	480/3/60	30	HUHAA2548	RM 103	1, 2
:UH-14	485	7.5	46	1/5	480/3/60	9	TUW7548TLS	RM 109	1, 2
:UH-15	2100 / 1800	25	38 / 44	1/4	480/3/60	30	HUHAA2548	RM 103	1, 2
:UH-16	650	7.5	37	1/30	480/3/60	9	HUHAA748	RAMP	1, 2
:UH-17	650	7.5	37	1/30	480/3/60	9	HUHAA748	RAMP	1, 2
:UH-18	2100 / 1800	25	38 / 44	1/4	480/3/60	30	HUHAA2548	RAMP	1, 2
:UH-19	2100 / 1800	25	38 / 44	1/4	480/3/60	30	HUHAA2548	RM 103	1, 2
:UH-20	2100 / 1800	25	38 / 44	1/4	480/3/60	30	HUHAA2548	RM 103	1, 2
:UH-21	2100 / 1800	25	38 / 44	1/4	480/3/60	30	HUHAA2548	RM 106A	1, 2
UH-22	650	7.5	37	1/30	480/3/60	9	HUHAA748	RM 251	1, 2
:UH-23	350	5	45	1/100	480/3/60	6	HUHAA548	RM 106	1, 2
:UH-24	2100 / 1800	25	38 / 44	1/4	480/3/60	30	HUHAA2548	RM 106A	1, 2
:UH-25	650	7.5	37	1/30	480/3/60	9	HUHAA748	RM 001	1, 2
:UH-26	485	7.5	46	1/5	480/3/60	9	TUW7548TLS	RM 109	1, 2
UH-27	350	5	45	1/100	277/1/60	18	HUHAA527	RM 120	1, 2
UH-1	250	2	25	1/8	480/3/60	3	CUH935	RM 0S2	1, 2
UH-2	250	2	25	1/8	480/3/60	3	CUH935	RM OS1	1, 2
CUH-3	500	8	51	1/8	480/3/60	11	CUH945	RM 126	1, 2
CUH-4	500	10	63	1/8	480/3/60	13	CUH945	RM 101	1, 2
CUH-5	500	10	63	1/8	480/3/60	13	CUH945	RM 1S1	1, 2
CUH-6	250	2	25	1/8	480/3/60	3	CUH935	RM 1S2	1, 2
CUH-7	250	2	25	1/8	480/3/60	3	CUH935	RM 107	1, 2
CUH-8	250	4	51	1/8	480/3/60	6	CUH935	RM 1S3	1, 2

 MODEL BASED ON BERKO. 2. FOR INFORMATION PURPOSES ONLY

### ALIERMATE NO. 3 - LELOTRIO ONTI TIEATER COTEDULE

MARK	AIR FLOW RATE (CFM)	MIN CAPACITY (KW)	AIR TEMP RISE (° F)	SUPPLY FAN (HP)	ELECTRICAL (V/PH/HZ)	FULL LOAD AMPS	MODEL	AREA SERVED	NOTES
EUH-A	350	5	45	1/100	277/1/60	18	HUHAA527	VARIES	1, 2, 3, 4
EUH-B	650	7.5	37	1/30	480/3/60	9	HUHAA748	VARIES	1, 2, 3, 4
EUH-C	2100 / 1800	25	38 / 44	1/4	480/3/60	30	HUHAA2548	VARIES	1, 2, 3, 4
EUH-D	700	7.5	34	1/4	480/3/60	9	BWD07432	VARIES	1, 2, 3,
CUH-A	250	2	25	1/8	480/3/60	3	CUH935	VARIES	1, 2, 3,
CUH-B	250	4	51	1/8	480/3/60	6	CUH935	VARIES	1, 2, 3, 5
CUH-C	500	8	51	1/8	480/3/60	11	CUH945	VARIES	1, 2, 3,
CUH-D	500	10	63	1/8	480/3/60	13	CUH945	VARIES	1, 2, 3,

1. MODEL BASED ON BERKO. PROVIDE POWER DISCONNECT SWTICH.
 PROVIDE INTERNAL THERMOSTAT.

4. PROVIDE REQUIRED MOUNTING BRACKETS.

5. COLOR TO BE SELECTED BY THE ARCHITECT. 6. PROVIDE UNIT PRICING FOR REPLACEMENT OF EACH TYPE OF HEATER SCHEDULED ABOVE. PRICING SHALL INCLUDE ALL MATERIALS AND LABOR TO REMOVE EXISTING UNIT HEATER AND INSTALL NEW UNIT HEATER.

MARK	AIR FLOW RATE (CFM)	EXTERNAL S.P. (IN WG)	DRIVE TYPE	MOTOR (HP)	ELECTRICAL (V/PH/HZ)	FAN ENERGY INDEX (FEI)	AREA SERVED	LOCATION	MODEL	NOTES
EF-1	2215	1.25	BELT	3/4	460/3/60	N/A	-	ROOF	ACE-B	1, 2, 3, 4

**ALTERNATE NO. 5 - FAN SCHEDULE** 

MODEL BASED ON LOREN COOK.
 SERVES LOWER LEVEL LOCKER ROOMS, RESTROOMS, AND FIRST LEVEL RESTROOMS.
 PROVIDE POWER DISCONNECT SWITCH.
 PROVIDE NEW MOTORIZED BACKDRAFT DAMPER.

# ALTERNATE NO. 1 ELECTRIC DUCT HEATER SCHEDULE

MARK	AIR FLOW RATE (CFM)	MIN CAPACITY (KW)	STAGES	EAT / LAT (° F / °F)	AIR TEMP RISE (° F)	DUCT SIZE (W X H)	ELECTRICAL (V/PH/HZ)	FULL LOAD AMPS	MODEL	AREA SERVED	LOCATION	NOTES
EDH-1	3,200	21	SCR	55 / 75	20	48 X 24	480/3/60	25.2	MSC	ERU-1	FLEET GARAGE	1, 2, 3, 4


MODEL BASED ON THERMOLEC.
 PROVIDE WITH DOOR INTERLOCKING DISCONNECT SWITCH AND BUILT-IN AIRFLOW SENSOR.
 WALL MOUNTED THERMOSTAT.

4. GASKETED CONTROL BOX.

FUSIBLE LINK(e) — REMOVABLE DUCT SECTION ─ S-CLIP(e) (PROVIDE CONNECTION PERMITTED AS A CONDITION OF THE DAMPER FIRE RATED WALL(e)

PROVIDE ACCESS PANELS FOR INSPECTION AND MAINTENANCE OF DAMPER. PROVIDE NAMEPLATE WITH MINIMUM 1/2" TALL LETTERING IDENTIFYING "FIRE DAMPER".

WALL FIRE DAMPER DETAIL SCALE: NTS 2

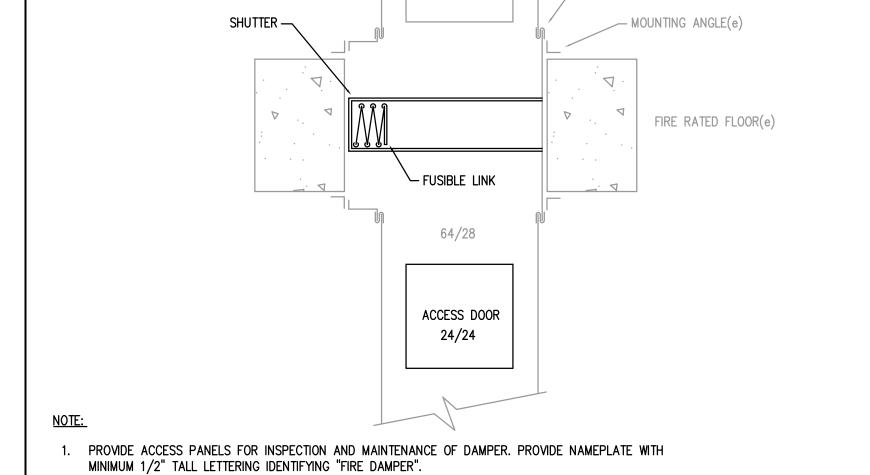

ACCESS DOOR(e)

FLOOR FIRE DAMPER DETAIL (1)

(PROVIDE CONNECTION PERMITTED AS A CONDITION OF THE DAMPER